

PROJECT PLANS



3D VIEW OF SW CORNER



3D VIEW OF SE CORNER



3D VIEW OF ENTRANCE

PARKING ANALYSIS

REQUIRED PARKING	
1 BEDROOMS	1/UNIT
2 BEDROOM	1/UNIT
EV SPOTS	10% OF TOTAL
ACCESSIBLE	5% UNASSIGNED 2% ASSIGNED


PARKING ANALYSIS:
107 x 1 UNITS = 107 PARKING SPOTS

TOTAL REQUIRED 107 SPOTS

PARKING SPOTS PROVIDED = 92
ACCESSIBLE SPOTS PROVIDED = 6
EV PARKING SPOTS PROVIDED = 11

TOTAL PARKING PROVIDED = 109

VICINITY MAP

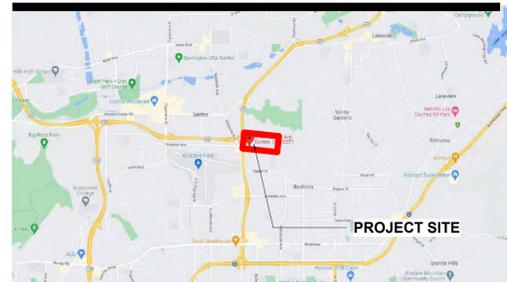

UNIT TYPES

UNIT SCHEDULE:

NAME	TYPE	# OF COMPLYING BATHROOMS	UNIT SF	COUNT
UNIT 1A	1 BED/1 BATH	1	850	25
UNIT 1B	1 BED/1 BATH	1	740	20
UNIT 1C	1 BED/1 BATH	1	660	10
UNIT 2A	2 BED/2 BATH	2	1180	20
UNIT 2B	2 BED/2 BATH	2	1030	20
UNIT PH1A	1 BED/1 BATH	1	1100	3
UNIT PH2A	2 BED/2 BATH	2	1525	3
UNIT PH3A	2 BED/1 DEN/ 2 BATH	2	1800	2
UNIT STA	STUDIO	1	580	4

TOTAL PROJECT UNITS: 107

THIS PROJECT INCLUDES A DENSITY BONUS ESTABLISHED PURSUANT TO SECTION 65915 ET SEQ OF THE GOVERNMENT CODE

SCOPE OF WORK

PROJECT DESCRIPTION:

THE PROJECT INCLUDES:

1) BUILDING A NEW 5 STORY SENIOR APARTMENTS OVER BASEMENT (TOTAL 107 UNITS) LEVEL 6 WILL INCLUDE A BAR/LOUNGE & SHARED KITCHEN WITHIN THE LISTED SF

2) PERFORM SITE WORK TO PROVIDE SIDEWALKS, SITE PARKING, LANDSCAPING, SITE UTILITY WORK, AND OTHER MISC ITEMS NECESSARY FOR THE PROPOSED BUILDING TO OPERATE.

DRAWING LIST

SHEET	TITLE	SHEET	TITLE
A-0.1	ZONING SUMMARY	A-3.1	FRONT ELEVATION
A-0.2	3D VIEWS	A-3.2	FRONT ELEVATION
A-0.3	GREEN CODE	A-3.3	REAR ELEVATION
A-1.1	SITE PLAN - PARKING	A-3.4	REAR ELEVATIONS
A-2.1	LEVEL 1 BASEMENT	A-4.1	BUILDING SECTIONS
A-2.2	LEVEL 2	A-5.1	MATERIAL BOARD
A-2.3	LEVEL 3		
A-2.4	LEVEL 4		
A-2.5	LEVEL 5		
A-2.6	LEVEL 6		
A-2.7	ROOF PLAN		
A-2.8	UNIT FLOOR PLANS		
A-2.9	UNIT FLOOR PLANS		
A-2.10	UNIT FLOOR PLANS		
A-2.11	UNIT FLOOR PLANS		
A-2.12	UNIT FLOOR PLANS		

PROJECT TEAM

OWNER

SANTEE SENIOR RETIREMENT COMMUNITIES, LLC
SANTEE, CA 92071
PHONE: 619.444.2504
PRINCIPAL: MICHAEL GRANT
EMAIL: GRANT.MICHAEL@SBCGLOBAL.NET

ARCHITECT

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CIVIL

REC-CONSULTANTS
PHONE: 619.326.6017

PRINCIPAL: RAAB RYDEEN, PE
E-MAIL: RAAB@REC-CONSULTANTS.COM

LANDSCAPE

PROJECT SUMMARY

BUILDING AREA: ALLOWED:
R-2 (RESIDENTIAL FLOORS):
96,000 SF PER FLOOR TYPE 3A

PROPOSED:
TOTAL BUILDING AREA:
BASEMENT LEVEL 17,156 SQFT
SECOND LEVEL 25,424 SQFT
THIRD LEVEL 25,424 SQFT
FOURTH LEVEL 25,424 SQFT
FIFTH LEVEL 25,424 SQFT
SIXTH LEVEL 19,297 SQFT
= TOTAL BUILDING 138,149 SQFT

PROJECT ADDRESS:
200 LANTERN CREST WAY
SANTEE, CA 92071

LEGAL DESCRIPTION:

APN: 384-140-15-00 CITY OF SANTEE
APN: 384-140-16-00 COUNTY OF SAN DIEGO
APN: 384-140-17-00 STATE OF CALIFORNIA

ZONE: R14 / R22 HIGH DENSITY RESIDENTIAL

PROPOSED USE/PERMIT TYPE:
NEW BUILDING TO BE AN APARTMENT COMPLEX FOR SENIOR INDEPENDENT LIVING

OCCUPANCY CLASSIFICATION: R2 - MULTI FAMILY

TOTAL LOT AREA: 9.6 ACRES / 415,785 SF

PROPOSED SET BACK: PER R-22 SANTEE ZONING

FRONT: 10'-0"
REAR: 10'-0"
SIDE 1: 10'-0"
SIDE 2: 10'-0"

MAXIMUM LOT COVERAGE: 70% OR 291,049 SF
PROPOSED LOT COVERAGE: 25,555 SF BUILDING FOOTPRINT LC4
43,000 SF BUILDING FOOTPRINT LC3
13,635 SF PARKING LOT
13,110 SF SITE SIDEWALK
104,100 SF PRIVATE SIDE STREET
199,400 SF TOTAL LOT COVERAGE

BUILDING TYPE: 4 LEVELS TYPE VA OVER 2 LEVELS TYPE 1A

HEIGHT: ALLOWED PER CBC TABLE 504.3:
85'-0" ABOVE AVERAGE GRADE PLANE
PROPOSED:
64'-3" ABOVE AVERAGE GRADE PLANE
(82'-0" FOR TOWER)

STORIES: ALLOWED: 5 OVER GRADE PLANE
PROPOSED: 5 STORIES OVER BASEMENT

UNITS: 107 UNITS



PROJECT NORTH



SEALS AND SIGNATURES

Todd B.
SPIEGEL
architects

699 Hampshire Road #218
Westlake Village, CA 818.879.6175

BUILDING 4
200 LANTERN CREST WAY
SANTEE, CA 92071

Issued for	Rev	Date
PLANNING SET	1	08/23/22
PLANNING SET		07/28/22
CLIENT REVIEW		03/30/22
ISSUE		

DRAWING TITLE	
ZONING SUMMARY	
SCALE	
PROJECT NUMBER	2119
PLOT DATE	8/23/2022 6:20:57 PM
DRAWING #	A0.1

WATER CONSERVATION NOTES - RESIDENTIAL BUILDINGS

PLUMBING SYSTEM

- Multi-family dwellings not exceeding three stories and containing 50 units or less shall install a separate meter or submeter within common areas and within each individual dwelling unit. (4.303.3)
 - Water use reduction shall be met by complying with one of the following:
 - Provide a 20% reduction in the overall potable water use within the building. The reduction shall be based on the maximum allowable water use for plumbing fixtures and fittings as required by the Los Angeles Plumbing Code. Calculations demonstrating a 20% reduction in the building "water use baseline," as established in Table 4.303.4.1, shall be provided; or
 - New fixtures and fittings shall comply with the maximum flow rates shown in Table 4.303.4.2, or
 - Plumbing fixtures shall use recycled water. **Exception:** Fixture replacements. (4.303.4)
 - New building on a site with 500 square feet or more of cumulative landscape area shall have separate meters or submeters for outdoor water use. (4.304.3)
 - Additions and alterations on a site with 500 square feet or more of cumulative landscape area and where the entire potable water system is replaced, shall have separate meters or submeters for outdoor water use. (4.304.3)
 - In other than single family dwellings, locks shall be installed on all publicly accessible exterior faucets and hose bibs. (4.304.4)
 - Provide a cover having a manual or power-operated reel system in any permanently installed outdoor irrigation system pool or spa in one- and two-family dwellings. For irregular-shaped pools where it is infeasible to cover 100% of the pool due to its irregular shape, a minimum of 80% of the pool shall be covered. (4.304.5)
 - Except as provided in this section, for sites with over 500 square feet of landscape area, alternate waste piping shall be installed to permit discharge from the clothes washer, bathtub, showers, and bathroom restrooms wash basins to be used for a future graywater irrigation system. (4.305.1)
 - Except as provided in this section, where City-recycled water is available within 200 feet of the property line, water closets, urinals, floor drains, and process cooling and heating in the building shall be supplied from recycled water and shall be installed in accordance with the Los Angeles Plumbing Code. (4.305.2)
- In new buildings of 25 stories or less, the cooling towers shall comply with one of the following:
 - Shall have a minimum of 6 cycles of concentration (blowdown); and
 - A minimum of 50% of the makeup water supply to the cooling towers shall come from non-potable water sources, including treated backwash. (4.305.3.1)
 - In new buildings over 25 stories, the cooling towers shall comply with all of the following:
 - Shall have a minimum of 6 cycles of concentration (blowdown); and
 - 100% of the makeup water supply to the cooling towers shall come from non-potable water sources, including treated backwash. (4.305.3.2)
 - Where groundwater is being extracted and discharged, develop and construct a system for onsite reuse of the groundwater. Alternatively, the groundwater may be discharged to the sewer. (4.305.4)
 - Provide a hot water system complying with one of the following (Los Angeles Plumbing Code Section 610.4.1):
 - The hot water system shall not allow more than 0.5 gallons of water to be delivered to any fixture before hot water arrives.
 - Where a hot water recirculation or electric resistance heat trace wire system is installed, the branch from the recirculating loop or electric resistance heat trace wire to the fixture shall contain a maximum of 0.6 gallons.
 - Residential units having individual water heaters shall have a compact hot water system that meets all of the following:
 - The hot water supply piping from the water heater to the fixtures shall take the most direct path.
 - The total developed length of pipe from the water heater to farthest fixture shall not exceed the distances specified in Table 3.6.5 of the California Energy Code Residential Appendix.
 - The hot water supply piping shall be installed and insulated in accordance with Section RA3.6.2 of the California Energy Code Residential Appendix.

IRRIGATION SYSTEM

- A water budget for landscape irrigation use that conforms to the California Department of Water Resources' Model Water Efficient Landscape Ordinance (MWELO) is required for new landscape areas of 500 sq. ft. or more. The following methods to reduce potable water use in landscape areas include, but are not limited to, use of captured rainwater, recycled water, gray water, or water treated for irrigation purposes and conveyed by a water district or public entity. (4.304.1)

Storm Water Pollution Control Requirements for Construction Activities Minimum Water Quality Protection Requirements for All Construction Projects.

The following notes shall be incorporated in the approved set of construction/grading plans and represents the minimum standards of good housekeeping which must be implemented on all construction projects.

Construction means constructing, clearing, grading or excavation that result in soil disturbance. Construction includes structure teardown (demolition). It does not include routine maintenance to maintain original line and grade, hydraulic capacity, or original purpose of facility; emergency construction activities required to immediately protect public health and safety; interior remodeling with no outside exposure of construction material or construction waste to storm water; mechanical permit work; or sign permit work. (Order No. 01-182, NPDES Permit No. CAS004001 - Part 5; Definitions)

- Eroded sediments and pollutants shall be retained on site and shall not be transported from the site via sheet flow, swales, area drains, natural drainage or wind.
- Stockpiles of earth and other construction-related materials shall be covered and/or protected from being transported from the site by wind or water.
- Fuels, oils, solvents and other toxic materials must be stored in accordance with their listing and shall not contaminate the soil nor the surface waters. All approved toxic storage containers are to be protected from the weather. Spills must be cleaned up immediately and disposed of properly and shall not be washed into the drainage system.
- Non-storm water runoff from equipment and vehicle washing and any other activity shall be contained on the project site.
- Excess or waste concrete may not be washed into the public way or any drainage system. Provisions shall be made to retain concrete waste on-site until it can be appropriately disposed of or recycled.
- Trash and construction-related solid wastes must be deposited into a covered receptacle to prevent contamination of storm water and dispersal by wind.
- Sediments and other materials shall not be tracked from the site by vehicle traffic. The construction entrance roadways must be stabilized so as to inhibit sediments from being deposited into the street/public ways. Accidental depositions must be swept up immediately and may not be washed down by rain or by any other means.
- Retention basins of sufficient size shall be provided to retain storm water runoff on-site and shall be properly located to collect all tributary site runoff.
- Where retention of storm water runoff on-site is not feasible due to site constraints, runoff may be conveyed to the street and the storm drain system provided that an approved filtering system is installed and maintained on-site during the construction duration.

GREEN BUILDING CODE PLAN CHECK NOTES RESIDENTIAL BUILDINGS

- For each fire dwelling and firehouse, provide a listed means that can accommodate a dedicated 200-240 volt branch circuit. The receptacle shall not be less than trade size 1 (nominal 1 inch inside diameter), shall originate at the main service or subpanel and shall terminate into a listed cabinet, box or other enclosure in close proximity to the proposed location of an EV charger. The panel or subpanel shall provide capacity to install a 40-ampere minimum dedicated branch circuit and space(s) reserved for permit installation of a branch circuit overcurrent protective device. The service panel or subpanel circuit directory shall identify the overcurrent protective device space(s) reserved for future EV charging as "EV CAPABLE." The necessary termination location shall be permanently and visibly marked as "EV CAPABLE." (4.106.4.1)
- For common parking areas serving 10 occupancies, the electrical system shall have sufficient capacity to simultaneously charge all designated EV spaces at the full rated amperage of the Electric Vehicle Supply Equipment (EVSE). Design shall be based upon a 40-ampere minimum branch circuit. The necessary shall not be less than trade size 1 (nominal 1 inch inside diameter), shall originate at the main service or subpanel and shall terminate into a listed cabinet, box or other enclosure in close proximity to the proposed location of an EV charger. Raceways and related components that are planned to be installed underground, overhead, inaccessible or in concealed areas and space(s) reserved for future EV charging purposes as "EV CAPABLE" in accordance with the Los Angeles Electrical Code. (4.106.4.2)
- Roofs with slopes < 2:12 shall have a 3-year aged SRI value of at least .75 or better a 3-year aged solar reflectance of at least 0.63 and a thermal emittance of at least 0.75. Roofs with slopes > 2:12 shall have an aged SRI value of at least 16 and a 3-year aged solar reflectance of at least 0.20 and a thermal emittance of at least 0.75. (4.106.5)
- The required landscape asset to reduce heat island effects shall have a solar reflectance value of at least 0.50 as determined per ASTM E1918 or ASTM C1549. (4.106.7)
- The flow rates for all plumbing fixtures shall comply with the maximum flow rates in Section 4.303.1. (4.302.1)
- When a shower is covered by more than one showerhead, the combined flow rate of all the showerheads controlled by a single valve shall not exceed 2.0 gallons per minute at 80psi, or the shower shall be designed to only allow one showerhead to be in operation at a time. (4.303.1.3.2)
- Installed automatic irrigation system controllers shall be weather- or well-located controllers. (MWELO, § 492.7)
- For projects that include landscape work, the Landscape Certification Form (GRN 12) shall be completed prior to final inspection approval. (State Assembly Bill No. 888)
- Annular spaces around pipes, electric cables, conduits or other openings in the building's envelope or exterior walls shall be protected against the passage of rodents by closing such openings with cement mortar, concrete masonry, or metal plates. Piping penetrations to exterior shall be protected in accordance with Section 312.3 of the Los Angeles Plumbing Code. (4.400.1)
- Materials delivered to the construction site shall be protected from rain or other sources of moisture. (4.401.4)
- Only a City of Los Angeles permitted liner will be used for lining of construction work. (4.401.1)
- For all new equipment, an Operation and Maintenance Manual including, at a minimum, the items listed in Section 4.410.1, shall be completed and placed in the building at the time of final inspection. (4.410.1)
- All new gas fireplaces must be direct-vent, sealed combustion type. Wood-burning fireplaces are prohibited per AQMD Rule 442. (4.500.1, AQMD Rule 442)
- All duct and other related air distribution component openings shall be covered with tape, caulk, or sheet metal and the final status of the heating, cooling and ventilating equipment. (4.504.1)
- Paints and coatings, adhesives, caulks and sealants shall comply with the Volatile Organic Compound (VOC) limits listed in Table 4.504.1-4.504.3.
- The VOC Content Verification Checklist Form GRN 2, shall be completed and verified prior to final inspection approval. The manufacturer's specifications showing VOC content for all applicable products shall be readily available at the job site and be provided to the field inspector for verification. (4.504.2.4)
- All new carpet and carpet cushions installed in the building interior shall meet the testing and product requirements of one of the following (4.504.3):
 - Carpet and Carpet Institute's Green Label Plus Program
 - California Department of Public Health's Specification 01350
 - NSF ANSI 140 at the Gold level
 - Scientific Certification Systems Indoor Advantage™ Gold
- 80% of the total area receiving resilient flooring shall comply with one or more of the following (4.504.4):
 - VOC emissions limits defined in the CHPS High Performance Products Database
 - Certified under LA GREENGUARD Gold
 - Certification under the Resilient Floor Covering Institute (RFCI) FloorScore program
 - Meet the California Department of Public Health's Specification 01350
- New hardwood plywood, particle board, and medium density fiberboard composite wood products used in the building shall meet the formaldehyde limits listed in Table 4.504.5. (4.504.5)
- The Formaldehyde Emissions Verification Checklist Form GRN 3, shall be completed prior to final inspection approval. (4.504.6)
- Mechanically ventilated buildings shall provide regularly scheduled access of the building with a MERV 13 filter for outdoor and return air. Filters shall be installed prior to occupancy and recommendations for maintenance with filters of the same value shall be included in the operation and maintenance manual. (4.504.6)
- A 4-inch thick base of 1/2 inch or larger rigid aggregate shall be provided for proposed slab on grade construction. A vapor barrier shall be provided in direct contact with concrete for proposed slab on grade construction. (4.505.2.1)
- Excavated conditions shall be protected against water damage shall not be installed. Wall and floor framing shall not be enclosed until it is inspected and found to be satisfactory. (4.505.3)
- Newly installed bathroom exhaust fans shall be ENERGY STAR compliant and be ducted to terminate to the outside of the building. Fans must be controlled by a humidistat which shall be readily accessible. Provide the manufacturer's cut-sheet for verification. (4.506.1)
- A copy of the construction documents or a comparable document indicating the information from Energy Code Sections 110.10(b) through 110.10(c) shall be provided to the occupant.* (Energy Code § 110.10(c)) (4.506.1)
- The heating and air-conditioning systems shall be sized and designed using ANS/ACCA Manual J-2004, ANS/ACCA 29-D-2009 or ASHRAE Handbook, and have their equipment selected to accordance with ANS/ACCA 26-S Manual S-2004. (4.507.2)

VOC CONTENT LIMITS FOR ARCHITECTURAL COATINGS ^{1,2}		FORMALDEHYDE LIMITS ³	
Limits of VOC per Liter of Coating, Less Water and Low VOC Exempt Compounds		Maximum Formaldehyde Emissions in Parts per Million	
COATING CATEGORY ^{1,2}	CURRENT LIMIT	PRODUCT	CURRENT VOC LIMIT
Clear coatings	50	Hardwood plywood interior core	0.05
Non-flammable coatings	50	Hardwood plywood composite core	0.05
Marble-top epoxy coatings	50	Particleboard	0.09
Specialty coatings	100	Medium density fiberboard	0.11
Barriers specialty coatings	400	Thin particleboard, density less than 0.8	0.13
Blumengrip roof coatings	80	* Values in this table are derived from those specified by the California Department of Public Health, California Department of Pesticide Regulation and the California Air Resources Board. For additional information see California Code of Regulations, Title 17, Section 65000 through 65250.1.	
Blumengrip roof primers	350	† The maximum quantity of formaldehyde emissions from a product is 0.05 mg/m ³ per hour.	
Bond breakers	350	SEALANT VOC LIMIT	
Concrete curing compounds	100	Less Water and Low VOC Exempt Compounds in Grams per Liter	
Concrete curing compounds, Roadways & Bridges	300	SEALANTS	CURRENT VOC LIMIT
Conformaldehyde sealers	100	Architectural	50
Driveway sealers	80	Marine deck	750
Driveway sealers	50	Marine cabin sole	300
Flux	50	Roadway	250
Flux free coatings	100	Single-ply roof membranes	450
Clear Top Coat	100	Other	420
Decorative Coatings	350	SEALANT PRIMERS	
Etchers	350	Architectural	250
Japan	350	Nonporous	775
Trowel Applied Coatings	50	Modified polyurethane 100	500
Epoxy resin coatings	150	Marine deck	750
Flux coatings	50	Other	750
Form-release compounds	100	ADHESIVE VOC LIMIT 1.2	
Graphic arts coatings (page panels)	200	Less Water and Low VOC Exempt Compounds in Grams per Liter	
High performance coatings	420	ARCHITECTURAL APPLICATIONS	CURRENT VOC LIMIT
Industrial maintenance coatings	100	Interior carpet adhesives	50
Low solids coatings	120	Carpet glue adhesives	50
Marble-top epoxy coatings	450	Outdoor carpet adhesives	150
Mastic lacquer coatings	100	Wood flooring adhesives	100
Metallic pigmented coatings	150	Resilient floor adhesives	80
Masonry coatings	250	Sulfuric adhesives	50
Preparation, epoxy primers	420	Carpet tile adhesives	50
Primers, sealers, and undercoats	100	UV1 and asphalt tile adhesives	50
Reactive penetrating sealers	350	Specialty adhesives	50
Resilient coatings	250	UV1 and asphalt tile adhesives	50
Road coatings	80	UV2 and asphalt tile adhesives	50
Road coatings, aluminum	100	UV3 and asphalt tile adhesives	50
Rust preventative coatings	100	UV4 and asphalt tile adhesives	50
Shellacs	730	UV5 and asphalt tile adhesives	50
Clear	450	Other adhesives not specifically listed	50
Opaque	500	SPECIALTY APPLICATIONS	
Specialty primers, sealers and undercoats	100	UV1, UV2, UV3, UV99, UV100	50
Stains	100	UV11	50
Stains, interior	250	UV12	50
Stains, consolidants	450	UV13	50
Swimming pool coatings	340	UV14	50
Traffic marking coatings	100	UV15	50
UV and UVB radiation coatings	420	UV16	50
Waterproofing membranes	100	UV17	50
Wood coatings	275	UV18	50
Wood preservatives	350	UV19	50
Zinc-rich primers	100	UV20	50

PLUMBING FIXTURE FLOW RATES

SECTION 4.303.1 WATER REDUCTION FIXTURE FLOW RATES

FIXTURE TYPE	MAXIMUM ALLOWABLE FLOW RATE
Showerheads	1.8 gpm @ 80 psi
Lavatory faucets, residential	1.2 gpm @ 60 psi ^{1,2}
Lavatory faucets, nonresidential	0.4 gpm @ 60 psi ^{1,3}
Kitchen faucets	1.5 gpm @ 60 psi ^{1,4}
Metering Faucets	0.2 gallons/cycle
Gravity tank type water closets	1.28 gallons/flush ⁵
Flushometer tank water closets	1.28 gallons/flush ⁵
Flushometer valve water closets	1.28 gallons/flush ⁵
Urinals	0.125 gallons/flush
Clothes Washers	ENERGY-STAR certified
Dishwashers	ENERGY-STAR certified

¹ Lavatory Faucets shall not have a flow rate less than 0.8 gpm at 20 psi
² Kitchen faucets may temporarily increase flow above the maximum rate, but not above 2.2 gpm @ 80psi and must default to a maximum flow rate of 1.8 gpm @ 80psi
³ Where complying faucets are unavailable, aerators or other means may be used to achieve reduction
⁴ Kitchen faucets with a maximum 1.8 gpm flow rate may be installed in buildings that have water closets with a maximum flush rate of 1.06 gallons/flush installed throughout.
⁵ Includes single and dual flush water closets with an effective flush of 1.28 gallons or less.
 Single Flush Toilets - The effective flush volume shall not exceed 1.28 gallons (4.8 liters). The effective flush volume is the average flush volume when tested in accordance with ASME A112.19.233.2.
 Dual Flush Toilets - The effective flush volume shall not exceed 1.28 gallons (4.8 liters). The effective flush volume is defined as the composite, average flush volume of two reduced flushes and one full flush. Flush volumes will be tested in accordance with ASME A112.19.2 and ASME A112.19.14.



SEALS AND SIGNATURES

Todd B. SPIEGEL architects


699 Hampshire Road #218 Westlake Village, CA 91381-6175

BUILDING 4
 200 LANTERN CREST WAY
 SANTEE, CA 92071

Issued for	Rev	Date	DRAWING TITLE
			GREEN CODE
			SCALE
			PROJECT NUMBER 2119
			PLOT DATE 8/23/2022 6:07:35 PM
			DRAWING #
PLANNING SET	1	08/23/22	A0.3
PLANNING SET		07/28/22	
CLIENT REVIEW		03/30/22	
ISSUE			



PROJECT NORTH

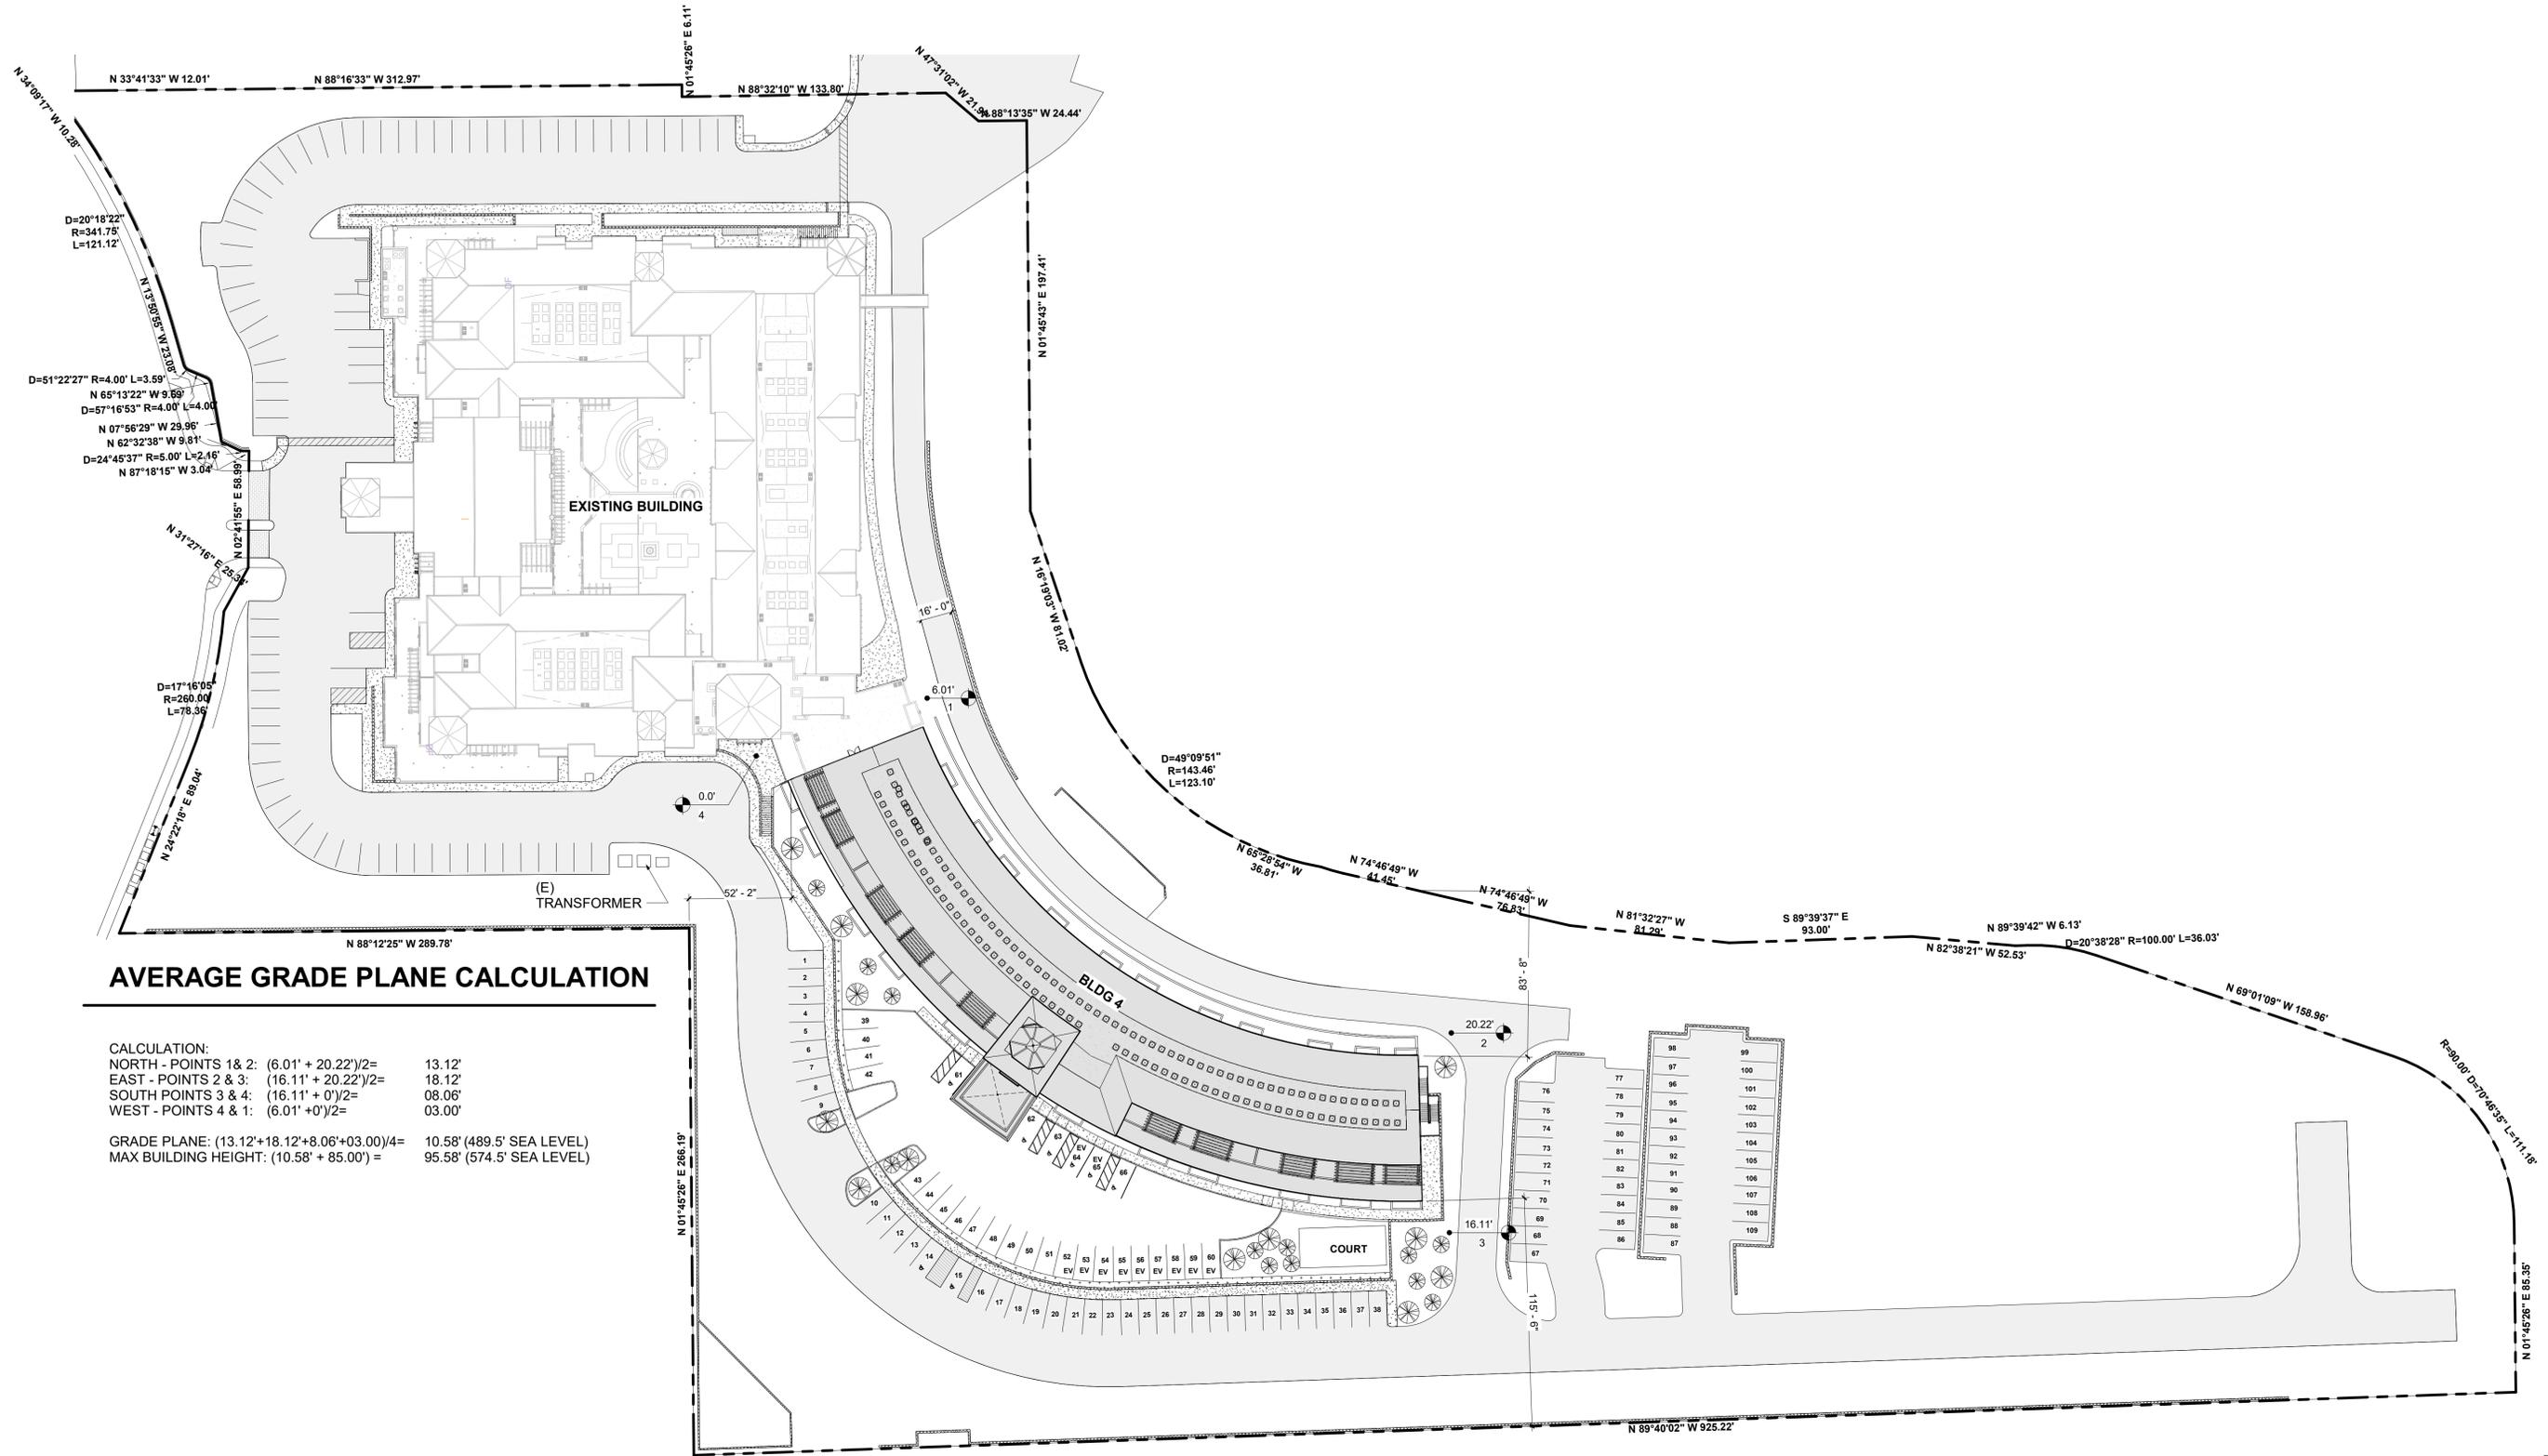

LUXURY SENIOR LIVING COMMUNITY
08/23/2022

NAME	COUNT
UNIT 1A	25
UNIT 1B	20
UNIT 1C	10
UNIT 2A	20
UNIT 2B	20
UNIT PH1A	3
UNIT PH2A	3
UNIT PH3A	2
UNIT STA	4
TOTAL PROJECT UNITS: 107	

BUILDING AREA:

BASEMENT LEVEL	17,156 SQFT
SECOND LEVEL	25,424 SQFT
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PARKING ANALYSIS:

107 x 1 UNITS = 107 PARKING SPOTS
TOTAL REQUIRED 107 SPOTS
 PARKING SPOTS PROVIDED = 92
 ACCESSIBLE SPOTS PROVIDED = 6
 EV PARKING SPOTS PROVIDED = 11
TOTAL PARKING PROVIDED = 109



SEALS AND SIGNATURES

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699 Hampshire Road #218
Westlake Village, CA 91361-1775

BUILDING 4
200 LANTERN CREST WAY
SANTEE, CA 92071

Issued for	Rev	Date
PLANNING SET	1	08/23/22
PLANNING SET		07/28/22
CLIENT REVIEW		03/30/22
ISSUE		

DRAWING TITLE
SITE PLAN - PARKING

SCALE 1" = 40'-0"
 PROJECT NUMBER 2119
 PLOT DATE 8/23/2022 6:08:04 PM

DRAWING #
A1.1



PROJECT NORTH

TENTATIVE MAP LANTERN CREST – PHASE 4 & 5

LEGAL DESCRIPTION

PARCEL B OF CERTIFICATE OF COMPLIANCE RECORDED FEBRUARY 05, 2018 AS INSTRUMENT NO. 2018-0046327 OF OFFICIAL RECORDS

SITE ADDRESS

8549 GRAVES AVENUE
SANTEE, CA 92071

SITE COVERAGE PH IV

	NET AREA	BLDGS., DWYS., PVT. STS.	SITE COVERAGE
SITE	162,867 SF	86,712 SF	53.2%

FLOOR-AREA RATIO PH IV

	NET AREA	FLOOR AREA (sf)	FLOOR-AREA RATIO
SITE	162,867 SF	25,784 SF	15.8%

SITE COVERAGE PH V

	NET AREA	BLDGS., DWYS., PVT. STS.	SITE COVERAGE
SITE	86,121 SF	20,563 SF	23.9%

FLOOR-AREA RATIO PH V

	NET AREA	FLOOR AREA (sf)	FLOOR-AREA RATIO
SITE	86,121 SF	N/A	

GRADING QUANTITIES

CUT 6,400 CY
FILL 1,700 CY
EXPORT 4,700 CY

EASEMENT NOTES

5. AN EASEMENT TO THE CITY OF SANTEE, FOR THE PURPOSE OF CONSERVATION, RECORDED FEBRUARY 10, 2006, AS INSTRUMENT/ FILE NO. 2006-0100586 OF OFFICIAL RECORDS.
6. A DOCUMENT ENTITLED "EASEMENT TERMINATION AND GRANT OF NEW NON-EXCLUSIVE EASEMENT" DATED MARCH 1, 2006, EXECUTED BY LANTERN CREST, LLC AND SANTEE RANCH PARTNERS, LLC, RECORDED APRIL 21, 2006 AS INSTRUMENT NO. 2006-0281522 OF OFFICIAL RECORDS.
7. AN EASEMENT TO SANTEE RANCH PARTNERS, LLC, FOR THE PURPOSE OF PRIVATE STREET, RECORDED APRIL 21, 2006, AS INSTRUMENT/FILE NO. 2006-0281522 OF OFFICIAL RECORDS.
8. A DOCUMENT ENTITLED "EXCLUSIVE EASEMENT AGREEMENT" DATED, JULY 5, 2006, EXECUTED BY LANTERN CREST, LLC, A CALIFORNIA LIMITED LIABILITY COMPANY AND WILLIAM ROBERT JEWETT AND JOLYNN TERESA JEWETT, HUSBAND AND WIFE, AS JOINT TENANTS, RECORDED JULY 6, 2006 AS INSTRUMENT NO. 2006-0477456 OF OFFICIAL RECORDS.
12. EASEMENT FOR THE PURPOSE SHOWN BELOW AND RIGHTS INCIDENTAL THERETO AS SHOWN OR AS OFFERED FOR DEDICATION ON THE RECORDED MAP SHOWN BELOW: PARCEL MAP NO. 200538
 - A. EASEMENT PURPOSE: FIRE AND EMERGENCY VEHICLE ACCESS
 - B. EASEMENT PURPOSE: PROPOSED PRIVATE ROAD AND UTILITY
15. EASEMENT AND MEMORANDUM OF AGREEMENT; DATED JUNE 13, 2011, BY AND BETWEEN SANTEE SENIOR RETIREMENT COMMUNITIES, LLC AND COXCOM, LLC DBA COX COMMUNICATIONS, RECORDED DECEMBER 29, 2011 AS INSTRUMENT NO. 2011-0704546 OF OFFICIAL RECORDS.
20. EASEMENT AND MEMORANDUM OF AGREEMENT; DATED JUNE 13, 2011, BY AND BETWEEN SANTEE SENIOR RETIREMENT COMMUNITIES, LLC AND COXCOM, LLC DBA COX COMMUNICATIONS, RECORDED DECEMBER 29, 2011 AS INSTRUMENT NO. 2011-0704546 OF OFFICIAL RECORDS.
21. THE MATTERS CONTAINED IN AN INSTRUMENT ENTITLED "AGREEMENT TO PERFORM STORM WATER FACILITIES MAINTENANCE", BY AND BETWEEN DEVELOPMENT CONTRACTORS INC. AND THE CITY OF SANTEE UPON THE TERMS THEREIN PROVIDED RECORDED DECEMBER 9, 2014 AS INSTR. NO. 2014-0540361, OF OFFICIAL RECORDS.
23. MATTERS CONTAINED IN DOCUMENT ENTITLED "EASEMENT AGREEMENT" BY AND BETWEEN SANTEE SENIOR RETIREMENT COMMUNITIES, LLC, A CALIFORNIA LIMITED LIABILITY COMPANY AND MICHAEL AND CASSANDRA KENT, RECORDED APRIL 12, 2018 AS INSTRUMENT NO. 2018-0145174 OF OFFICIAL RECORDS.
24. EASEMENT AND RIGHTS INCIDENTAL THERETO FOR PUBLIC UTILITIES EASEMENT TO SAN DIEGO GAS & ELECTRIC COMPANY, A CORPORATION, AS SET FORTH IN A DOCUMENT RECORDED JUNE 29, 2018 AS INSTRUMENT NO. 2018-0265826 OF OFFICIAL RECORDS.
25. EASEMENT AND RIGHTS INCIDENTAL THERETO FOR INGRESS AND EGRESS, AS SET FORTH IN A DOCUMENT RECORDED APRIL 29, 2019 AS INSTRUMENT NO. 2019-0156474 OF OFFICIAL RECORDS.
- △ PROPOSED EASEMENT FOR FIRE AND EMERGENCY VEHICLE ACCESS AND PROPOSED PRIVATE ROAD AND UTILITIES

ASSESSOR'S PARCEL NUMBER

384-142-25, 384-142-37

DEVELOPMENT SUMMARY

1. GROSS PROJECT AREA: 5.72 AC
2. NUMBER OF EXISTING LOTS: 1
3. NUMBER OF PROPOSED LOTS: 2
4. EXISTING ZONING: R-22 (HIGH DENSITY RESIDENTIAL)
5. PROPOSED ZONING: R-22 (HIGH DENSITY RESIDENTIAL)
6. GENERAL PLAN LAND USE DESIGNATION: RESIDENTIAL
7. EXISTING LAND USE: VACANT - PARKING LOT
8. PROPOSED LAND USE: MULTI-FAMILY RESIDENTIAL
9. NUMBER OF UNITS: 98 RESIDENTIAL UNITS
10. SETBACKS:

FRONT	10 FEET
EXT. STREET SIDE YARD	10 FEET
INTERIOR SIDE YARD	10 FEET
REAR	10 FEET
11. PARKING PROVIDED: (SEE SHEET 2)

STANDARD PARKING SPACE	91
ACCESSIBLE PARKING SPACE	7
TOTAL PARKING COUNT	98


(98 REQUIRED)

PROJECT NOTES

1. TOPOGRAPHY PER AERIAL SURVEY BY KAPPA SURVEYING, FLOWN ON MARCH 31, 2015 (DATUM: NGVD 29).
2. FINISH FLOOR ELEVATIONS ARE 8" ABOVE PAD ELEVATIONS.
3. SURFACES NOT IDENTIFIED AS STREETS, SIDEWALKS, DRIVEWAYS OR HOUSES SHALL BE LANDSCAPED.
4. ALL NEW STORM DRAIN FACILITIES PROPOSED WITH THIS SUBDIVISION SHALL BE PRIVATE AND BE MAINTAINED BY THE LANTERN CREST MANAGEMENT ASSOCIATION.
5. ALL ROOF DRAINS TO DISCHARGE THROUGH SITE BMP'S AND LANDSCAPING PRIOR TO ENTERING THE PUBLIC STORM DRAIN SYSTEM

DISTRICT SERVICE

FIRE:	CITY OF SANTEE
WATER:	PADRE DAM MWD
SEWER:	LANTERN CREST (PRIVATE)
HIGH SCHOOL:	GROSSMONT UNION H.S.D.
ELEMENTARY SCHOOL:	SANTEE UNIFIED S.D.
STREET LIGHTING:	LANTERN CREST (PRIVATE)
LANDSCAPE MAINTENANCE:	LANTERN CREST (PRIVATE)

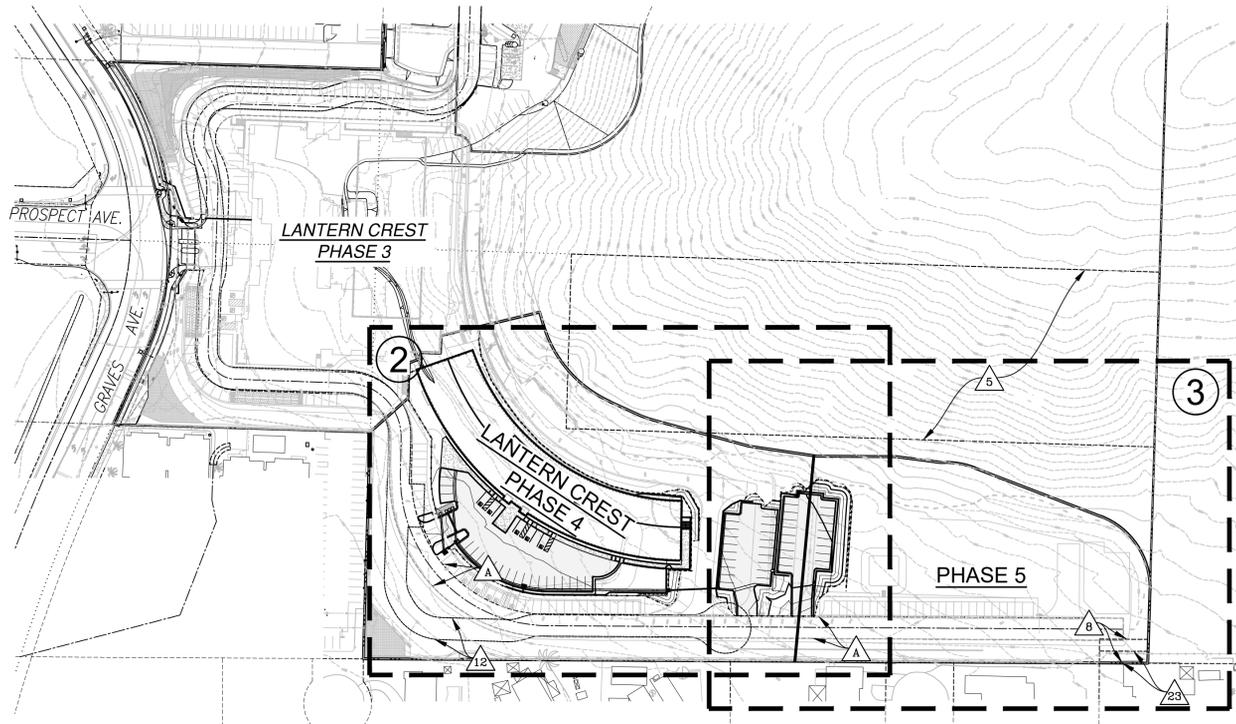

KEY MAP LEGEND

- GRADING PLAN SHEET LIMITS
- ② GRADING PLAN SHEET NO.


KEY MAP

SCALE: 1" = 100'



LEGEND

SYMBOL	DESCRIPTION
—	EXISTING RIGHT OF WAY
---	EXISTING LOT LINE
---	EXISTING EASEMENT
— W —	EXISTING WATER MAIN
— S —	EXISTING SEWER MAIN
—	EXISTING STORM DRAIN
—	EXISTING CURB
—	EXISTING BUILDING
—	EXISTING FENCE
—	EXISTING FIRE HYDRANT
—	EXISTING POWER POLE
—	PROPOSED CURB
—	PROPOSED STORM DRAIN
—	PROPOSED BUILDING
—	PROPOSED CONCRETE PAVING
—	PROPOSED BIOFILTRATION AREA (2,150 SF)
—	PROPOSED RETAINING WALL (VERTICAL STRAIGHT FACE TAN OR EQUAL) (POST AND CABLE RAILING SYSTEM TO BE INSTALLED ON TOP OF EACH WALL)
—	SAW CUT LINE
—	PROPOSED SLOPE (2:1 U.O.N.)
—	PROPOSED FINISH FLOOR ELEVATION
—	PROPOSED PAD ELEVATION
—	TYPE "B" CURB INLET
—	TYPE "F" INLET

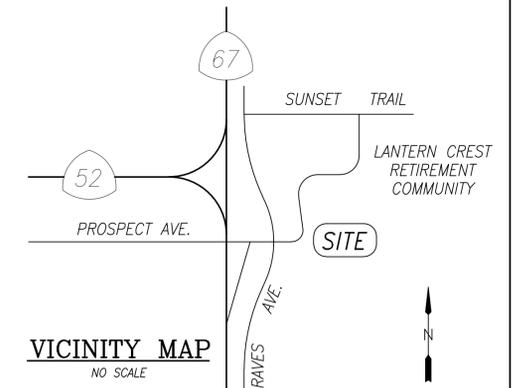

VICINITY MAP

NO SCALE

OWNER/SUBDIVIDER

DEVELOPMENT CONTRACTOR, INC.
NAME: MICHAEL GRANT
ADDRESS: 8510 RAILROAD AVENUE
SANTEE, CA 92071
PHONE: (619) 449-0249

MICHAEL GRANT DATE
FOR: SANTEE SENIOR RETIREMENT COMMUNITIES III, LLC,
A CALIFORNIA LIMITED LIABILITY COMPANY

ENGINEER OF WORK

REC CONSULTANTS, INC.
2442 SECOND AVENUE
SAN DIEGO, CA 92101
(619)232-9200 (619)232-9210 FAX




JONATHAN RAAB RYDEEN DATE
R.C.E. 64811 EXP. 6-30-23

August 9, 2022

SHEET 1 CITY OF SANTEE OF 3 SHEETS

TENTATIVE MAP
LANTERN CREST – PHASE 4 & 5

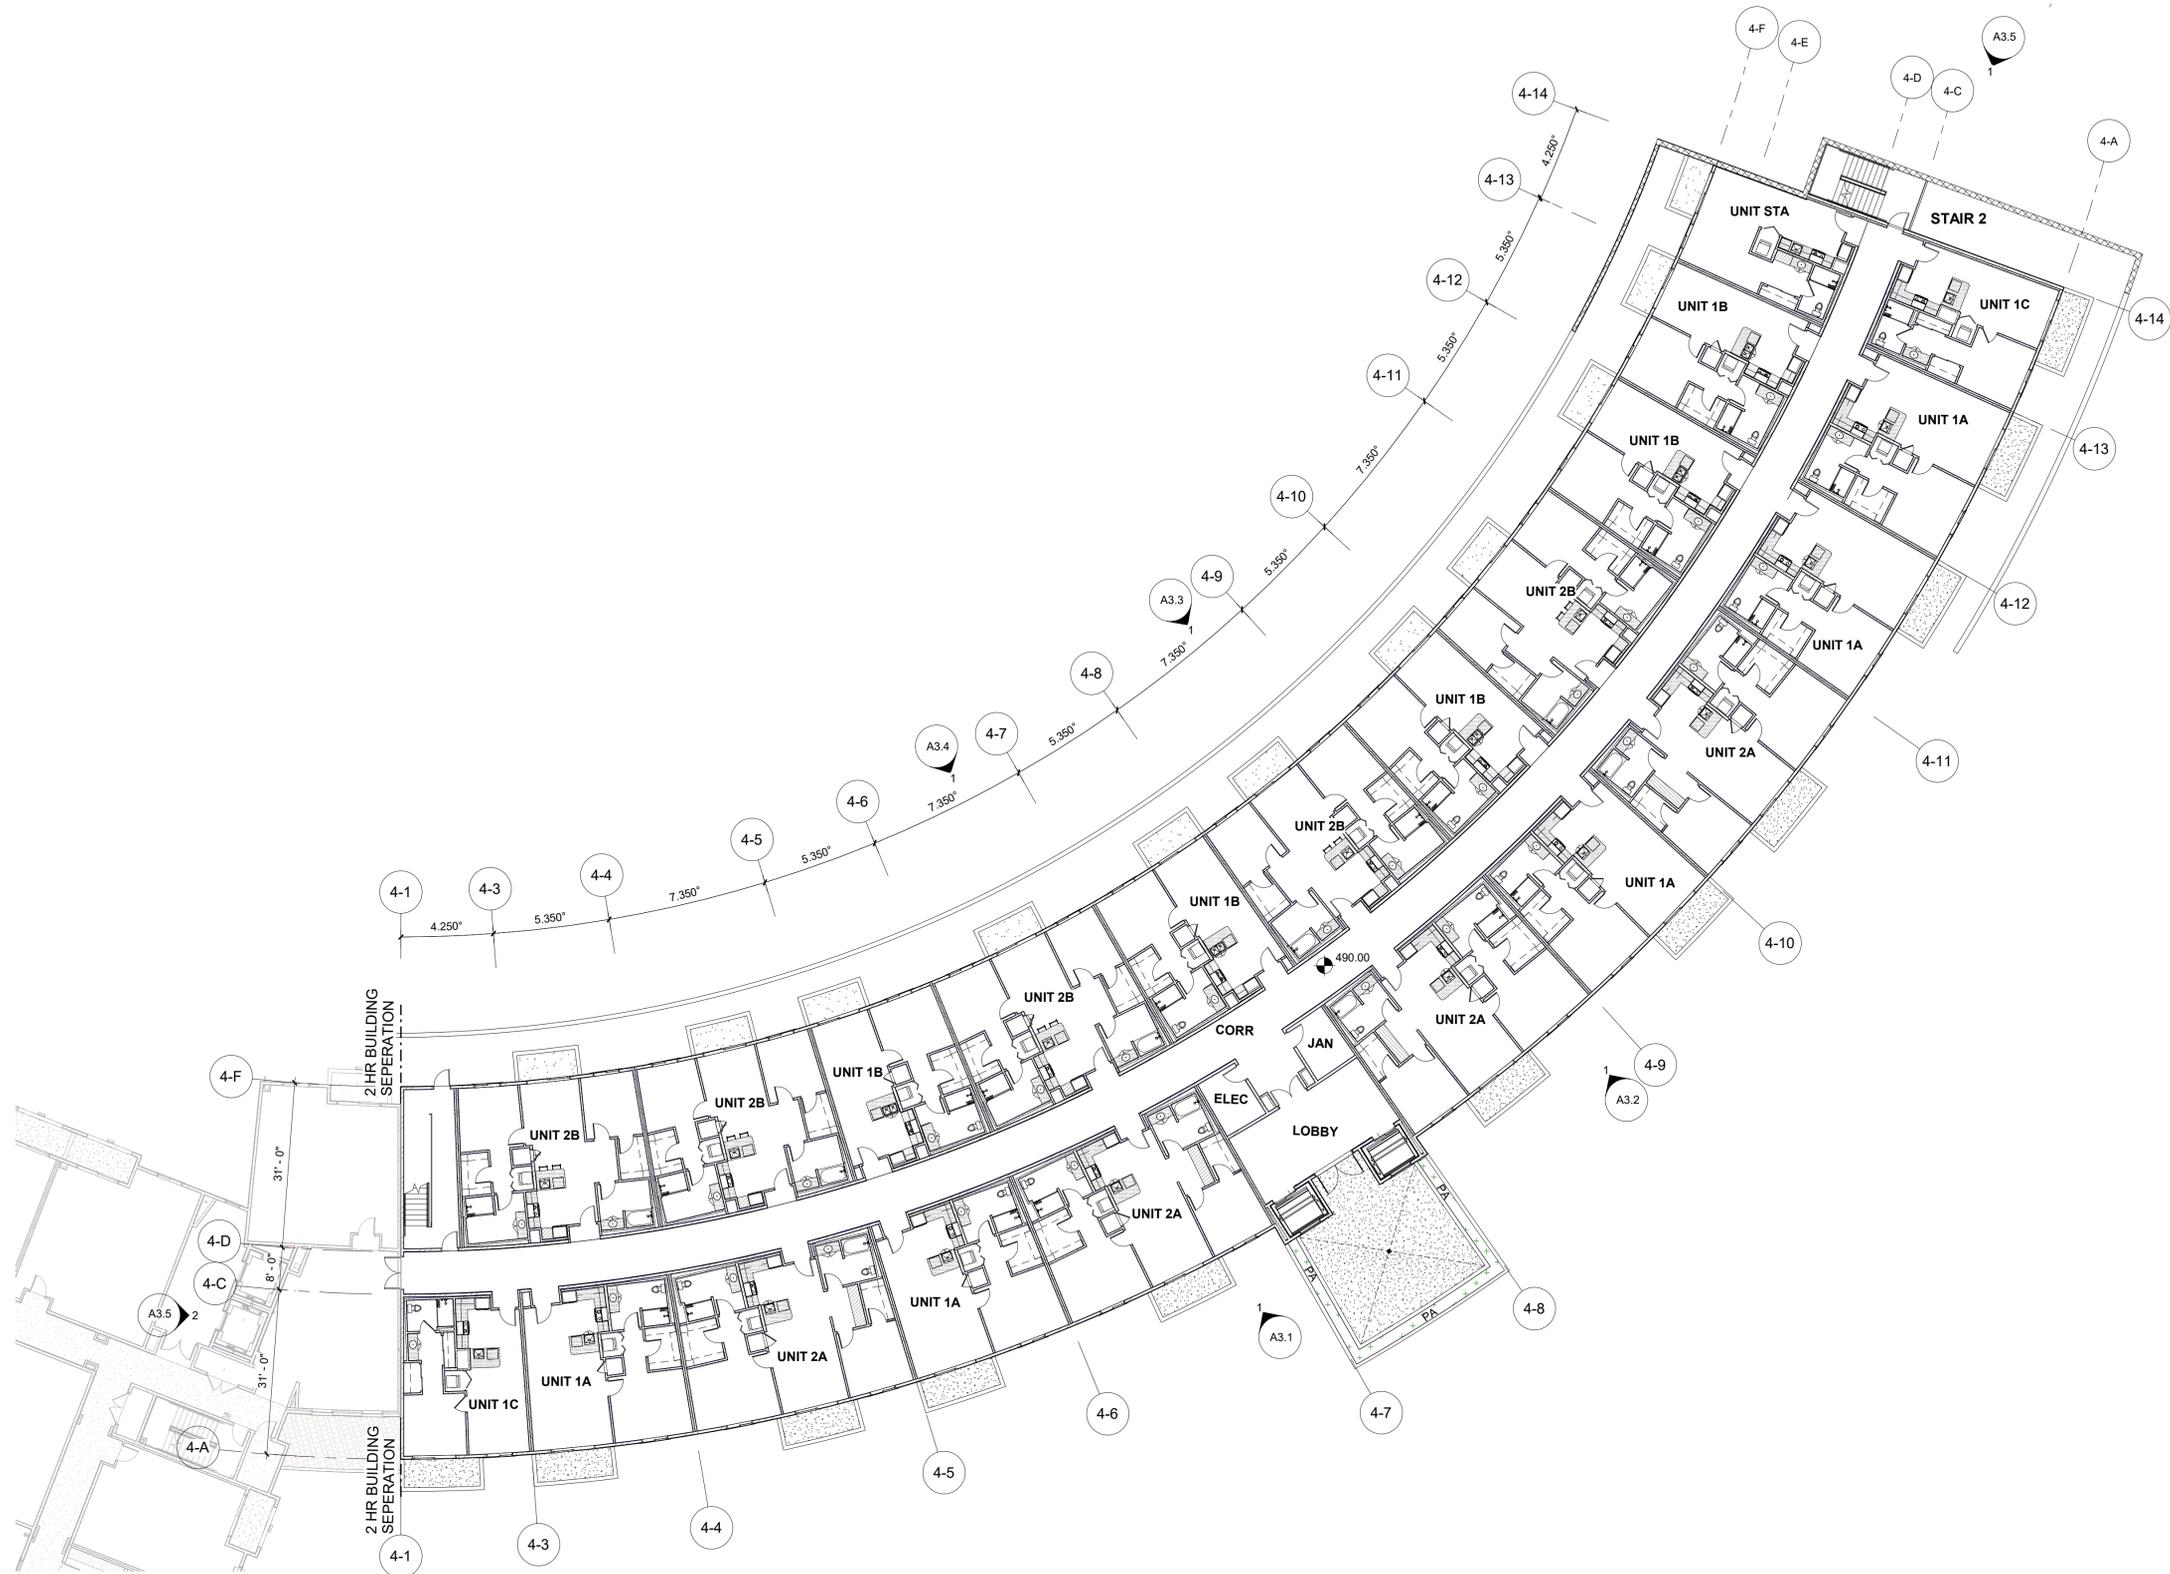

SEALS AND SIGNATURES


Todd B. SPIEGEL
architects

699 Hampshire Road #218
Westlake Village, CA 818.879.6175

BUILDING 4
200 LANTERN CREST WAY
SANTEE, CA 92071

Issued for	Rev	Date
PLANNING SET	1	08/23/22
PLANNING SET		07/28/22
CLIENT REVIEW		03/30/22
ISSUE		

DRAWING TITLE	
LEVEL 2 LEVEL 3, 4, AND 5 SIMILAR	
SCALE	1/16" = 1'-0"
PROJECT NUMBER	2119
PLOT DATE	8/23/2022 6:08:43 PM
A2.2	
DRAWING #	

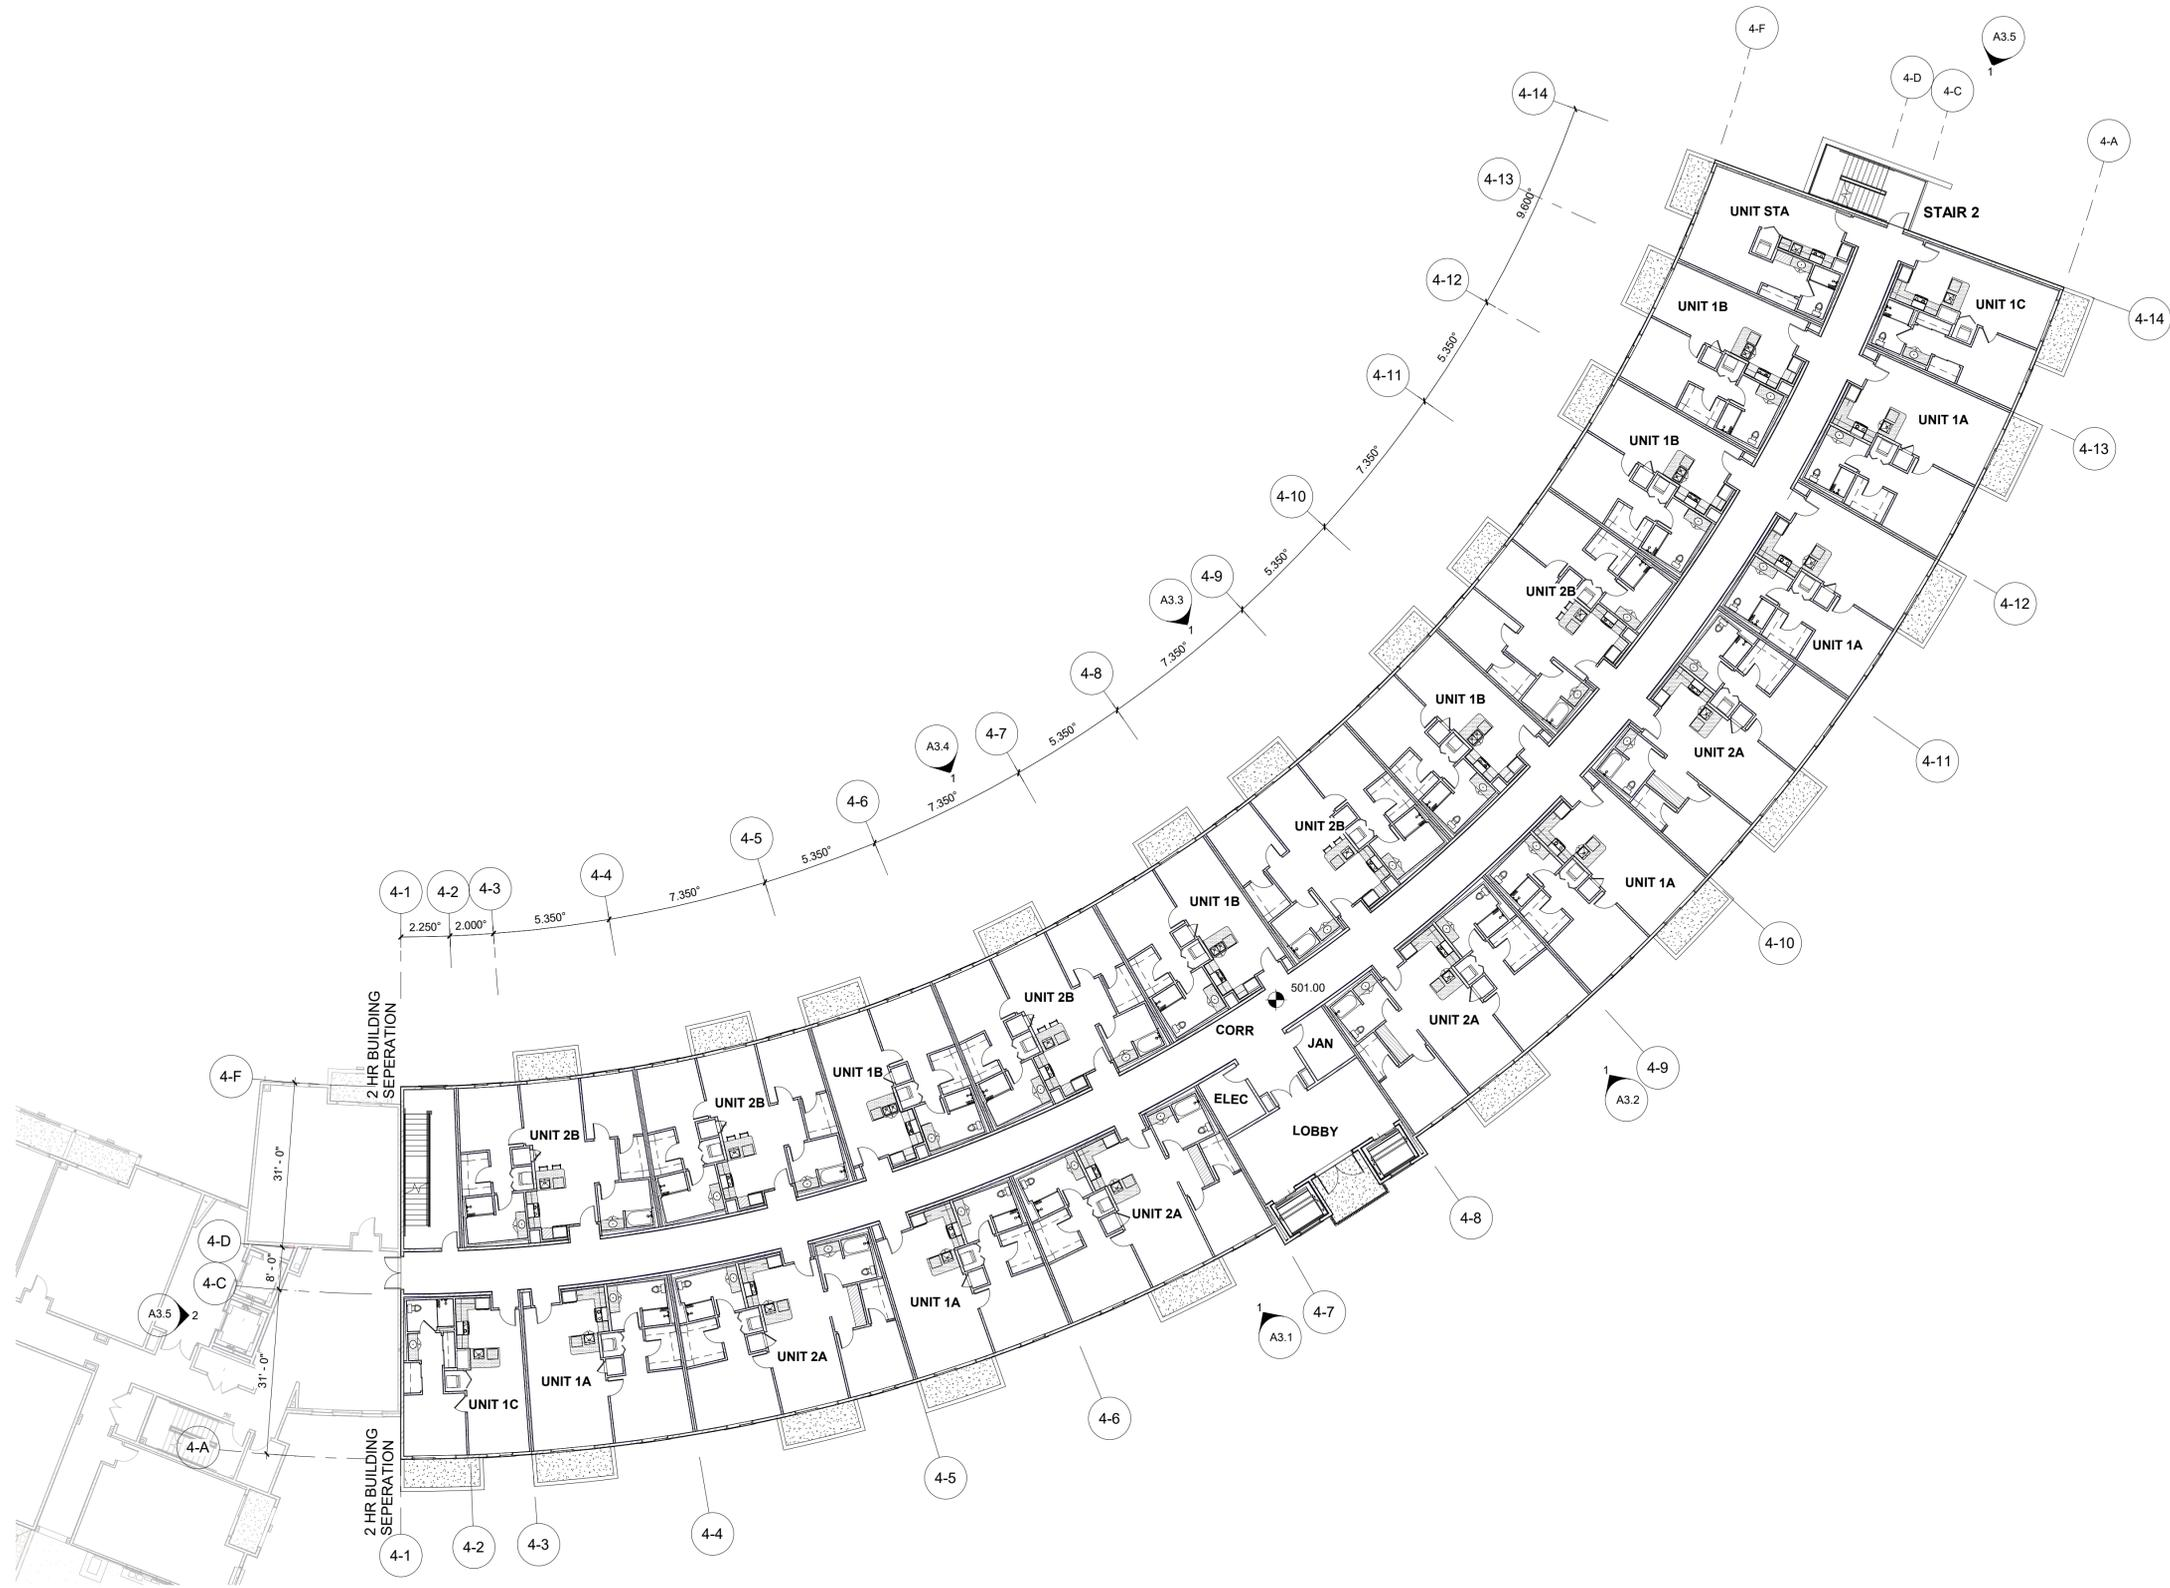

SEALS AND SIGNATURES


Todd B. SPIEGEL
architects

699 Hampshire Road #218
Westlake Village, CA 818.879.6175

BUILDING 4
200 LANTERN CREST WAY
SANTEE, CA 92071

Issued for	Rev	Date
PLANNING SET	1	08/23/22
PLANNING SET		07/28/22
CLIENT REVIEW		03/30/22
ISSUE		

DRAWING TITLE	
LEVEL 3	
SCALE	1/16" = 1'-0"
PROJECT NUMBER	2119
PLOT DATE	8/23/2022 6:09:05 PM
A2.3	
DRAWING #	

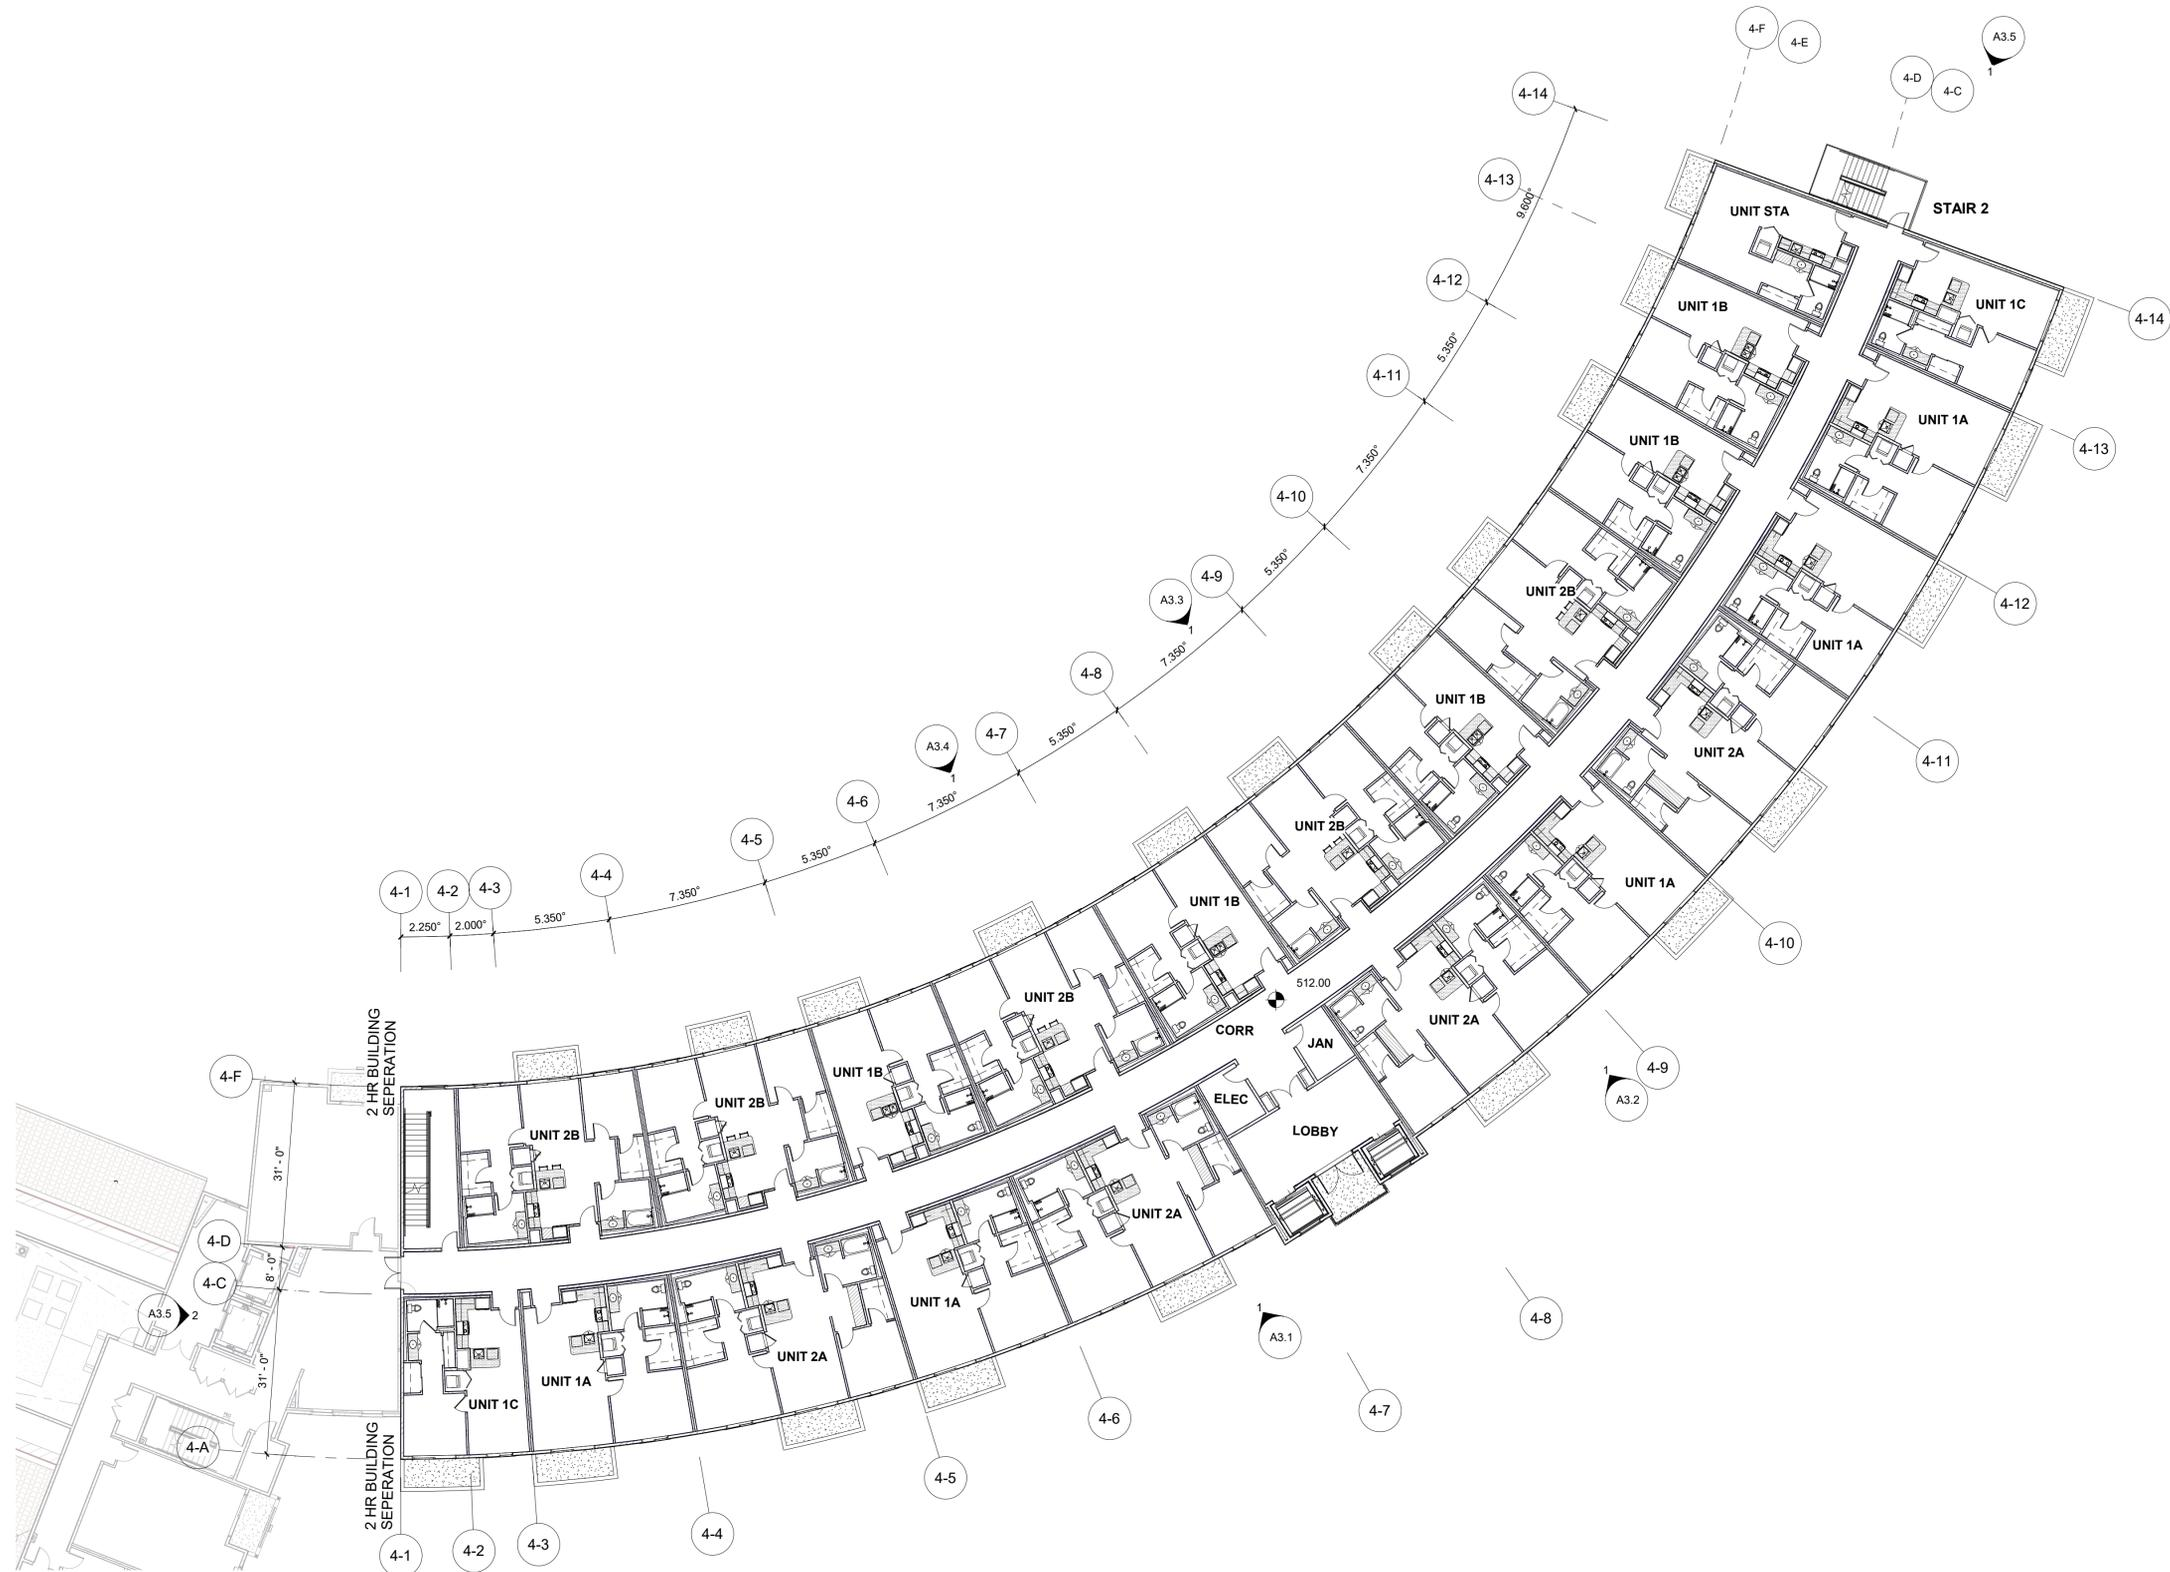

SEALS AND SIGNATURES

Todd B. SPIEGEL
architects

699 Hampshire Road #218
Westlake Village, CA 818.879.6175

BUILDING 4
200 LANTERN CREST WAY
SANTEE, CA 92071

Issued for	Rev	Date
PLANNING SET	1	08/23/22
PLANNING SET		07/28/22
CLIENT REVIEW		03/30/22
ISSUE		


DRAWING TITLE
LEVEL 4

SCALE 1/16" = 1'-0"

PROJECT NUMBER 2119

PLOT DATE 8/23/2022 6:09:26 PM

DRAWING # **A2.4**

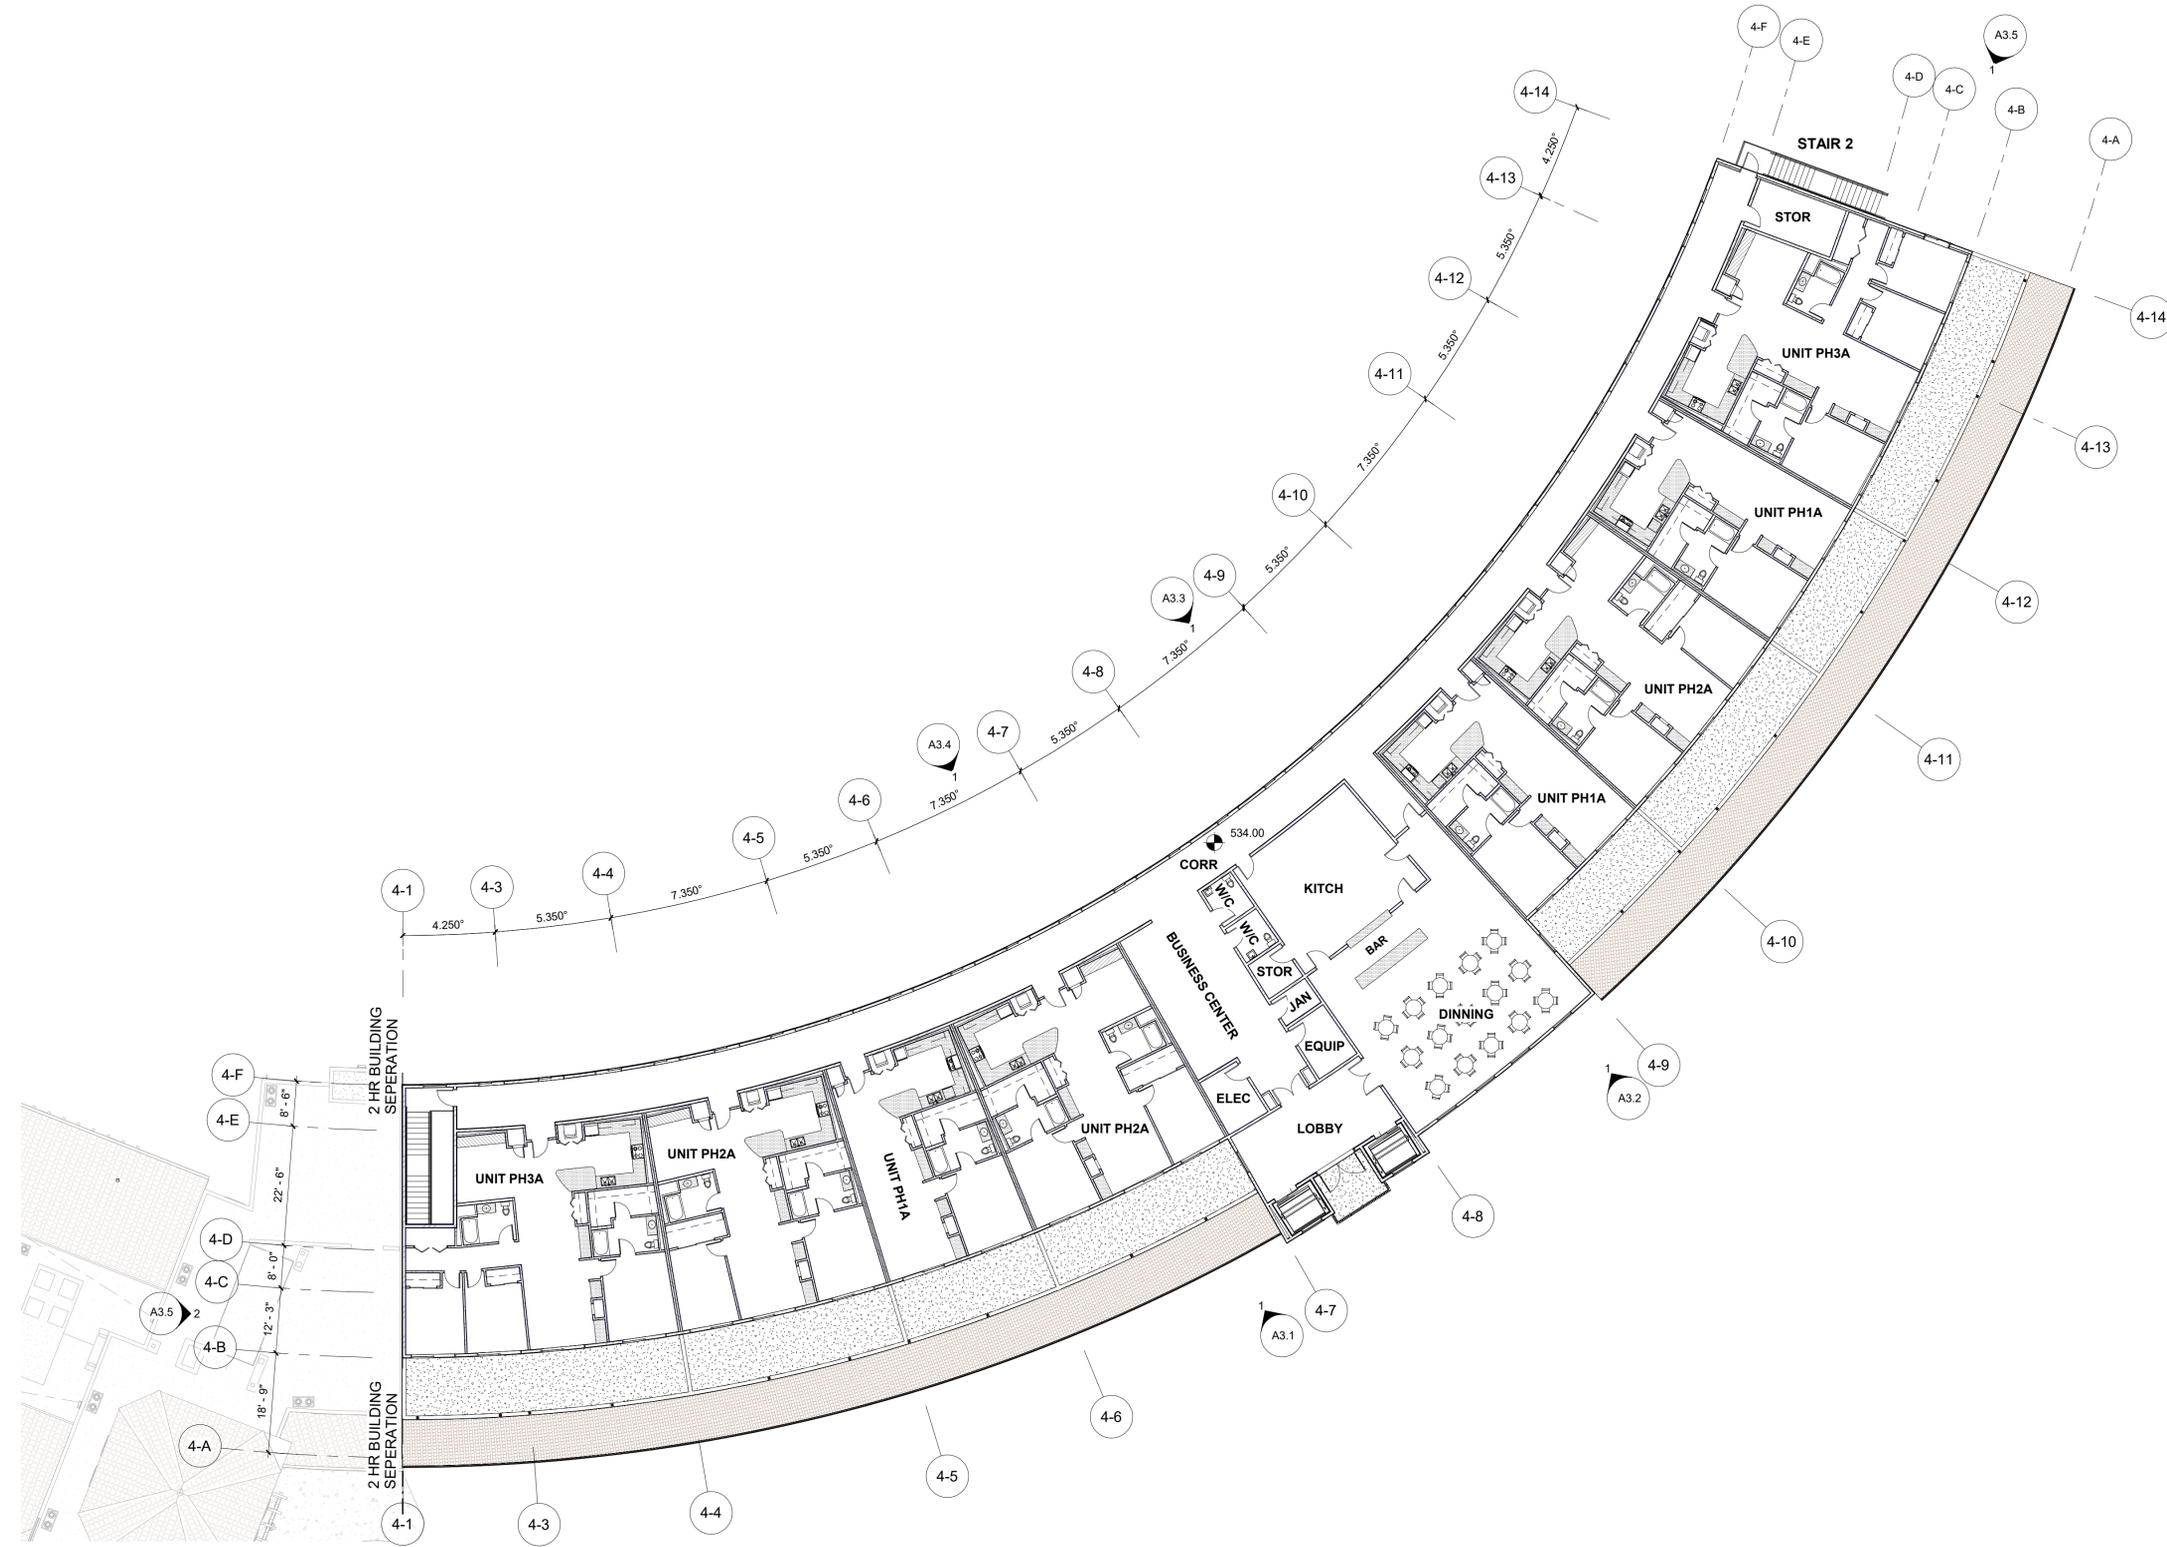

NAME	TYPE	# OF COMPLYING BATHROOMS	UNIT SF	AROUND
UNIT 1A	1 BED/1 BATH	1	85	1
UNIT 1B	1 BED/1 BATH	1	74	1
UNIT 1C	1 BED/1 BATH	1	68	1
UNIT 2A	2 BED/2 BATH	2	118	2
UNIT 2B	2 BED/2 BATH	2	103	2
UNIT PH1A	1 BED/1 BATH	1	110	1
UNIT PH2A	2 BED/2 BATH	2	152	2
UNIT PH3A	2 BED/1 DEN/ 2 BATH	2	186	2
UNIT STA	STUDIO	1	58	1
TOTAL PROJECT UNITS: 107				

Todd B. SPIEGEL architects
 699 Hampshire Road #218
 Westlake Village, CA 818.879.6175

BUILDING 4
 200 LANTERN CREST WAY
 SANTEE, CA 92071

Issued for	Rev	Date
PLANNING SET	1	08/23/22
PLANNING SET		07/28/22
CLIENT REVIEW		03/30/22
ISSUE		

DRAWING TITLE
LEVEL 6

SCALE 1/16" = 1'-0"

PROJECT NUMBER 2119

PLOT DATE 8/23/2022 6:10:07 PM

A2.6

DRAWING #

ENGINEER OF WORK'S DESIGN CERTIFICATION

I, RAAB RYDEEN, HEREBY DECLARE THAT I AM THE ENGINEER OF WORK FOR THE DRAINAGE STUDY, SWMP, AND SHEETS 6-10 FOR THIS PROJECT, THAT I HAVE EXERCISED RESPONSIBLE CHARGE, AS DEFINED IN SECTION 6703 OF THE BUSINESS AND PROFESSIONS CODE, OVER THE ENGINEERING DESIGN OF MY PORTION OF THIS PROJECT AND THAT THE DESIGN IS CONSISTENT WITH CURRENT STANDARDS.

I UNDERSTAND THAT THE CHECK OF PROJECT DRAWINGS AND SPECIFICATIONS BY THE CITY OF SANTEE IS CONFINED TO A REVIEW ONLY AND DOES NOT RELIEVE ME AS THE ENGINEER OF WORK OF MY RESPONSIBILITIES FOR PROJECT DESIGN.

I FURTHER UNDERSTAND THAT UPON APPROVAL OF THESE PLANS BY THE CITY ENGINEER, THE PLANS BECOME THE PROPERTY OF THE CITY OF SANTEE IN ACCORDANCE WITH THE CITY PUBLIC WORKS STANDARDS. AS SUCH, I HEREBY RELINQUISH RIGHT OF OWNERSHIP TO THE CITY TO USE THESE PLANS AS THEY MAY DEEM NECESSARY.

SIGNED: _____ DATE: _____
 REGISTRATION NO. 64811, MY REGISTRATION EXPIRES ON 6/30/2023
 FIRM: R.E.C. CONSULTANTS, INC.
 ADDRESS: 2442 SECOND AVENUE
 SAN DIEGO, CA 92101
 TELEPHONE: (619) 232-9200



ENGINEER OF WORK'S RECORD DRAWING CERTIFICATION

I, _____, A REGISTERED CIVIL ENGINEER IN THE STATE OF CALIFORNIA, HEREBY DECLARE THAT I HAVE EXERCISED RESPONSIBLE CHARGE, AS DEFINED IN SECTION 6703 OF THE BUSINESS AND PROFESSIONS CODE, OVER THE PREPARATION OF THE ENGINEERING PORTION OF THE RECORD DRAWINGS AND THAT THE INFORMATION SHOWN IS BASED ON AN INVESTIGATION AND SURVEY OF THE IMPROVEMENTS BETWEEN THE DATES OF _____ AND _____ TO THE BEST OF MY KNOWLEDGE AND EXPERIENCE THE INFORMATION SHOWN ON THESE PLANS PROVIDE AN ACCURATE AND CORRECT REPRESENTATION OF THE AS-BUILT CONDITIONS.

SIGNED: _____ DATE: _____
 REGISTRATION NO. _____, MY REGISTRATION EXPIRES ON _____
 FIRM: _____
 ADDRESS: _____
 TELEPHONE: _____

RESIDENTIAL FLOOD STATEMENT

I, _____, A REGISTERED CIVIL ENGINEER/LAND SURVEYOR HEREBY CERTIFY THAT THE PAD ELEVATIONS SHOWN ON THIS AS-BUILT GRADING PLAN HAVE BEEN VERIFIED BY ME AND THAT SAID ELEVATIONS ARE AT OR ABOVE THE BASE FLOOD ELEVATION AS ESTABLISHED BY THE BASE FLOOD DISCHARGE RATES SET FORTH IN THE FLOOD DAMAGE PREVENTION ORDINANCE - CHAPTER 15.52 OF THE SANTEE MUNICIPAL CODE.

SIGNED: _____ DATE: _____
 REGISTRATION NO. _____, MY REGISTRATION EXPIRES ON _____

SOIL ENGINEER'S DESIGN CERTIFICATION

I, MATTHEW MARCUS, A REGISTERED CIVIL ENGINEER IN THE STATE OF CALIFORNIA, PRINCIPALLY DOING BUSINESS IN THE FIELD OF APPLIED SOIL MECHANICS, HEREBY CERTIFY THAT A SAMPLING AND STUDY OF THE SOIL CONDITIONS PREVALENT WITHIN THIS SITE WAS MADE BY ME OR UNDER MY DIRECTION BETWEEN THE DATES JULY 8, 2022 AND JULY 12, 2022. THREE COMPLETE COPIES OF THE SOILS REPORT COMPILED FROM WITH MY RECOMMENDATIONS, HAS BEEN SUBMITTED TO THE OFFICE OF THE DIRECTOR OF DEVELOPMENT SERVICES.

I HAVE REVIEWED THE PROJECT DESIGN AND THE GRADING SHOWN HEREON IS CONSISTENT WITH THE RECOMMENDATIONS CONTAINED IN THE APPROVED SOILS AND GEOTECHNICAL REPORTS FOR THE PROJECT.

I FURTHER UNDERSTAND THAT UPON APPROVAL OF THESE PLANS BY THE CITY ENGINEER, THE PLANS BECOME THE PROPERTY OF THE CITY OF SANTEE IN ACCORDANCE WITH THE CITY PUBLIC WORKS STANDARDS. AS SUCH, I HEREBY RELINQUISH RIGHT OF OWNERSHIP TO THE CITY TO USE THESE PLANS AS THEY MAY DEEM NECESSARY.

SIGNED: _____ DATE: _____
 REGISTRATION NO. G.E. 3156, MY REGISTRATION EXPIRES ON 09/30/2023
 FIRM: PARTNER ASSESSMENT CORPORATION (PARTNER)
 ADDRESS: 2154 TORRANCE BLVD.
 TORRANCE, CA 90501
 TELEPHONE: (800) 419-4923




SOIL ENGINEER'S RECORD DRAWING CERTIFICATION

I, _____, A REGISTERED CIVIL ENGINEER IN THE STATE OF CALIFORNIA, HEREBY DECLARE THAT I HAVE EXERCISED RESPONSIBLE CHARGE, AS DEFINED IN SECTION 6703 OF THE BUSINESS AND PROFESSIONS CODE, OVER THE GEOTECHNICAL ASPECTS OF THE GRADING OF THIS PROJECT. TO THE BEST OF MY KNOWLEDGE AND EXPERIENCE THE GRADING CONFORMS WITH THE RECOMMENDATIONS CONTAINED IN THE SOILS REPORTS AND PLANS WITH THE EXCEPTION THAT ANY CHANGES OR DEVIATIONS FROM THE PLANS DUE TO UNFORESEEN FIELD CONDITIONS HAVE BEEN IDENTIFIED IN THE FINAL SOILS REPORT FOR THE PROJECT.

SIGNED: _____ DATE: _____
 REGISTRATION NO. _____, MY REGISTRATION EXPIRES ON _____
 FIRM: _____
 ADDRESS: _____
 TELEPHONE: _____

LANTERN CREST - PHASE 4 PRECISE GRADING PLANS

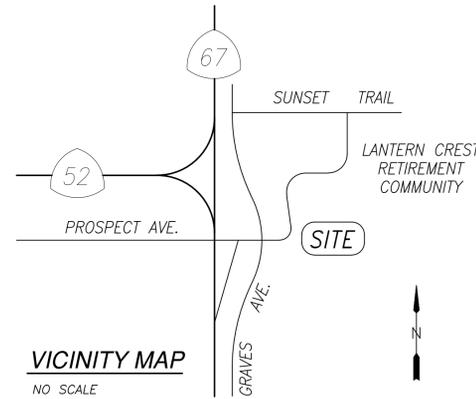

OWNER'S ACCEPTANCE

I, MICHAEL GRANT, PRESIDENT OF M. GRANT CORPORATION, MANAGING PARTNER, SANTEE SENIOR RETIREMENT COMMUNITIES III, LLC, AS OWNER OF THE PROPERTY DESCRIBED HEREON, ACKNOWLEDGE THESE PLANS HAVE BEEN PREPARED AT MY DIRECTION AND WITH MY FULL CONSENT. I UNDERSTAND ALL CONSTRUCTION MUST CONFORM TO CURRENT CITY STANDARDS AND BE COMPLETED IN ACCORDANCE WITH THESE PLANS. ANY CHANGES TO THE WORK MUST BE APPROVED IN ADVANCE, IN ACCORDANCE WITH THE CITY'S CONSTRUCTION CHANGE POLICY. I AGREE TO REMOVE AND RECONSTRUCT AT MY COST ANY WORK NOT COMPLETED IN STRICT ACCORDANCE WITH THESE PLANS OR ANY CONSTRUCTION CHANGES APPROVED INCIDENTAL THERETO.

SIGNED: _____ DATE: _____
 MICHAEL GRANT, PRESIDENT
 ADDRESS: 800 LANTERN CREST WAY
 SANTEE, CA 92071
 TELEPHONE: (619) 449-0249

SITE ADDRESS

200 LANTERN CREST WAY
 SANTEE, CA 92071

LEGAL DESCRIPTION

PARCEL B OF CERTIFICATE OF COMPLIANCE RECORDED NOVEMBER 10, 2022 AS INSTRUMENT NO. 2022-0434391 OF OFFICIAL RECORDS

ASSESSOR PARCEL NUMBER

384-142-25, 384-142-37

PUBLIC UTILITIES

SAN DIEGO GAS & ELECTRIC 800-422-4133
 SBC TELEPHONE 800-422-4133
 COX COMMUNICATIONS (CATV) 619-263-5793
 PADRE DAM MWD (WATER & SEWER) 619-448-3111

SHEET INDEX

NO.	DESCRIPTION
1	TITLE SHEET
2	NOTES
3-8	GRADING PLANS
9-10	EROSION CONTROL PLAN
11-18	LANDSCAPE & IRRIGATION PLANS

LANDSCAPE ARCHITECT'S DESIGN CERTIFICATION

I, GARY F. HOYT, HEREBY DECLARE THAT I AM THE LANDSCAPE ARCHITECT OF WORK FOR THIS PROJECT, THAT I HAVE EXERCISED RESPONSIBLE CHARGE, AS DEFINED IN THE BUSINESS AND PROFESSIONALS CODE, OVER THE DESIGN OF THIS PROJECT AND THAT THE DESIGN IS CONSISTENT WITH CURRENT STANDARDS.

I HAVE COMPLIED WITH THE CRITERIA OF THE ORDINANCE AND APPLIED THEM ACCORDINGLY FOR THE EFFICIENT USE OF WATER IN THE GRADING DESIGN PLAN.

I UNDERSTAND THAT THE CHECK OF PROJECT DRAWINGS AND SPECIFICATIONS IN THE CITY OF SANTEE IS CONFINED TO A REVIEW ONLY AND DOES NOT RELIEVE ME AS THE LANDSCAPE ARCHITECT OF WORK OF MY RESPONSIBILITIES FOR PROJECT DESIGN.

I FURTHER UNDERSTAND THAT UPON APPROVAL OF THESE PLANS BY THE CITY ENGINEER, THE PLANS BECOME THE PROPERTY OF THE CITY OF SANTEE IN ACCORDANCE WITH THE CITY PUBLIC WORKS STANDARDS. AS SUCH, I HEREBY RELINQUISH RIGHT OF OWNERSHIP TO THE CITY TO USE THESE PLANS AS THEY MAY DEEM NECESSARY.

SIGNED: _____ DATE: _____
 REGISTRATION NO. 2517, MY REGISTRATION EXPIRES ON 12/31/2022
 FIRM: GARY F. HOYT LANDSCAPE ARCHITECTURE, INC.
 ADDRESS: 13625 ADRIAN STREET, SUITE 813
 POWAY, CA 92064
 TELEPHONE: (858) 486-4931



LANDSCAPE ARCHITECT'S RECORD DRAWING CERTIFICATION

I, _____, A REGISTERED LANDSCAPE ARCHITECT IN THE STATE OF CALIFORNIA, HEREBY DECLARE THAT I HAVE EXERCISED RESPONSIBLE CHARGE OVER THE PREPARATION OF THESE RECORD DRAWINGS AS THEY PERTAIN TO THE LANDSCAPE IMPROVEMENTS. THE INFORMATION SHOWN IS BASED ON ACTUAL SITE INVESTIGATION AND SURVEY OF THE IMPROVEMENTS BETWEEN THE DATES OF _____ AND _____ TO THE BEST OF MY KNOWLEDGE AND EXPERIENCE THE INFORMATION SHOWN ON THESE PLANS PROVIDE AN ACCURATE AND CORRECT REPRESENTATION OF THE AS-BUILT CONDITIONS.

SIGNED: _____ DATE: _____
 REGISTRATION NO. _____, MY REGISTRATION EXPIRES ON _____
 FIRM: _____
 ADDRESS: _____
 TELEPHONE: _____



IMPORTANT NOTICE
 Section 4216/4217 of the Government Code requires that a Dig Alert Identification Number be issued before a "Permit to Excavate" will be valid. For your Dig Alert I.D. Number Call Underground Service Alert TOLL FREE 1-800-422-4133 Two working days before you dig

CITY OF SANTEE

FIRE DEPARTMENT
 FIRE MARSHAL _____ DATE _____

COMMUNITY SERVICES DEPARTMENT
 PUBLIC WORKS MANAGER _____ DATE _____

ENGINEERING DIVISION
 CITY ENGINEER _____ DATE _____
 RCE NO. 60112 EXPIRES: 08/30/24

PLANNING DIVISION
 PROJECT PLANNER _____ DATE _____

TRAFFIC ENGINEERING DIVISION
 PRINCIPAL TRAFFIC ENGINEER _____ DATE _____

WATER AGENCY
 PADRE DAM MUNICIPAL WATER DISTRICT

APPROVED BY: _____ DATE _____
 DIR OF ENGINEERING & PLANNING

RCE NO. _____ EXP _____
LANTERN CREST PHASE 4

PROJECT NAME _____ JOB NO. _____

VALID FOR ONE YEAR FROM DATE OF SIGNATURE. SIGNATURE OF THESE PLANS IS NOT A COMMITMENT TO SERVE.


CONSTRUCTION RECORD	REFERENCES	DATE	BY	REVISIONS	ACPTD	BENCH MARK	SCALE	DESIGNED BY	DRAWN BY	CHECKED BY	REVIEWED	CITY OF SANTEE	DEPARTMENT OF DEVELOPMENT SERVICES	CITY W.O. NO.	DRAWING NO.
CONTRACTOR	556W, 2254WS, 2255WS, 2263WS					CITY OF SANTEE VERTICAL CONTROL MONUMENT	HORIZ: N/A	J.M.W.	J.M.W.	J.R.R.		CITY OF SANTEE			
INSPECTOR	2011-026, 2011-037, 2013-015					#2076 PER R.O.S. 11252, LOCATED AT THE INTERSECTION	VERT: N/A	PLANS PREPARED UNDER THE SUPERVISION OF			BY _____	GRADING PLANS FOR:			
DATE COMPLETED	2016-163, 2016-183, 2016-352 G-1281					OF PROSPECT AVENUE & ARGENT STREET		RCE NO. 64811	DATE _____	EXPIRES: 6-30-2023	PROJECT ENGINEER	LANTERN CREST - PHASE 4	P2007-12	G-1383	2022- SHEET 1 OF 18

LANTERN CREST - PHASE 4 PRECISE GRADING PLANS

GENERAL NOTES

- SUBDIVISION MONUMENTATION SHALL BE PROTECTED AT ALL TIMES. PRIOR TO ISSUANCE OF GRADING PERMIT THE SUBDIVISION BOUNDARY SHALL BE STAKED AND FLAGGED, WITH LATHS AT LEAST THREE FEET IN HEIGHT, AT ALL SUBDIVISION CORNERS, ANGLE POINTS, AND POINTS OF CURVE. WHERE BOUNDARY LINES EXCEED THREE HUNDRED FEET IN LENGTH STAKES SHALL BE PLACED ON LINE AT NOT OVER THREE HUNDRED FOOT INTERVALS. WHERE PERMISSION FOR OFFSITE GRADING HAS BEEN GRANTED THE LIMITS OF OFF-SITE WORK SHALL BE STAKED AND FLAGGED ALSO. OFF-SITE WORK SHALL BE CLEARLY IDENTIFIED WITH DIFFERENT COLOR FLAGGING OR MARKINGS FROM THE SUBDIVISION BOUNDARY FLAGGING. THE CONTRACTOR SHALL AT ALL TIMES PROTECT THE SUBDIVISION BOUNDARY AND OFF-SITE MARKERS AND SHALL IMMEDIATELY REPLACE ANY MARKERS THAT ARE DISTURBED OR DESTROYED.
- ACCEPTANCE OF THIS GRADING PLAN DOES NOT CONSTITUTE ACCEPTANCE OF VERTICAL OR HORIZONTAL ALIGNMENT OF ANY PRIVATE ROAD SHOWN HEREON FOR PUBLIC ROAD PURPOSES.
- FINAL ACCEPTANCE OF THESE GRADING PLANS IS SUBJECT TO FINAL ACCEPTANCE OF THE ASSOCIATED IMPROVEMENT PLANS WHERE APPLICABLE. FINAL CURB GRADE ELEVATIONS MAY REQUIRE CHANGES IN THESE PLANS.
- IMPORT MATERIAL SHALL BE OBTAINED FROM A LEGAL SITE.
- WASTE MATERIAL GENERATED FROM GRADING OPERATIONS SHALL BE HAULED TO A LEGAL DUMP SITE AS APPROVED BY THE DIRECTOR OF DEVELOPMENT SERVICES.
- AN ENCROACHMENT PERMIT IS REQUIRED PRIOR TO ANY WORK BEING PERFORMED WITHIN THE LIMITS OF THE PUBLIC RIGHT OF WAY.
- ALL SLOPES OVER THREE FEET IN HEIGHT SHALL BE LANDSCAPED AND IRRIGATED IN ACCORDANCE WITH CITY SPECIFICATIONS.
- THE CONTRACTOR SHALL VERIFY THE EXISTENCE AND LOCATION OF ALL UTILITIES BEFORE COMMENCING WORK. NOTICE OF PROPOSED WORK SHALL BE GIVEN TO THE FOLLOWING AGENCIES:
 SAN DIEGO GAS & ELECTRIC 1-800-422-4133
 PACIFIC BELL TELEPHONE 1-800-422-4133
 COX CABLE TV 263-5793
 PADRE DAM MUNICIPAL WATER DISTRICT 448-3111
 (water and sewer)
- REQUESTS FOR RELEASE OF GRADING AND EROSION CONTROL SECURITIES UPON COMPLETION OF THE WORK SHALL BE MADE IN ACCORDANCE WITH THE REQUIREMENTS SET FORTH IN THE CITY OF SANTEE LAND DEVELOPMENT MANUAL.
- ACCEPTANCE OF THESE PLANS BY THE CITY ENGINEER DOES NOT AUTHORIZE ANY WORK OR GRADING TO BE PERFORMED UNTIL THE PROPERTY OWNER'S PERMISSION HAS BEEN OBTAINED AND A VALID GRADING PERMIT HAS BEEN ISSUED.
- THE CITY ENGINEER'S ACCEPTANCE OF THESE PLANS DOES NOT CONSTITUTE THE BUILDING OFFICIALS' ACCEPTANCE OF ANY FOUNDATION FOR STRUCTURES TO BE PLACED IN THE AREA COVERED BY THESE PLANS. NO WAIVER OF THE GRADING ORDINANCE REQUIREMENTS CONCERNING MINIMUM COVER OVER EXPANSIVE SOILS IS MADE OR IMPLIED (SECTION 15.58.590, SANTEE MUNICIPAL CODE).
- ALL OPERATIONS CONDUCTED ON THE PREMISES, INCLUDING THE WARMING UP, REPAIR, ARRIVAL, DEPARTURE OR RUNNING OF TRUCKS, EARTHMOVING EQUIPMENT, CONSTRUCTION EQUIPMENT AND ANY OTHER ASSOCIATED CONSTRUCTION ACTIVITY SHALL BE LIMITED TO THE PERIOD BETWEEN 7:00 A.M. AND 7:00 P.M. EACH DAY, MONDAY THROUGH FRIDAY. NO EARTHMOVING OR GRADING OPERATIONS SHALL BE CONDUCTED ON THE PREMISES ON SUNDAY OR CITY HOLIDAYS. WORK ON SATURDAY REQUIRES THE WRITTEN APPROVAL OF THE CITY ENGINEER.
- ALL MAJOR SLOPES SHALL BE ROUNDED INTO EXISTING TERRAIN TO PRODUCE A SMOOTH CONTOURED TRANSITION FROM CUT OR FILL FACES TO NATURAL GROUND AND ABUTTING CUT OR FILL SURFACES.
- NOTWITHSTANDING THE MINIMUM STANDARDS SET FORTH IN THE GRADING ORDINANCE AND NOTWITHSTANDING THE ACCEPTANCE OF THESE GRADING PLANS, THE PERMITTEE IS RESPONSIBLE FOR THE PREVENTION OF DAMAGE TO ADJACENT PROPERTY. NO PERSON SHALL EXCAVATE ON LAND SO CLOSE TO THE PROPERTY LINE AS TO ENDANGER ANY ADJOINING PUBLIC STREET, SIDEWALK, ALLEY, FUNCTION OF ANY SEWAGE DISPOSAL SYSTEM, OR ANY OTHER PUBLIC OR PRIVATE PROPERTY WITHOUT SUPPORTING AND PROTECTING SUCH PROPERTY FROM SETTLING, CRACKING, EROSION, SILTING, SCOUR OR OTHER DAMAGE WHICH MIGHT RESULT FROM GRADING DESCRIBED ON THIS PLAN. THE CITY WILL HOLD THE PERMITTEE RESPONSIBLE FOR CORRECTION ON NON-DEDICATED IMPROVEMENTS WHICH DAMAGE ADJACENT PROPERTY.
- ALL OFFSITE HAUL ROUTES ARE SUBJECT TO THE ACCEPTANCE OF THE CITY ENGINEER. THE CONTRACTOR SHALL MAKE APPLICATION FOR A HAUL PERMIT, IN A FORMAT SUITABLE TO THE DEPARTMENT OF DEVELOPMENT SERVICES, A MINIMUM OF 72 HOURS PRIOR TO BEGINNING WORK. THE GRADING PERMIT SHALL NOT BE ISSUED PRIOR TO ISSUANCE OF THE HAUL PERMIT.
- SPECIAL CONDITIONS: IF ANY ARCHAEOLOGICAL RESOURCES ARE DISCOVERED ON THE SITE OF THIS GRADING DURING GRADING OPERATIONS, SUCH OPERATIONS WILL CEASE IMMEDIATELY, AND THE PERMITTEE WILL NOTIFY THE CITY ENGINEER OF THE DISCOVERY. GRADING OPERATIONS WILL NOT COMMENCE UNTIL THE PERMITTEE HAS RECEIVED WRITTEN AUTHORITY FROM THE CITY ENGINEER TO DO SO.
- ALL GRADING SHOWN ON THESE PLANS SHALL BE COMPLETED AS A SINGULAR UNIT WITH NO PROVISION FOR PARTIAL RELEASES. IF ANY PORTION OF THIS PROJECT IS TO BE COMPLETED SEPARATELY, A SEPARATE PLAN AND PERMIT APPLICATION SHALL BE SUBMITTED FOR ACCEPTANCE.
- FINISH GRADING AND PLANTING SHALL BE ACCOMPLISHED ON ALL SLOPES PRIOR TO OCTOBER 1 OR IMMEDIATELY UPON COMPLETION OF ANY SLOPES BETWEEN OCTOBER 1 AND APRIL 1. ALL LANDSCAPING SHALL BE DONE IN ACCORDANCE WITH THE ACCEPTED LANDSCAPING AND IRRIGATION PLANS.
- THE CONTRACTOR SHALL NOTIFY THE CITY OF SANTEE-DEPARTMENT OF DEVELOPMENT SERVICES AT (619) 258-4100 A MINIMUM OF 48 HOURS BEFORE ANY WORK COMMENCES AND 24 HOURS PRIOR TO REQUESTS FOR INSPECTION. CALL (619) 258-4100 x 168 FOR ALL INSPECTION REQUESTS. ALL WORK PERFORMED UNDER THIS PERMIT IS SUBJECT TO THE INSPECTION REQUIREMENTS OF THE SANTEE GRADING ORDINANCE. THE CONTRACTOR IS REFERRED TO SECTION 15.58.930 OF THE SANTEE MUNICIPAL CODE FOR A LIST OF DETAILED INSPECTION REQUIREMENTS. FAILURE TO PROVIDE ADEQUATE NOTIFICATION TO THE DEPARTMENT OF DEVELOPMENT SERVICES REQUESTING INSPECTION OF THE WORK AT THE APPROPRIATE TIMES MAY RESULT IN ISSUANCE OF A STOP WORK ORDER FOR THE GRADING OPERATIONS.

GRADING PLAN NOTES

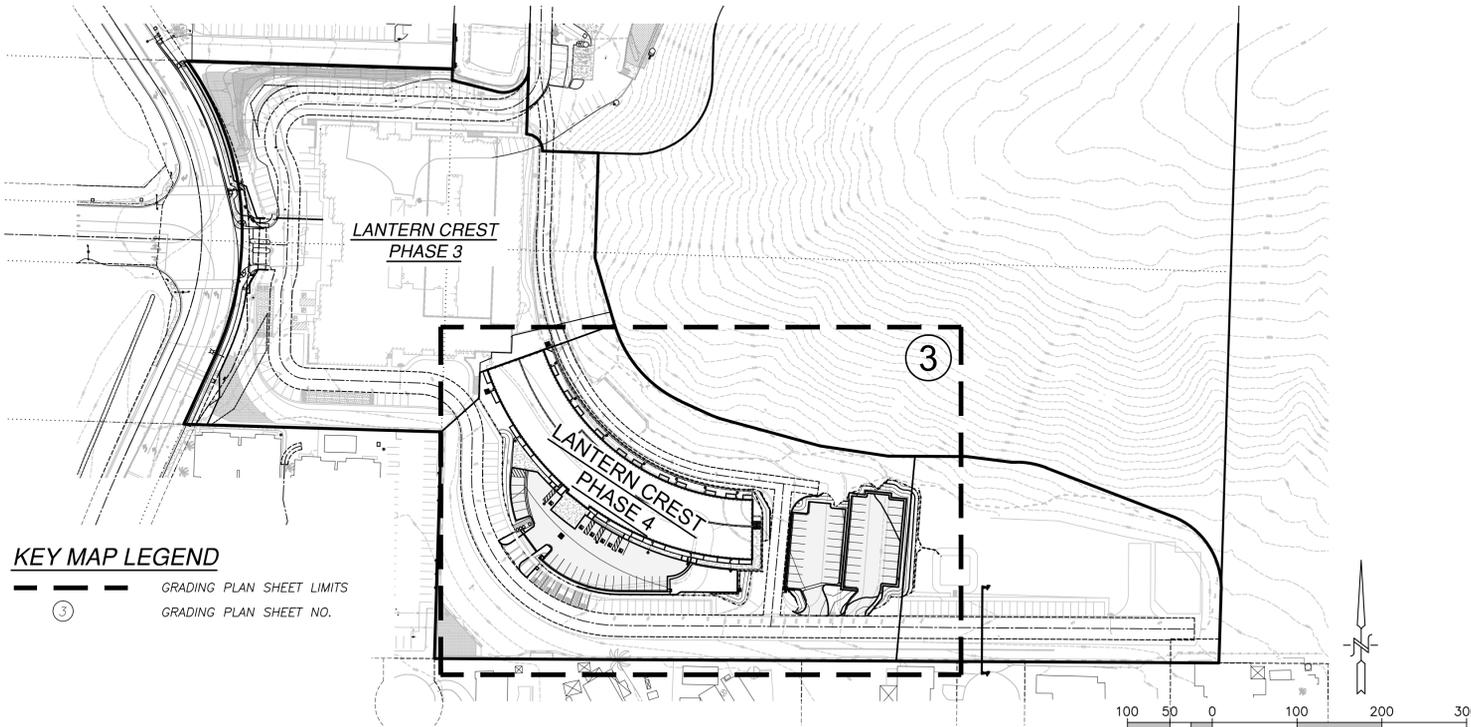

KEY MAP LEGEND

- Grading Plan Sheet Limits
- Grading Plan Sheet No.

KEY MAP

SCALE: 1" = 100'

GENERAL NOTES CONT:

- TO ENSURE COMPLIANCE WITH THE ACCEPTED GRADING PLAN AND AS A CONDITION OF ACCEPTANCE OF THE GRADING PLAN, THE OWNER, ITS TENANTS, ITS CONTRACTORS, AND ITS SUB-CONTRACTORS SHALL MAINTAIN THE PREMISES SUBJECT TO THE GRADING PLAN OPEN FOR INSPECTION BY CITY REPRESENTATIVES AT ALL TIMES GRADING OPERATIONS ARE OCCURRING, AND AT ALL OTHER TIMES, UPON REASONABLE DEMAND BY THE CITY.
- UPON COMPLETION OF THE GRADING WORK SHOWN ON THESE PLANS AND PRIOR TO FINAL ACCEPTANCE OF THE WORK BY THE CITY, THE OWNER SHALL HAVE AS-BUILT GRADING PLANS PREPARED. PLANS SHALL BE PREPARED IN ACCORDANCE WITH THE CITY OF SANTEE-DEPARTMENT OF DEVELOPMENT SERVICES POLICY REGARDING CONSTRUCTION CHANGES AND AS-BUILT DRAWINGS FOR PRIVATE DEVELOPMENT.
- SLOPE RATIOS:
 CUT 1.5:1 FILL 2:1
 EXCAVATION: 6.400 C.Y. FILL: 1.200 C.Y. WASTE/IMPORT: 4.200 C.Y.
 (Note: A separate valid permit must exist for either waste or import areas).
 SHRINKAGE/EXPANSION 10 %
- ACCEPTANCE OF THESE PLANS BY THE CITY OF SANTEE IS VALID FOR ONE YEAR FROM THE DATE OF ACCEPTANCE. FAILURE TO COMMENCE CONSTRUCTION WITHIN ONE YEAR VOIDS ACCEPTANCE OF THE PLANS.
- THE FOLLOWING SOILS REPORT(S) SHALL BE CONSIDERED PART OF THIS GRADING PLAN. ALL GRADING SHALL BE DONE IN ACCORDANCE WITH THE RECOMMENDATIONS AND SPECIFICATIONS CONTAINED IN SAID REPORT(S).
 A) REPORT OF GEOTECHNICAL INVESTIGATION FOR LANTERN CREST PHASE III, SANTEE, CALIFORNIA, DATED JUNE 9, 2017, PREPARED BY GROUP DELTA, INC.
 B) ADDENDUM #1 - BOULDER HAZARD ANALYSIS FOR LANTERN CREST PHASE III, SANTEE, CALIFORNIA, DATED AUGUST 30, 2017, PREPARED BY GROUP DELTA, INC.
 C) AS-GRADED GEOTECHNICAL REPORT FOR LANTERN CREST PHASE III, SANTEE CALIFORNIA, DATED OCTOBER 8, 2019, PREPARED BY GROUP DELTA, INC.
 D) ADDENDUM FOR BIO-RETENTION BASIN INFILTRATION FOR LANTERN CREST PHASE III, SANTEE CALIFORNIA, DATED MAY 3, 2018, PREPARED BY GROUP DELTA, INC.
 E) PERMEABLE INTERLOCKING CONCRETE PAVEMENT RECOMMENDATIONS FOR LANTERN CREST PHASE III, SANTEE CALIFORNIA, DATED JANUARY 15, 2020, PREPARED BY GROUP DELTA, INC.
 F) ACCEPTANCE OF GEOTECHNICAL ENGINEER OF RECORD RESPONSIBILITY LANTERN CREST SANTEE PHASE 4 AND 5 CONSTRUCTION SERVICES DATED JULY 12TH, 2022, PREPARED BY PARTNER ASSESSMENT CORPORATION

SLOPE PLANTING NOTES

- THE CITY REQUIRES IMMEDIATE PLANTING OF ALL SLOPES WITHIN SIXTY DAYS FOLLOWING INSTALLATION OF WATER MAINS TO SERVE THE PROJECT.
- SLOPE PLANTING SHALL BE FULLY ESTABLISHED PRIOR TO OCCUPANCY OF ANY UNIT.

PAVING NOTES

- A MINIMUM OF SEVEN DAYS PRIOR TO THE PLACEMENT OF ROADWAY BASE MATERIAL THE CONTRACTOR SHALL SUBMIT A CERTIFIED SOILS REPORT FROM A REGISTERED CIVIL OR GEOTECHNICAL ENGINEER CERTIFYING ALL ROADWAY AND UTILITY TRENCHING HAS BEEN COMPACTED TO THE MINIMUM REQUIREMENTS SPECIFIED IN THE STANDARD SPECIFICATIONS FOR PUBLIC WORKS CONSTRUCTION AND THE RECOMMENDATIONS CONTAINED IN THE PROJECT'S SOILS REPORT.
- A FINAL PAVEMENT STRUCTURAL SECTION SHALL BE SUBMITTED TO THE CITY ENGINEER FOR APPROVAL A MINIMUM OF TEN DAYS PRIOR TO PLACEMENT OF BASE MATERIAL. THE DESIGN REPORT SHALL CONFORM TO CITY FORM 435 - PAVEMENT DESIGN AND R-VALUE TEST SUBMITTAL PROCEDURES. THE DESIGN SHALL ADHERE TO THE METHODOLOGY SET FORTH IN CHAPTER 600 OF THE CALTRANS HIGHWAY DESIGN MANUAL AND UTILIZE THE "R" VALUE METHOD. DESIGN SHALL BE SUBMITTED IN REPORT FORM AND MUST INCLUDE ALL SUPPORTING CALCULATIONS AND TEST RESULTS. THE "R" VALUE TESTS SHALL BE CONDUCTED IN ACCORDANCE WITH CALIFORNIA TEST NO. 301 AND SHALL BE PERFORMED BY A REGISTERED CIVIL ENGINEER WHOSE PRIMARY PROFESSIONAL ACTIVITY IS PERFORMING SUCH TESTS. THE NUMBER AND LOCATION OF R-VALUE TESTS SHALL BE COORDINATED WITH THE CITY PROJECT INSPECTOR AND BE SUBJECT TO APPROVAL OF THE CITY PROJECT ENGINEER.
- THE FOLLOWING MINIMUM STRUCTURAL THICKNESS ARE BASED ON AN R-VALUE OF 30. TRAFFIC INDEXES ARE BASED ON CITY PUBLIC WORKS STANDARDS AND SHALL BE USED FOR PAVEMENT DESIGN BASED ON ACTUAL R-VALUES OBTAINED AT TIME OF CONSTRUCTION.

STREET NAME	TRAFFIC INDEX	ANTICIPATED STRUCT. SECTION
A. PASSENGER CAR PARKING	5.0	3" AC / 5" AB
B. TRUCK TRAFFIC AREAS	6.0	4" AC / 5" AB
C. HEAVY TRAFFIC AREAS	7.0	4" AC / 7" AB

THE MINIMUM SECTIONS LISTED ABOVE ARE FOR ESTIMATION AND DESIGN PURPOSES ONLY AND ARE SUBJECT TO CHANGE FOLLOWING SUBMITTAL OF THE FINAL PAVEMENT DESIGN REPORT.

ASPHALT CONCRETE SHALL CONFORM TO ALL PROVISIONS OF SECTION 39 OF THE CURRENT CALTRANS STANDARD SPECIFICATIONS. SURFACE COURSE SHALL BE A MINIMUM THICKNESS IS 2 INCHES, MAXIMUM THICKNESS IS 3 INCHES. ASPHALT CONCRETE SECTIONS GREATER THAN 3 INCHES SHALL CONTAIN A BASE COURSE OF ASPHALT, A MINIMUM THICKNESS OF 2 INCHES.

ACCEPTED UNTREATED BASE MATERIALS INCLUDE:
 PER SECTION 200-2.2 CRUSHED AGGREGATE BASE
 PER SECTION 200-2.4 CRUSHED MISCELLANEOUS BASE
 CALTRANS CLASS 2 - AGGREGATE BASE

4. PROCESSED MISCELLANEOUS BASE PER THE GREEN BOOK AND CALTRANS CLASS 2 RECYCLED BASE ARE NOT PERMITTED.

ACCEPTED ASPHALT BASE COURSE MIXES INCLUDE:
 PER CALTRANS 39 PG 64-10 - 3/4" MAXIMUM, COARSE

ACCEPTED ASPHALT SURFACE COURSE MIXES INCLUDE:
 PER CALTRANS 39 PG 64-10 - 1/2" MAXIMUM, COARSE

EASEMENT NOTES

- AN EASEMENT TO THE CITY OF SANTEE, FOR THE PURPOSE OF CONSERVATION, RECORDED FEBRUARY 10, 2006, AS INSTRUMENT/ FILE NO. 2006-0100586 OF OFFICIAL RECORDS.
- A DOCUMENT ENTITLED EXCLUSIVE EASEMENT AGREEMENT* DATED, JULY 5, 2006, EXECUTED BY LANTERN CREST, LLC, A CALIFORNIA LIMITED LIABILITY COMPANY AND WILLIAM ROBERT JEWETT AND JOLYNN TERESA JEWETT, HUSBAND AND WIFE, AS JOINT TENANTS, RECORDED JULY 6, 2006 AS INSTRUMENT NO. 2006-0477456 OF OFFICIAL RECORDS.
- EASEMENT FOR THE PURPOSE SHOWN BELOW AND RIGHTS INCIDENTAL THERETO AS SHOWN OR AS OFFERED FOR DEDICATION ON THE RECORDED MAP SHOWN BELOW. PARCEL MAP NO. 20858
 A. EASEMENT PURPOSE: FIRE AND EMERGENCY VEHICLE ACCESS
 B. EASEMENT PURPOSE: PROPOSED PRIVATE ROAD AND UTILITY
- PROPOSED EASEMENT FOR FIRE AND EMERGENCY VEHICLE ACCESS AND PROPOSED PRIVATE ROAD AND UTILITIES



GENERAL STANDARDS OF CONSTRUCTION

UNLESS OTHERWISE NOTED ON THE PLANS, ALL WORK SHALL CONFORM WITH THE FOLLOWING STANDARD SPECIFICATIONS AND DRAWINGS:

- STANDARD SPECIFICATIONS:
 1. STANDARD SPECIFICATIONS FOR PUBLIC WORKS CONSTRUCTION, LATEST EDITION.
 2. STANDARD SPECIAL PROVISIONS.
 3. CITY OF SANTEE PUBLIC WORKS STANDARDS, SEPTEMBER 1982.
 4. CALIFORNIA DEPARTMENT OF TRANSPORTATION, "MANUAL ON TRAFFIC CONTROLS FOR CONSTRUCTION AND MAINTENANCE WORK ZONES," LATEST EDITION.
 5. STANDARD SPECIFICATIONS OF THE PADRE DAM MUNICIPAL WATER DISTRICT, WATER AGENCY STANDARDS W.A.S.
 6. CALIFORNIA STORMWATER QUALITY ASSOCIATION (CASQA), STORMWATER BEST MANAGEMENT PRACTICE HANDBOOK CONSTRUCTION, LATEST EDITION.

STANDARD DRAWINGS

- CITY OF SANTEE STANDARD DRAWINGS.
- SAN DIEGO REGIONAL STANDARD DRAWINGS (SDRSD) AS RECOMMENDED BY THE REGIONAL STANDARDS COMMITTEE, MAINTAINED AND PUBLISHED BY THE SAN DIEGO COUNTY DEPARTMENT OF PUBLIC WORKS, LATEST EDITION.
- STANDARD DRAWINGS OF THE PADRE DAM MUNICIPAL WATER DISTRICT WATER AGENCY STANDARDS W.A.S.




LEGEND

SYMBOL	STD. DWG. NO.	DESCRIPTION
---	-	RIGHT OF WAY/LOT LINE
---	-	EXISTING LOT LINE
---	-	EXISTING CURB & GUTTER
---	-	EXISTING AC BERM
---	-	EXISTING SIDEWALK
---	-	EXISTING POTABLE WATERLINE
---	-	EXISTING SEWERLINE
---	-	EXISTING SEWER MANHOLE/CLEANOUT
---	-	EXISTING STORM DRAIN
---	-	EXISTING STREET LIGHT
---	-	EXISTING FIRE HYDRANT
---	-	EXISTING CONTOUR
---	-	EXISTING FENCE
---	-	CONTOUR
---	-	DAYLIGHT LINE
---	G-29	CURB RAMP
---	G-7	4" THICK SIDEWALK
---	-	AC PAVING PER SOILS ENGINEER (SEE PAVING NOTES)
---	G-1	6" CONCRETE CURB
---	G-2	6" CONCRETE CURB AND GUTTER
---	D-30	STRAIGHT HEADWALL
---	D-34	U TYPE HEADWALL
---	D-2,3A	TYPE 'B' CURB INLET
---	D-7	TYPE 'C' CATCH BASIN
---	D-9	TYPE 'A-4' STORM DRAIN CLEANOUT
---	-	12" NDS CATCH BASIN
---	D-25	TYPE 'A' CURB OUTLET
---	(MANUF. RECOMM.)	STORM DRAIN PIPE (SIZE PER PLAN)
---	-	4" WIDE CPS 100 TRENCH DRAIN (TRAFFIC RATED)
---	G-12	3' WIDE RIBBON GUTTER
---	-	DRAINAGE DIRECTION & SLOPE
---	D-75B	BROW DITCH
---	-	MODULAR WETLAND SYSTEM (MWS-L-8-20)
---	-	PVC WATER C900 (CL 305) - SIZE PER PLAN
---	-	6" PVC SEWER (SDR 35)
---	-	6" SEWER CLEANOUT
---	-	RETAINING WALL PER PLAN
---	-	BUILDING FOUNDATION WALL PER ARCHITECTURAL PLANS*
---	-	NUMBER OF PARKING SPACES IN ADJACENT SECTION
---	-	PROPOSED BOTTOM OF WALL ELEVATION
---	-	PROPOSED FINISH GRADE ELEVATION
---	-	PROPOSED FLOWLINE ELEVATION
---	-	PROPOSED TOP OF GRATE ELEVATION
---	-	PROPOSED GUTTER ELEVATION
---	-	PROPOSED PIPE INVERT ELEVATION
---	-	PROPOSED TOP OF CURB ELEVATION
---	-	PROPOSED TOP OF FOOTING ELEVATION
---	-	PROPOSED TOP OF WALL ELEVATION
---	-	PROPOSED FINISH SURFACE ELEVATION - HIGH SIDE
---	-	PROPOSED FINISH SURFACE ELEVATION - LOW SIDE

*NOT A PART OF THIS PERMIT APPROVAL - REFER TO BUILDING DEPARTMENT PERMIT.

CONSTRUCTION RECORD	REFERENCES	DATE	BY	REVISIONS	ACPTD	BENCH MARK	SCALE	DESIGNED BY	DRAWN BY	CHECKED BY	REVIEWED	CITY OF SANTEE	DEPARTMENT OF DEVELOPMENT SERVICES	CITY W.O. NO.	DRAWING NO.
CONTRACTOR	556W, 2254WS, 2255WS, 2263WS					CITY OF SANTEE VERTICAL CONTROL MONUMENT	HORIZ: 1"=100'	J.M.W.	J.M.W.	J.R.R.		GRADING PLANS FOR:			
INSPECTOR	2011-026, 2011-037, 2013-015,					#2076 PER R.O.S. 11252, LOCATED AT THE INTERSECTION	VERT: N/A				BY	LANTERN CREST - PHASE 4		G-1383	2022-
DATE COMPLETED	2016-163, 2016-183, 2016-352					OF PROSPECT AVENUE & ARGENT STREET		RCE NO. 64811	DATE	EXPIRES	PROJECT ENGINEER		P2007-12		SHEET 2 OF 18
	G-1281					ELEVATION: 346.35 FEET (MSL)			6-30-2023						

STORM DRAIN DATA TABLE #				
#	BEARING/Delta	RADIUS	LENGTH	NOTES
L1	N 51°48'35" W	3.72'	12"	PVC SD LINE "E"
L2	N 28°25'37" E	1.64'	12"	PVC SD LINE "D"
L3	N 89°38'47" E	78.62'	12"	PVC SD LINE "A"
L4	N 54°24'35" W	70.05'	12"	PVC WITH 2 SACK SLURRY BACKFILL
L5	N 16°34'13" E	10.19'	18"	PVC SD LINE "C"
L6	N 41°54'20" W	39.74'	24"	PVC WITH 2 SACK SLURRY BACKFILL
L7	N 06°15'51" E	6.30'	6"	PVC SD LINE "B"
L8	N 04°02'39" E	14.21'	18"	PVC SD LINE "B"
L9	N 42°15'43" E	30.48'	12"	PVC SD LINE "C"
L10	N 29°29'39" W	64.68'	12"	PVC SD LINE "F"
L11	N 24°58'39" W	81.27'	12"	PVC SD LINE "F"
L12	N 26°51'49" W	41.06'	12"	PVC SD LINE "F"
L13	N 81°01'59" W	40.63'	12"	PVC SD LINE "F"
L14	N 78°32'59" W	61.55'	12"	PVC SD LINE "F"
L15	N 73°55'07" W	48.78'	12"	PVC SD LINE "F"
L16	N 81°03'00" W	51.20'	12"	PVC SD LINE "F"
L17	N 65°09'29" E	13.61'	12"	PVC SD LINE "G"
L18	N 22°45'30" W	22.13'	12"	PVC SD LINE "G"
L19	N 29°06'25" W	47.54'	12"	PVC SD LINE "G"
L20	N 40°39'12" W	56.99'	12"	PVC SD LINE "G"
L21	N 53°04'07" W	55.27'	12"	PVC SD LINE "G"
L22	N 64°35'42" W	42.25'	12"	PVC SD LINE "G"
L23	N 73°24'35" W	35.27'	12"	PVC SD LINE "G"
L24	N 81°12'08" W	38.35'	12"	PVC SD LINE "G"

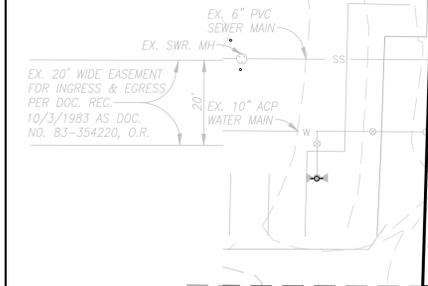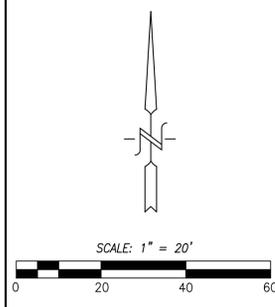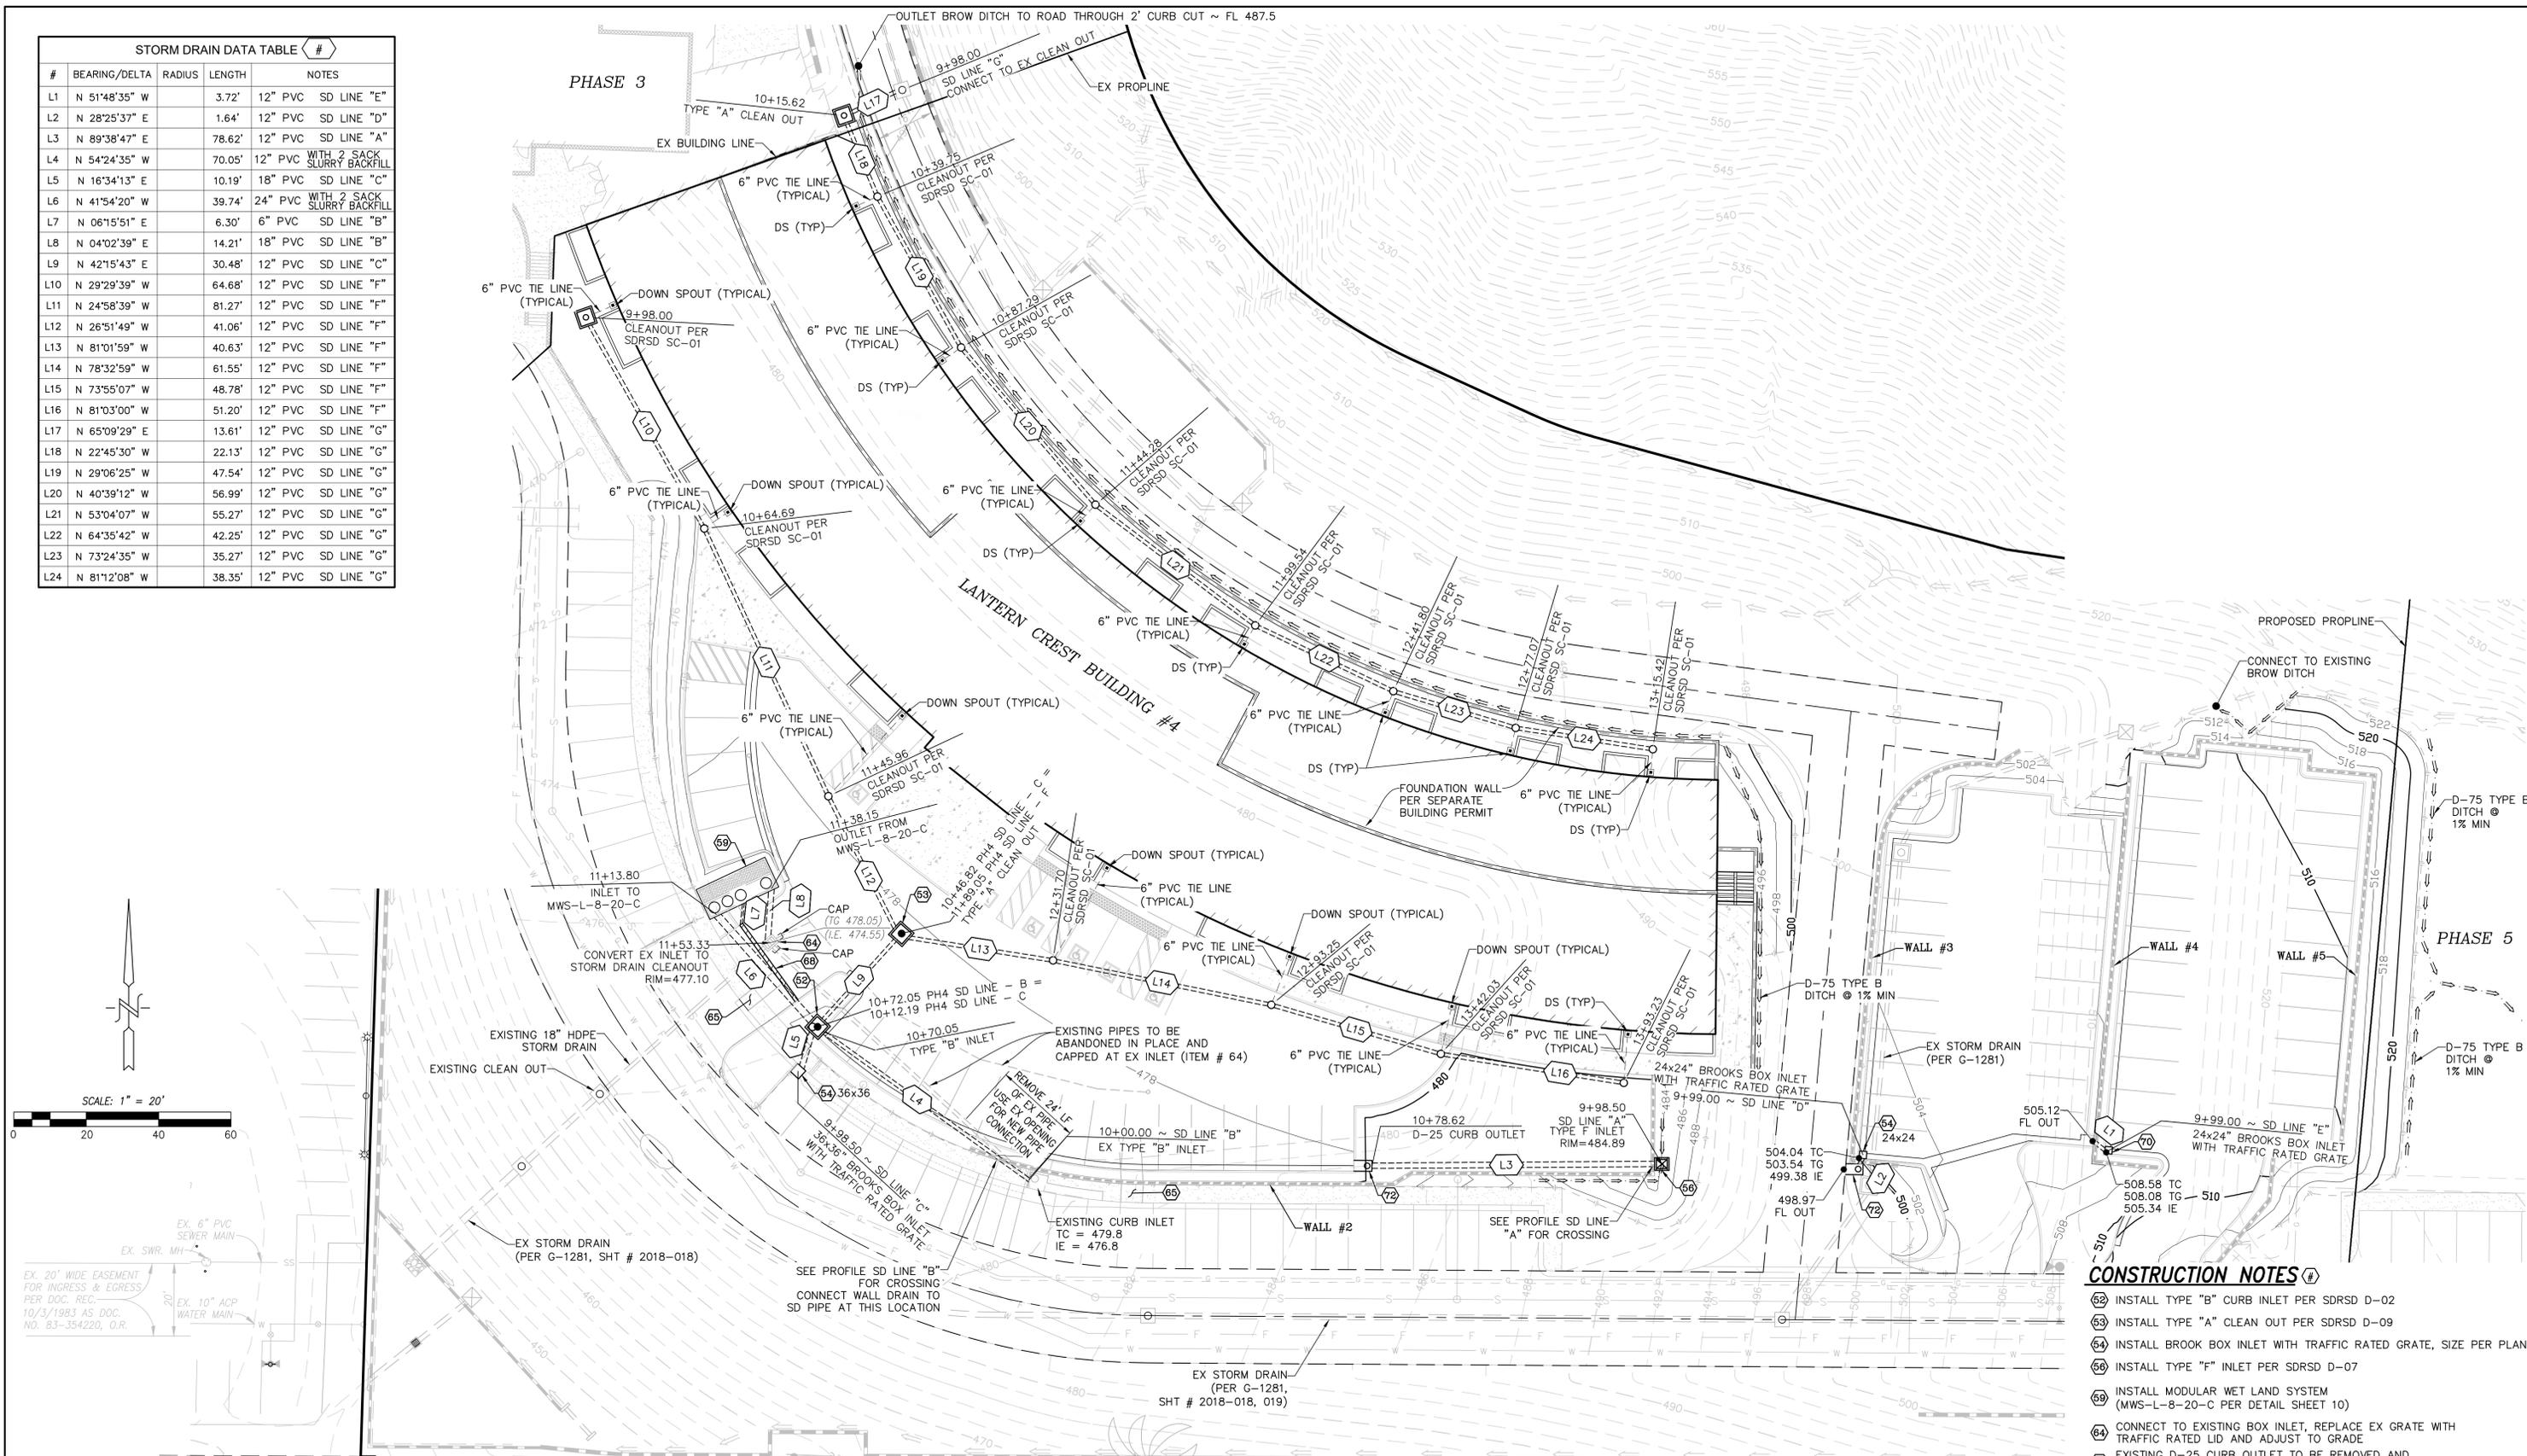

- CONSTRUCTION NOTES #**
- 62 INSTALL TYPE "B" CURB INLET PER SDRSD D-02
 - 63 INSTALL TYPE "A" CLEAN OUT PER SDRSD D-09
 - 64 INSTALL BROOK BOX INLET WITH TRAFFIC RATED GRATE, SIZE PER PLAN
 - 65 INSTALL TYPE "F" INLET PER SDRSD D-07
 - 66 INSTALL MODULAR WET LAND SYSTEM (MWS-L-8-20-C PER DETAIL SHEET 10)
 - 67 CONNECT TO EXISTING BOX INLET, REPLACE EX GRATE WITH TRAFFIC RATED LID AND ADJUST TO GRADE
 - 68 EXISTING D-25 CURB OUTLET TO BE REMOVED AND REPLACED WITH 4" PCC SIDEWALK PER SDRSD G-07
 - 69 4" WIDE CPS 100 TRENCH DRAIN (TRAFFIC RATED)
 - 70 INSTALL 24x24 BROOK BOX INLET WITH TRAFFIC RATED GRATE WITH 12" PVC OUTLET THROUGH WALL
 - 72 INSTALL CURB OUTLET, PER SDRSD D-25

REC Civil Engineering-Environmental Land Surveying
 2442 Second Avenue
 San Diego, CA 92101
 Consultants, Inc. (619)232-9200 (619)232-9210 Fax



CONSTRUCTION RECORD	REFERENCES	DATE	BY	REVISIONS	ACPTD	BENCH MARK	SCALE	DESIGNED BY	DRAWN BY	CHECKED BY	REVIEWED	CITY OF SANTEE	DEPARTMENT OF DEVELOPMENT SERVICES	CITY W.O. NO.	DRAWING NO.
CONTRACTOR INSPECTOR DATE COMPLETED	556W, 2254WS, 2255WS, 2263WS 2011-026, 2011-037, 2013-015 2016-163, 2016-183, 2016-352 G-1281					CITY OF SANTEE VERTICAL CONTROL MONUMENT #2076 PER R.O.S. 11252, LOCATED AT THE INTERSECTION OF PROSPECT AVENUE & ARGENT STREET ELEVATION: 346.35 FEET (MSL)	HORIZ: 1" = 20' VERT: 1" = 8'	J.M.W. PLANS PREPARED UNDER THE SUPERVISION OF RCE NO. 64811	J.M.W.	J.R.R.		CITY OF SANTEE GRADING PLANS FOR: LANTERN CREST - PHASE 4	P2007-12	G-1383	2022- SHEET 4 OF 18

CONSTRUCTION NOTES



69 INSTALL MASONRY RETAINING WALL PER SDRSD (TYPE AS SHOWN)

PHASE 3

SEE SHEET 7 FOR CROSS SECTIONS

NOTES:
 1. SEE SHEET 7, FOR WALL PROFILES
 2. 5' CABLE RAILING FALL-OFF PROTECTION REQUIRED AT THE TOP OF ALL WALLS, SEE PLANS FOR DETAILS


NOTE:
 ALL WALLS TO BE CONSTRUCTED OVER THE EXISTING STORM DRAIN - CONCRETE ENCASE WITH 2 SACK SLURRY BACKFILL

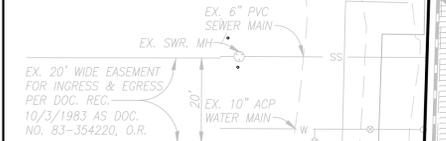
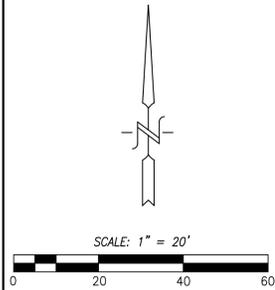


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CONSTRUCTION RECORD	REFERENCES	DATE	BY	REVISIONS	ACPTD	BENCH MARK	SCALE	DESIGNED BY	DRAWN BY	CHECKED BY	REVIEWED	CITY OF SANTEE	DEPARTMENT OF DEVELOPMENT SERVICES	CITY W.O. NO.	DRAWING NO.
CONTRACTOR	556W, 2254WS, 2255WS, 2263WS					CITY OF SANTEE VERTICAL CONTROL MONUMENT	HORIZ: 1" = 20'	J.M.W.	J.M.W.	J.R.R.		GRADING PLANS FOR:			
INSPECTOR	2011-026, 2011-037, 2013-015					#2076 PER R.O.S. 11252, LOCATED AT THE INTERSECTION OF PROSPECT AVENUE & ARGENT STREET	VERT: N/A	PLANS PREPARED UNDER THE SUPERVISION OF				LANTERN CREST - PHASE 4		G-1383	2022-
DATE COMPLETED	2016-163, 2016-183, 2016-352					ELEVATION: 346.35 FEET (MSL)		RCE NO. 64811	DATE EXPIRES 8-30-2023		BY: PROJECT ENGINEER	P2007-12			SHEET 6 OF 18



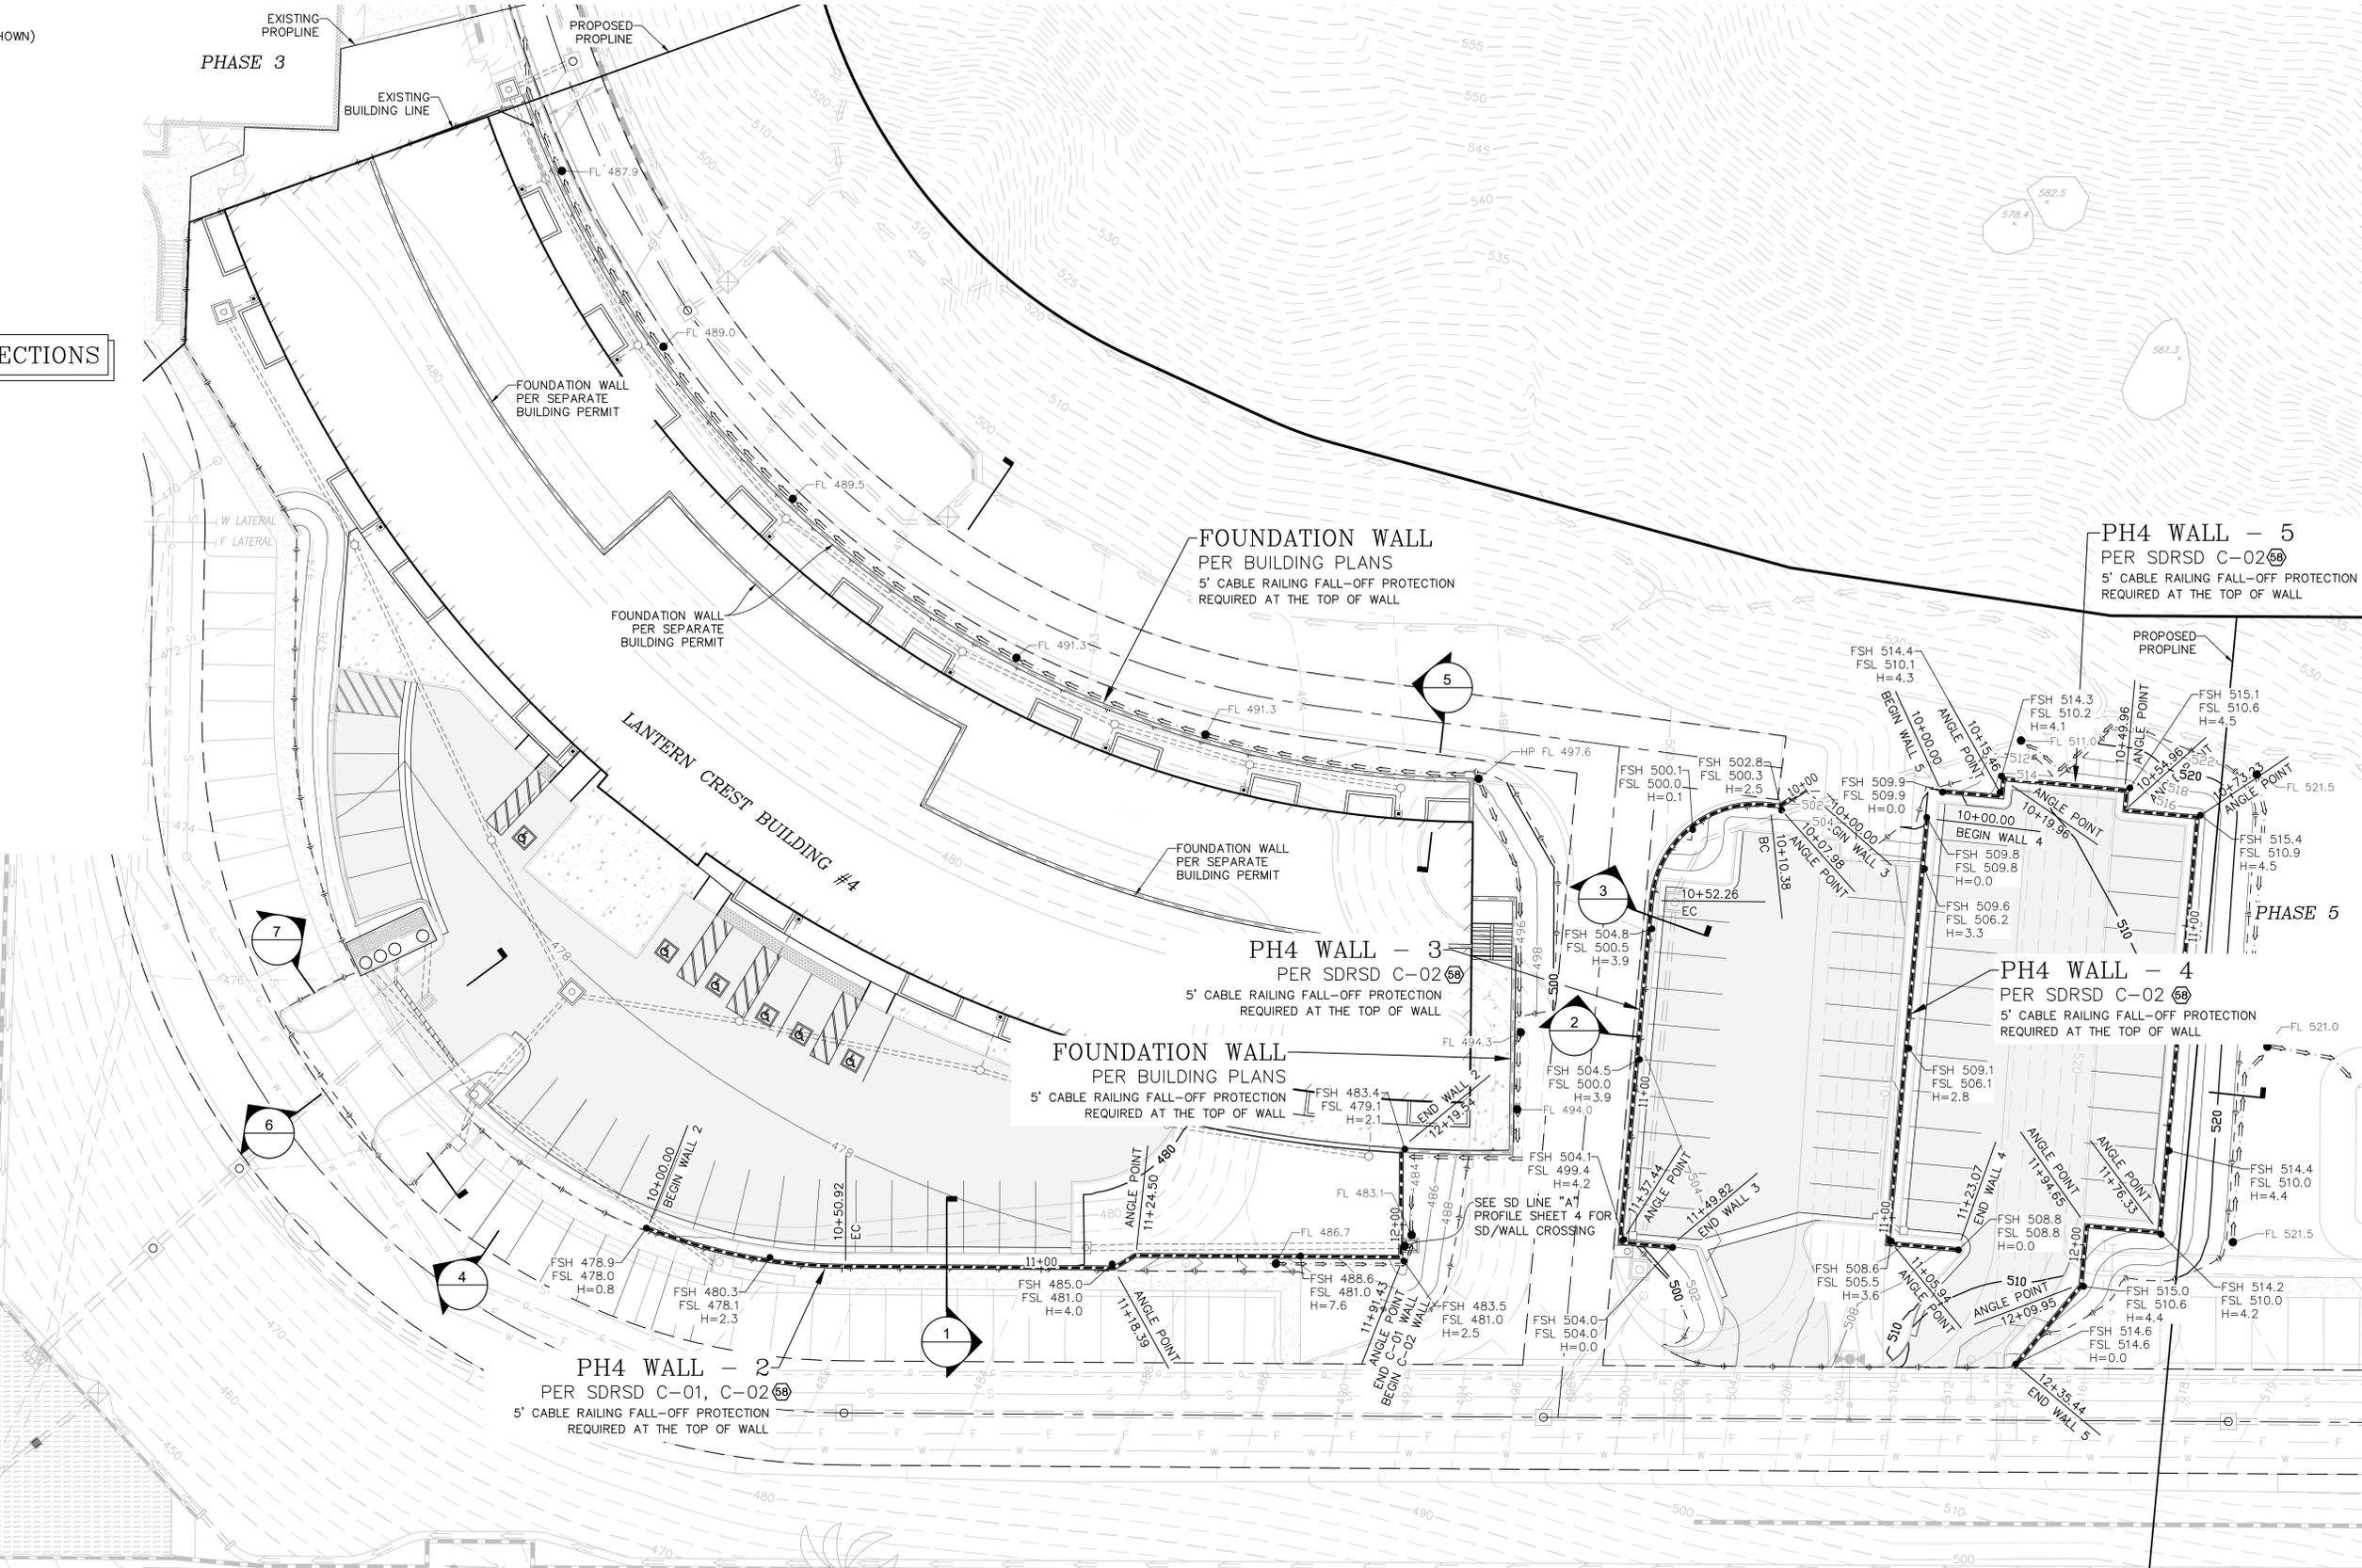

6" PCC CURB (SDRSD G-01)			
#	BEARING/DELTA	RADIUS	LENGTH
C1	Δ = 103°05'24"	2.00'	3.60'
C2	Δ = 38°05'10"	8.49'	5.64'
C3	Δ = 39°26'55"	11.80'	8.13'
C4	Δ = 78°21'22"	3.00'	4.10'
C7	Δ = 27°36'50"	124.66'	60.08'
C8	Δ = 6°48'28"	345.57'	41.06'
C9	Δ = 5°38'27"	369.35'	36.36'
C10	Δ = 22°39'30"	346.18'	136.90'
C11	Δ = 66°06'33"	27.64'	31.89'
C14	Δ = 75°32'26"	3.00'	3.96'
C15	Δ = 99°27'54"	8.00'	13.89'
C16	Δ = 2°29'28"	162.00'	7.04'
C17	Δ = 90°42'58"	2.00'	3.17'
C18	Δ = 146°55'01"	10.00'	25.64'
C21	Δ = 90°00'00"	2.00'	3.14'
C22	Δ = 117°24'02"	5.00'	10.25'
C23	Δ = 22°35'41"	44.00'	17.35'
C24	Δ = 42°27'28"	6.00'	4.45'
C25	Δ = 37°31'12"	34.00'	22.26'
C26	Δ = 90°00'00"	2.00'	3.14'
C27	Δ = 90°00'00"	2.00'	3.14'
C28	Δ = 90°00'00"	2.00'	3.14'
C32	Δ = 78°58'50"	10.00'	13.78'
L1	S 62°16'37" W		15.60'
L2	N 54°59'55" E		7.21'
L9	N 53°58'04" E		6.29'
L10	N 36°01'56" W		5.12'
L11	S 36°01'56" E		4.55'

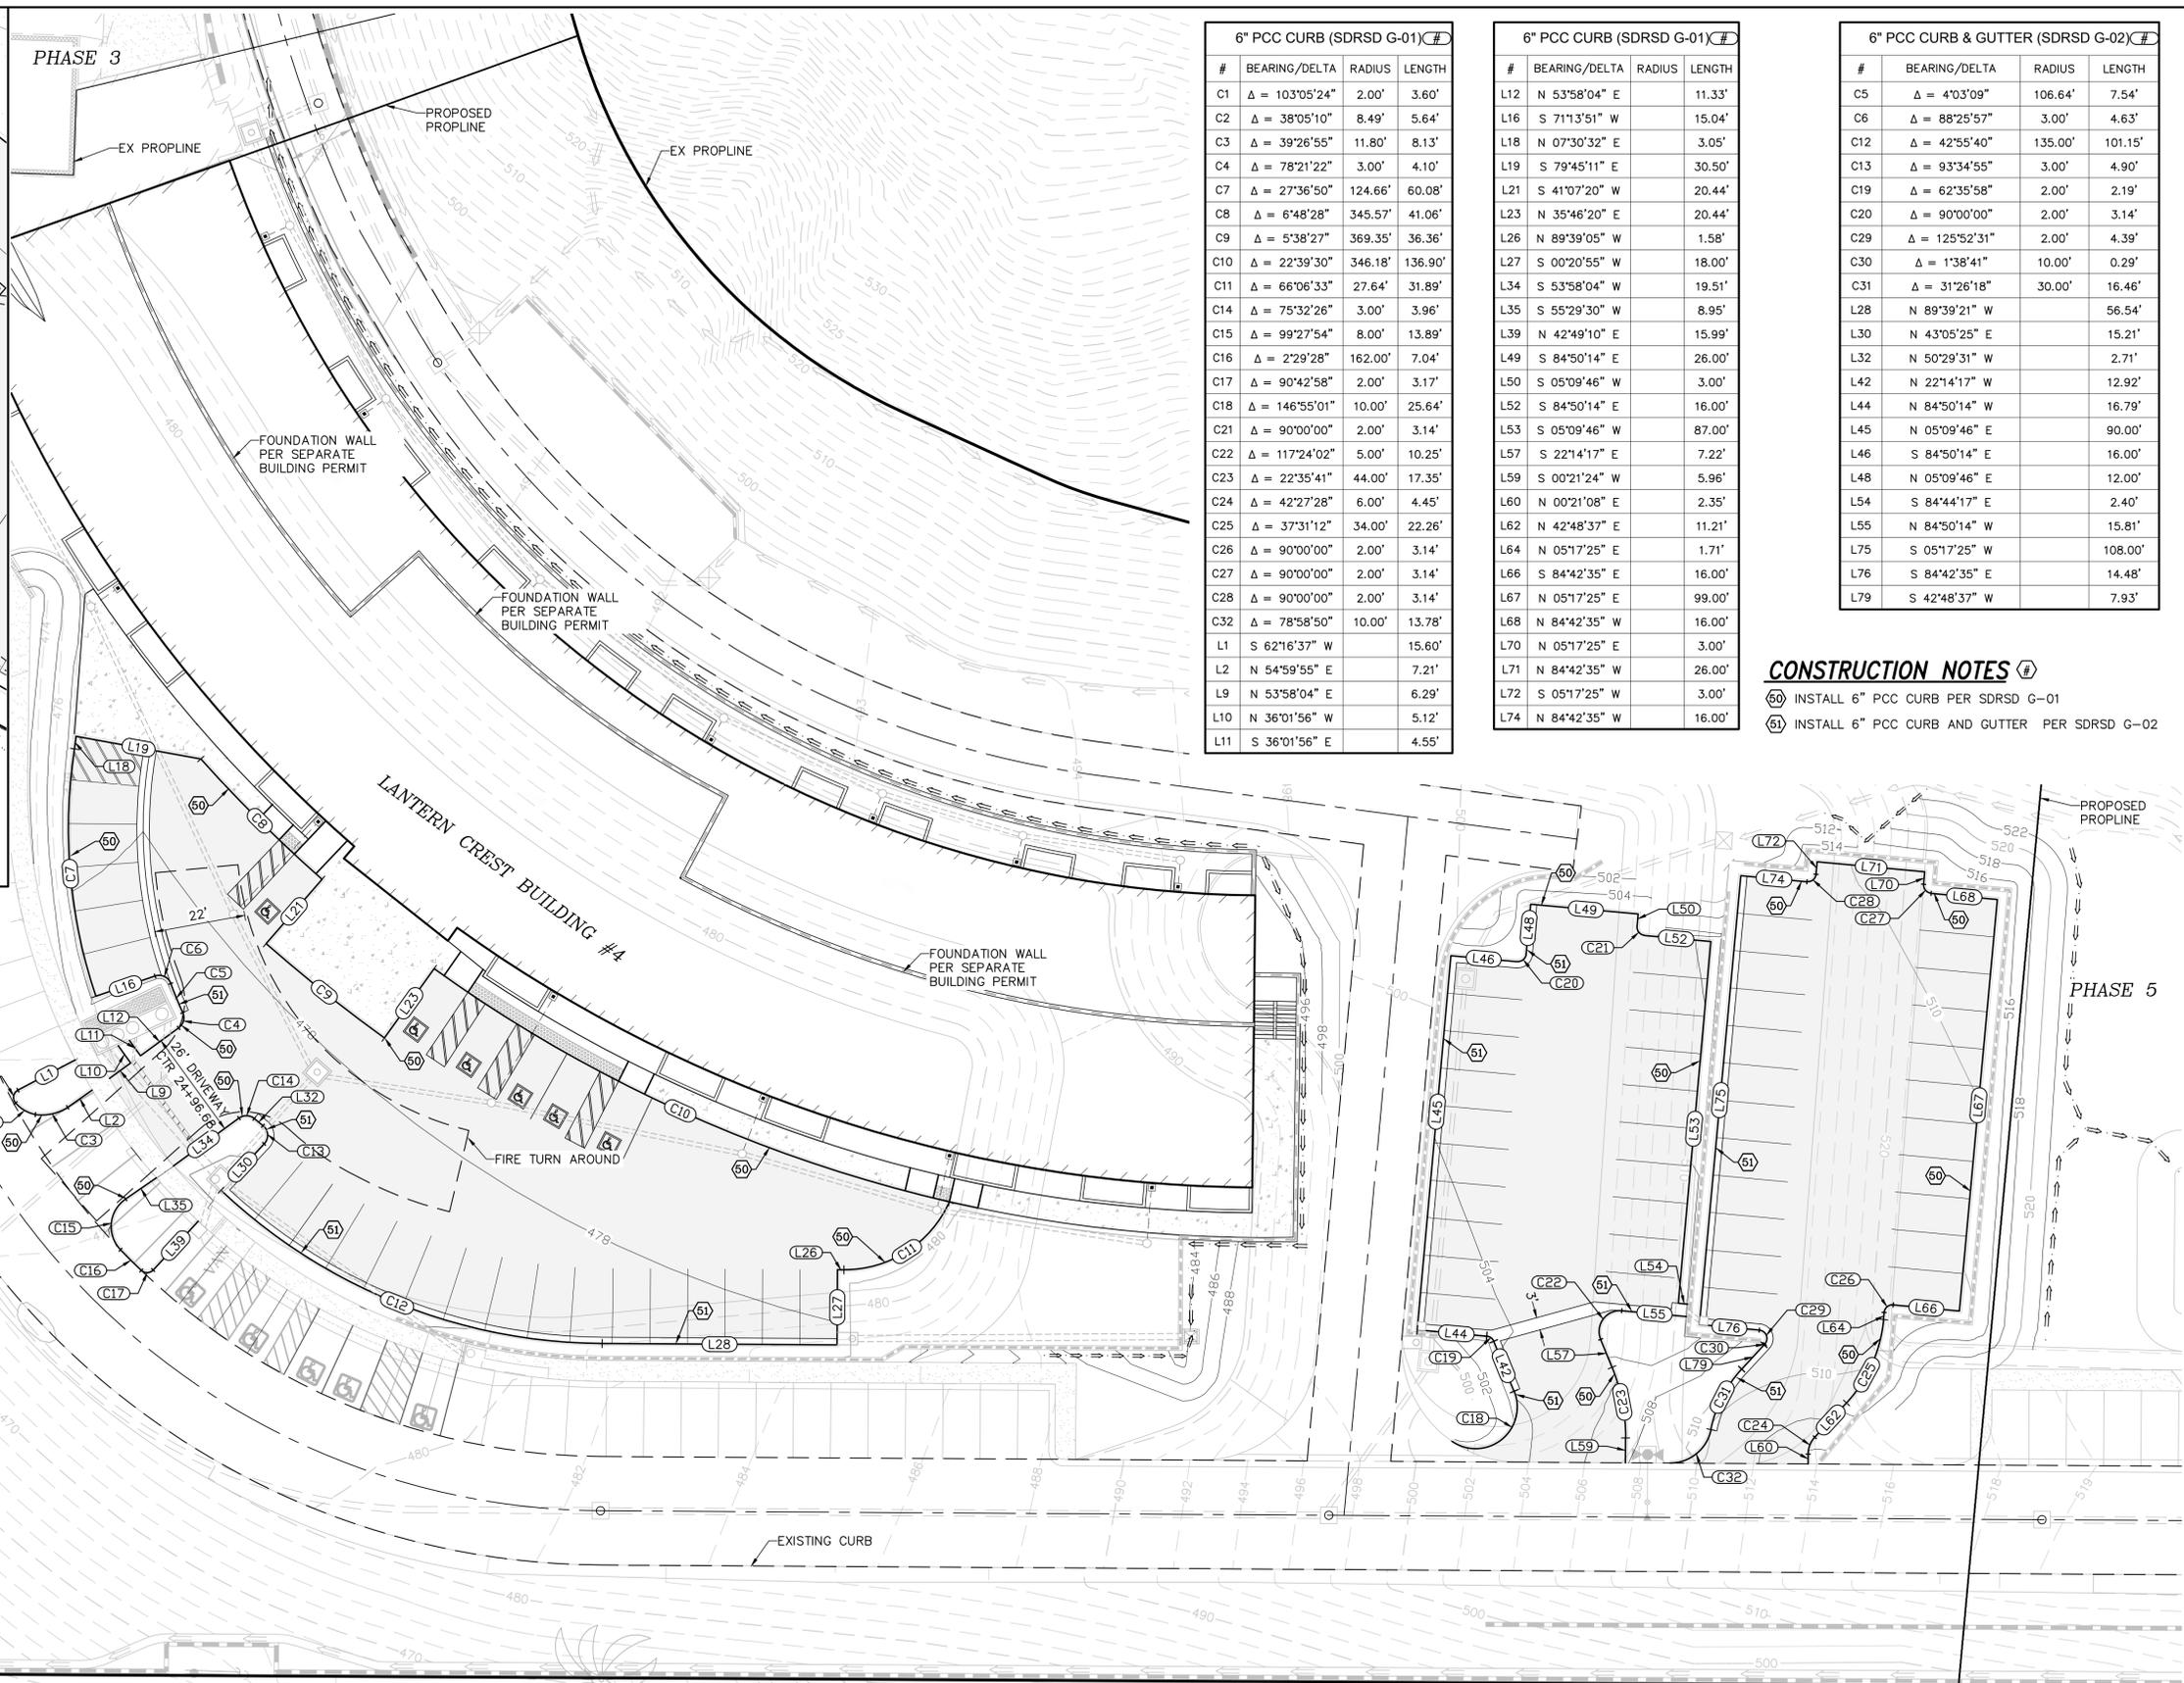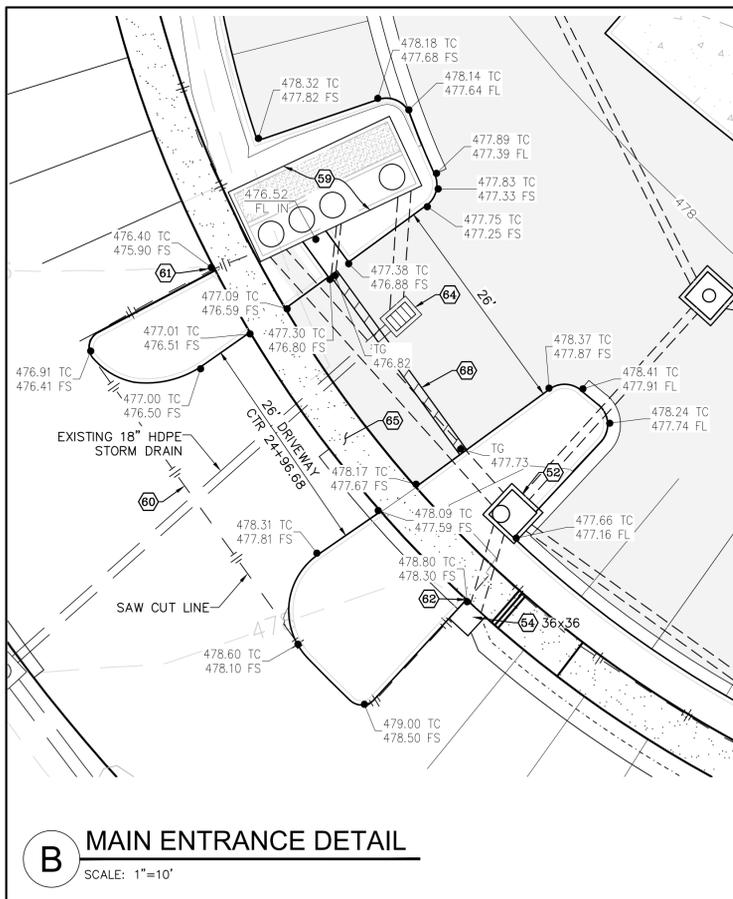
6" PCC CURB (SDRSD G-01)			
#	BEARING/DELTA	RADIUS	LENGTH
L12	N 53°58'04" E		11.33'
L16	S 71°13'51" W		15.04'
L18	N 07°30'32" E		3.05'
L19	S 79°45'11" E		30.50'
L21	S 41°07'20" W		20.44'
L23	N 35°46'20" E		20.44'
L26	N 89°39'05" W		1.58'
L27	S 00°20'55" W		18.00'
L34	S 53°58'04" W		19.51'
L35	S 55°29'30" W		8.95'
L39	N 42°49'10" E		15.99'
L49	S 84°50'14" E		26.00'
L50	S 05°09'46" W		3.00'
L52	S 84°50'14" E		16.00'
L53	S 05°09'46" W		87.00'
L57	S 22°14'17" E		7.22'
L59	S 00°21'24" W		5.96'
L60	N 00°21'08" E		2.35'
L62	N 42°48'37" E		11.21'
L64	N 05°17'25" E		1.71'
L66	S 84°42'35" E		16.00'
L67	N 05°17'25" E		99.00'
L68	N 84°42'35" W		16.00'
L70	N 05°17'25" E		3.00'
L71	N 84°42'35" W		26.00'
L72	S 05°17'25" W		3.00'
L74	N 84°42'35" W		16.00'

6" PCC CURB & GUTTER (SDRSD G-02)			
#	BEARING/DELTA	RADIUS	LENGTH
C5	Δ = 4°03'09"	106.64'	7.54'
C6	Δ = 88°25'57"	3.00'	4.63'
C12	Δ = 42°55'40"	135.00'	101.15'
C13	Δ = 93°34'55"	3.00'	4.90'
C19	Δ = 62°35'58"	2.00'	2.19'
C20	Δ = 90°00'00"	2.00'	3.14'
C29	Δ = 125°52'31"	2.00'	4.39'
C30	Δ = 1°38'41"	10.00'	0.29'
C31	Δ = 31°26'18"	30.00'	16.46'
L28	N 89°39'21" W		56.54'
L30	N 43°05'25" E		15.21'
L32	N 50°29'31" W		2.71'
L42	N 22°14'17" W		12.92'
L44	N 84°50'14" W		16.79'
L45	N 05°09'46" E		90.00'
L46	S 84°50'14" E		16.00'
L48	N 05°09'46" E		12.00'
L54	S 84°44'17" E		2.40'
L55	N 84°50'14" W		15.81'
L75	S 05°17'25" W		108.00'
L76	S 84°42'35" E		14.48'
L79	S 42°48'37" W		7.93'

CONSTRUCTION NOTES

(60) INSTALL 6" PCC CURB PER SDRSD G-01

(61) INSTALL 6" PCC CURB AND GUTTER PER SDRSD G-02

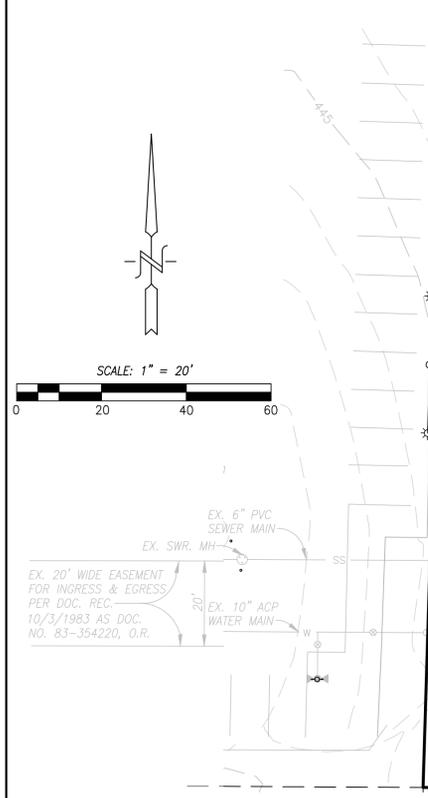

REC Civil Engineering-Environmental
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CONSTRUCTION RECORD	REFERENCES	DATE	BY	REVISIONS	ACPTD	BENCH MARK	SCALE	DESIGNED BY	DRAWN BY	CHECKED BY	REVIEWED	CITY OF SANTEE	DEPARTMENT OF DEVELOPMENT SERVICES	CITY W.O. NO.	DRAWING NO.
CONTRACTOR	556W, 2254WS, 2255WS, 2263WS					CITY OF SANTEE VERTICAL CONTROL MONUMENT	HORIZ: 1" = 20'	J.M.W.	J.M.W.	J.R.R.		GRADING PLANS FOR:			2022-
INSPECTOR	2011-026, 2011-037, 2013-015					#2076 PER R.O.S. 11252, LOCATED AT THE INTERSECTION	VERT: N/A					LANTERN CREST - PHASE 4		G-1383	2022-
DATE COMPLETED	2016-163, 2016-183, 2016-352					OF PROSPECT AVENUE & ARGENT STREET		RCE NO. 64811	DATE	EXPIRES	PROJECT ENGINEER	P2007-12			8 OF 18
	G-1281					ELEVATION: 346.35 FEET (MSL)			8-30-2023						

BMP PLAN SHEET LANTERN CREST PHASE 4

LEGEND

- DMA BOUNDARY
- STORM DRAIN
- STENCILING & PROHIBITIVE SIGNAGE (SEE SAMPLE BELOW)

MATERIALS & WASTE MANAGEMENT CONTROL BMPs:

- EC-1 SCHEDULING
- WM-1 MATERIAL DELIVERY & STORAGE:
- WM-3 STOCKPILE MANAGEMENT:
- WM-4 SPILL PREVENTION AND CONTROL:
- WM-5 SOLID WASTE MANAGEMENT:
- WM-6 HAZARDOUS WASTE MANAGEMENT:
- WM-8 CONCRETE WASTE MANAGEMENT:
- WM-9 SANITARY WASTE MANAGEMENT:
- NS-1 WATER CONSERVATION PRACTICES:
- NS-3 PAVING AND GRINDING OPERATIONS:
- NS-6 ILLICIT CONNECTION/DISCHARGE
- NS-7 POTABLE WATER/IRRIGATION
- NS-8 VEHICLE AND EQUIPMENT CLEANING
- NS-9 VEHICLE AND EQUIPMENT FUELING
- NS-10 VEHICLE AND EQUIPMENT MAINTENANCE
- NS-12 CONCRETE CURING
- NS-13 CONCRETE FINISHING

TEMPORARY RUNOFF CONTROL BMPs:

- SE-1 SILT FENCE
- SC-6/B GRAVEL OR SAND BAGS
- SC-10 STORM DRAIN INLET PROTECTION
- SE-9 FIBER ROLL
- TC-1 STABILIZED CONSTRUCTION ENTRANCE
- SS-7/SS-4 JUTE MAT & HYDROSEED
- SE-7 STREET SWEEPING

NOTES

- * APPROXIMATE DEPTH TO GROUNDWATER > 20 FT
- * UNDERLYING SOIL TYPE D



SAMPLE PROHIBITIVE SIGNAGE

NTS



SCALE: 1" = 20'




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ALL SLOPES OVER 3' IN HEIGHT TO BE LANDSCAPED AND IRRIGATED WITH HYDROSEED AND TEMPORARY IRRIGATION UNTIL PERMANENT VEGETATION AND IRRIGATION CAN BE ESTABLISHED.



SOURCE CONTROL							
BMP ID #	BMP TYPE	SYMBOL	CASQA NO.	AREA	*INSPECTION FREQUENCY	*MAINTENANCE FREQUENCY	MAINTENANCE ACTIVITY
2	STENCILS	NO DUMPING	SD-13, SC-2	5 EACH	MONTHLY	AS NEEDED	INSPECT AND MAINTAIN/REPLACE AS NEEDED.
BMP ID #	BMP TYPE		*INSPECTION FREQUENCY	*MAINTENANCE FREQUENCY	MAINTENANCE ACTIVITY		
SC-1	PREVENTION OF ILLICIT DISCHARGES INTO MS4		CONTINUOUS	-	ALL PROJECTS MUST EFFECTIVELY ELIMINATE DISCHARGES OF NON-STORM WATER INTO THE STORM WATER CONVEYANCE SYSTEM.		
SC-2	STORM DRAIN STENCILING OR SIGNAGE		CONTINUOUS	REGULARLY	LABELING SHALL BE PROVIDED FOR ALL STORM WATER CONVEYANCE SYSTEM INLETS AND CATCH BASINS WITHIN THE PROJECT AREA. INLET STENCILING MAY INCLUDE CONCRETE STAMPING, CONCRETE PAINTING. INSPECT AND MAINTAIN MARKINGS AS NEEDED.		
SC-6	ADDITIONAL BMPs BASED ON POTENTIAL SOURCES OF RUNOFF POLLUTANTS		REGULARLY OR AS DETERMINED NECESSARY	REGULARLY OR AS DETERMINED NECESSARY	<p>SC-6.A: ON-SITE STORM DRAIN INLETS</p> <ul style="list-style-type: none"> • MAINTAIN AND PERIODICALLY REPAIR OR REPLACE INLET MARKINGS • CLEAN ALL INLETS AND STORM DRAIN PIPES OF ACCUMULATED TRASH AT LEAST ONCE A YEAR • PROVIDE STORM WATER POLLUTION PREVENTION INFORMATION TO NEW SITE OWNERS, LESSEES, OR OPERATORS <p>SC-6.B: INTERIOR FLOOR DRAINS AND ELEVATOR SHAFT SUMP PUMPS</p> <ul style="list-style-type: none"> • INSPECT AND MAINTAIN DRAINS TO PREVENT BLOCKAGE AND OVERFLOW <p>SC-6.D1: NEED FOR FUTURE INDOOR AND STRUCTURAL PEST CONTROL</p> <ul style="list-style-type: none"> • PROVIDE INTEGRATED PEST MANAGEMENT INFORMATION TO OWNERS, LESSEES AND OPERATORS. <p>SC-6.D2: LANDSCAPE/OUTDOOR PESTICIDE USE</p> <ul style="list-style-type: none"> • OWNER SHALL MAINTAIN LANDSCAPING USING MINIMUM OR NO PESTICIDES • PROVIDE IPM INFORMATION TO NEW OWNERS, LESSEES AND OPERATORS <p>SC-6.G: REFUSE AREAS</p> <p>SC-6.N: FIRE SPRINKLER TEST WATER</p> <ul style="list-style-type: none"> • FIRE SPRINKLER TEST WATER SHALL BE DRAINED TO SANITARY SEWER SYSTEM. • DURING A FIRE SPRINKLER TEST, THE FIRE RISER DISCHARGE SHALL BE CONNECTED BY A HOSE TO THE SEWER CLEANOUT. <p>SC-6.O: MISCELLANEOUS DRAIN OR WASH WATER</p> <p>SC-6.P: PLAZAS, SIDEWALK AND PARKING LOTS</p> <ul style="list-style-type: none"> • SWEEP REGULARLY TO PREVENT ACCUMULATION OF LITTER AND DEBRIS. • DEBRIS FROM PRESSURE WASHING MUST BE COLLECTED TO PREVENT ENTRY INTO STORM DRAIN SYSTEM. WASHWATER CONTAINING ANY CLEANING AGENT OR DEGREASER MUST BE COLLECTED AND DISCHARGED TO THE SANITARY SEWER AND NOT DISCHARGED TO A STORM DRAIN. • CLEAN ALL PAVEMENT AT LEAST ONCE A YEAR. 		


CONSTRUCTION RECORD		REFERENCES		DATE	BY	REVISIONS	ACPTD	BENCH MARK	SCALE	DESIGNED BY	DRAWN BY	CHECKED BY	REVIEWED	CITY OF SANTEE	DEPARTMENT OF DEVELOPMENT SERVICES	CITY W.O. NO.	DRAWING NO.
CONTRACTOR	INSPECTOR	DATE COMPLETED	556W, 2254WS, 2255WS, 2263WS					CITY OF SANTEE VERTICAL CONTROL MONUMENT	HORIZ: 1" = 20'	J.M.W.	J.M.W.	J.R.R.		BMP PLAN FOR: LANTERN CREST - PHASE 4	P2007-12	G-1383	2022- SHEET 9 OF 18
			2011-026, 2011-037, 2013-015					OF PROSPECT AVENUE & ARGENT STREET	VERT: N/A	RCE NO. 64811	DATE EXPIRES: 6-30-2023	PROJECT ENGINEER					

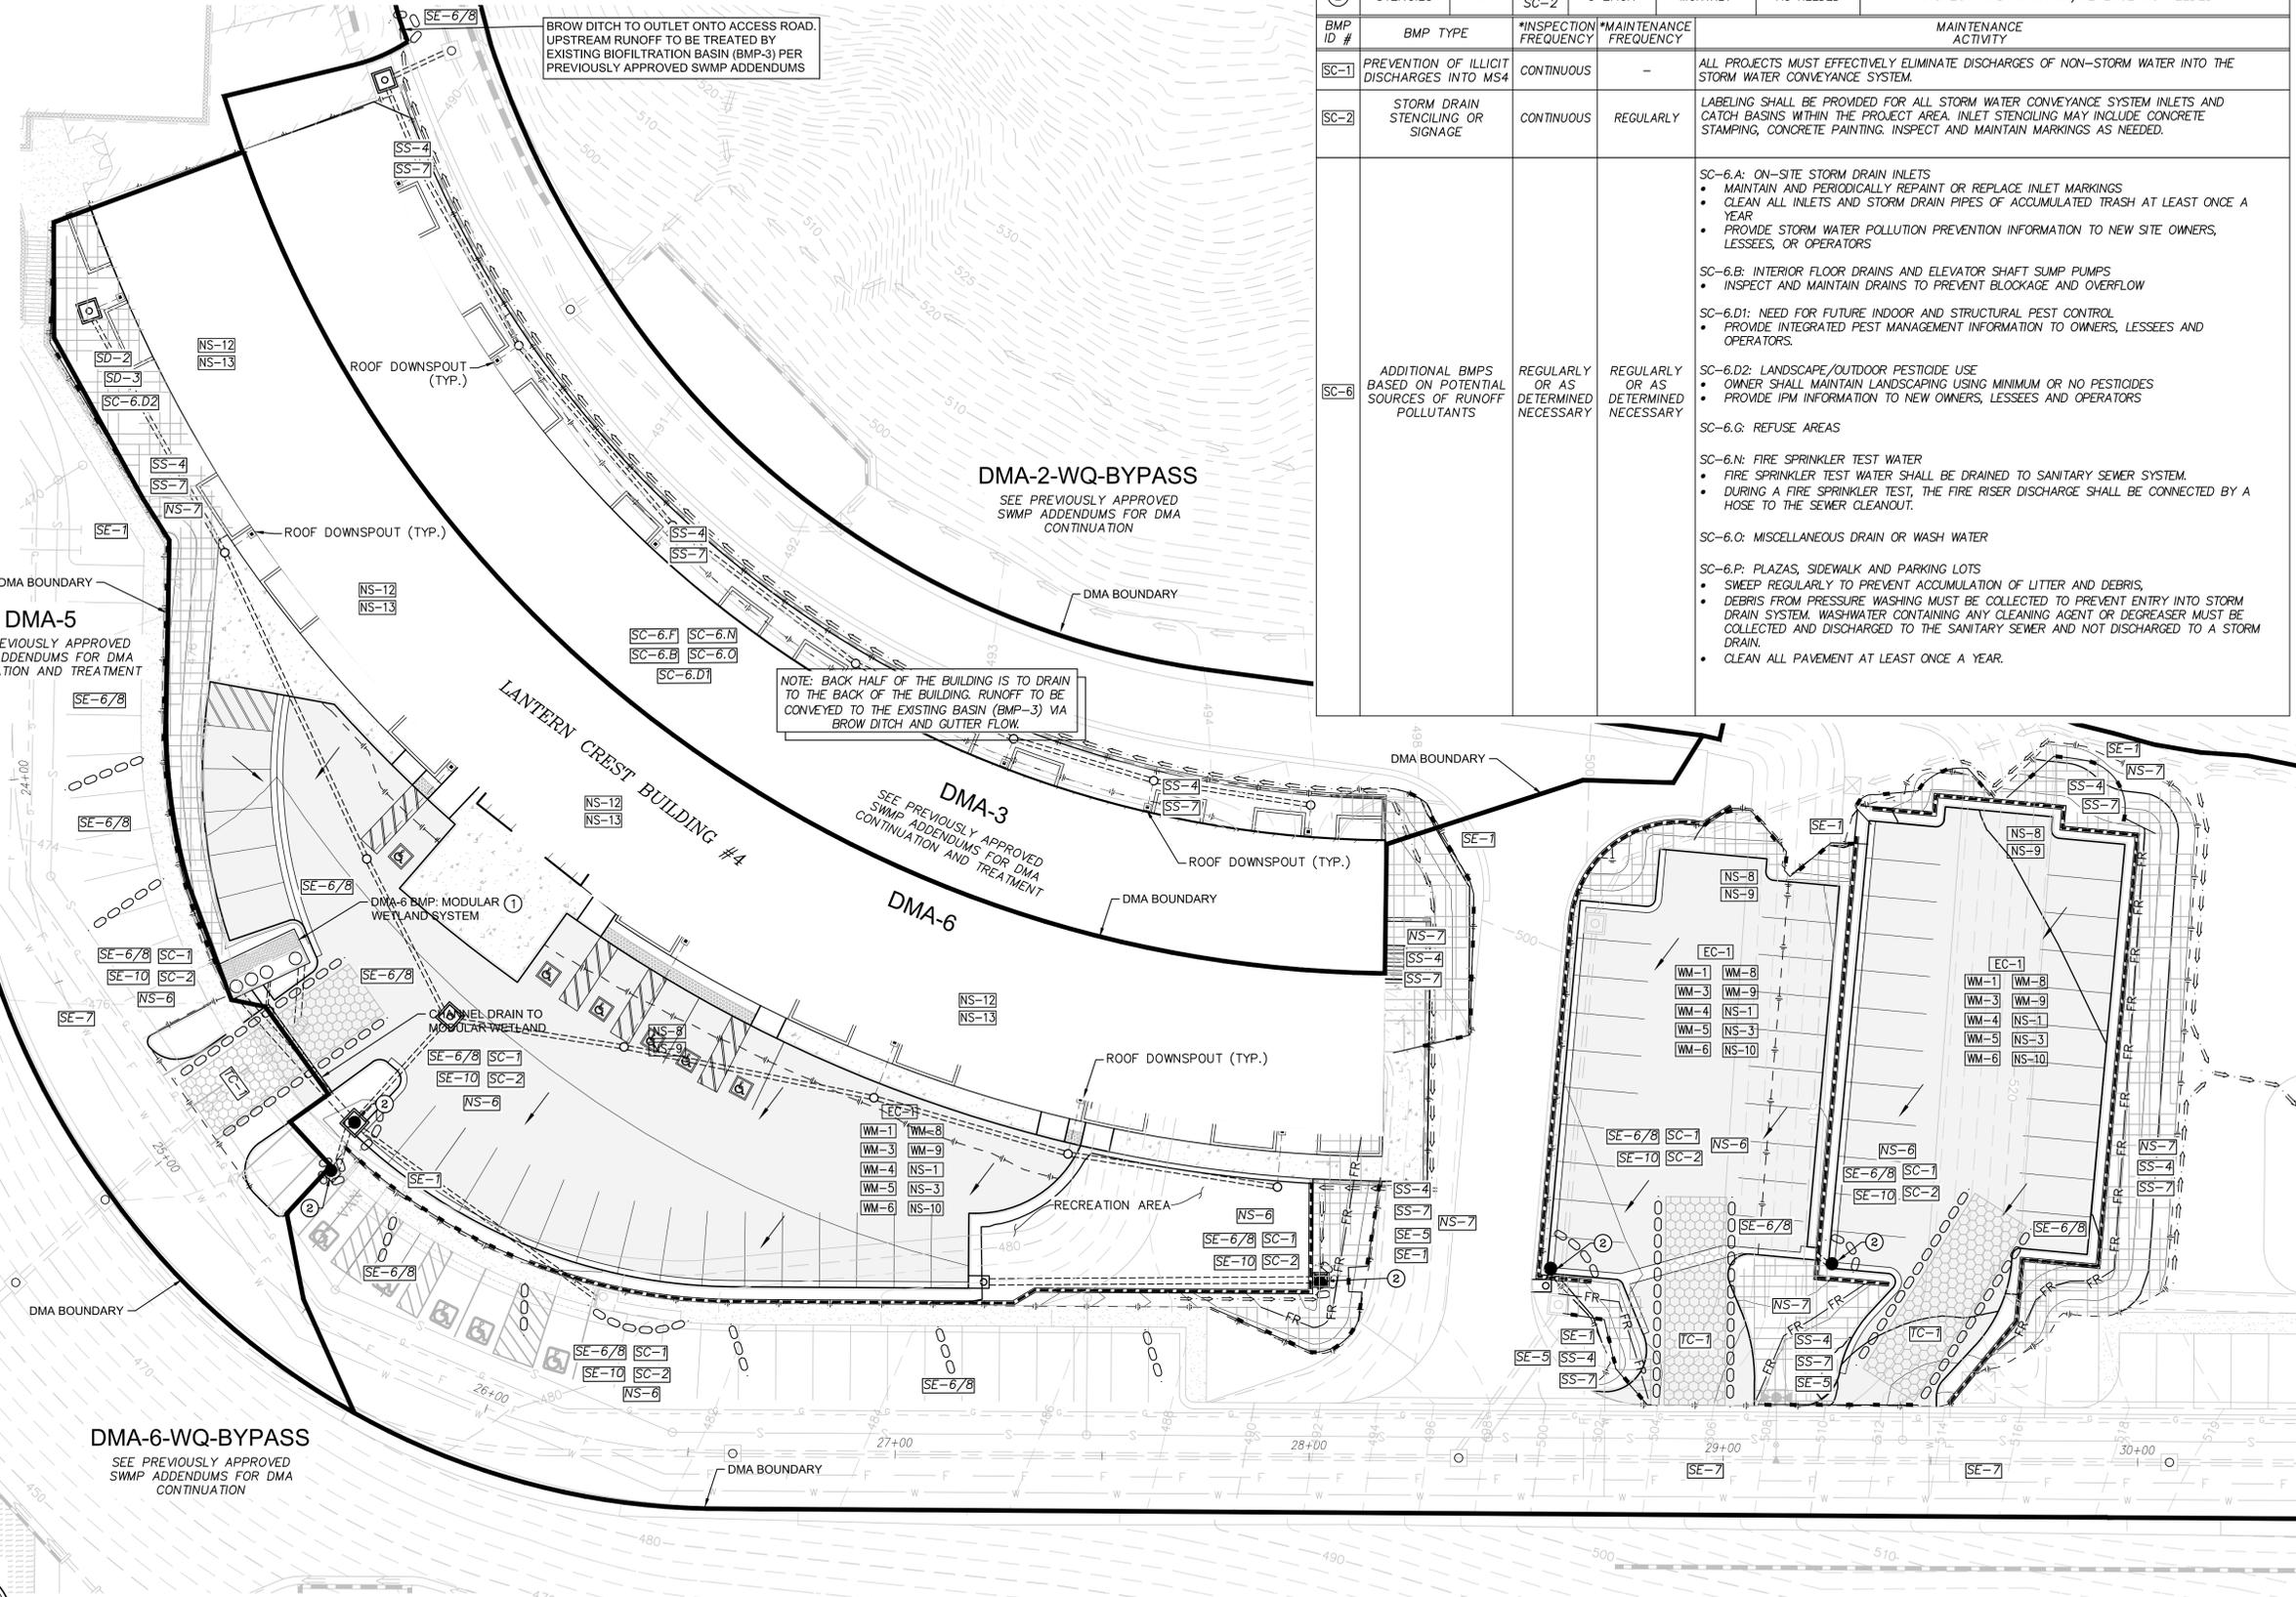PLANTING LEGEND

STREET AND SLOPE TREES					
SYMBOL	KEY	BOTANICAL NAME	COMMON NAME	SIZE	WUCOLS QTY.
○	3	PISTACIA CHINENSIS	CHINESE PISTACHE	24" BOX	M 6
	4	QUERCUS AGRIFOLIA	COAST LIVE OAK		L 6
	6	GEIJERA PARVIFLORA	AUSTRALIAN WILLOW		L 2
	7	LAURUS NOBILIS	SWEET BAY		M 6
	8	JUNIPERUS SCOPULORUM 'SKYROCKET'	SKYROCKET JUNIPER	15 GALLON	L 12

SHRUBS					
SYMBOL	BOTANICAL NAME	COMMON NAME	SIZE	WUCOLS QTY.	
○	LEUCOPHYLLUMFRUTESCENS 'LOS ALAMITOS'	TEXAS SAGE	5 GALLON	L	16
○	WESTRINGIA F. 'MUNDI'	MUNDI WESTRINGIA		L	27
○	RHAPHIOLEPIS INDICA 'MUNTO'	INDIAN HAWTHORN		L	52
○	LANTANA CAMARA 'IRENE'	LANTANA	5 GALLON	L	82
○	PYRACANTHA KOIDZUMII 'SANTA CRUZ'	SANTA CRUZ FIRETHORN		L	84
○	WESTRINGIA 'BLUE GEM'	COAST ROSEMARY	1 GALLON	L	73
○	PHORMIUM HYBRID 'APRICOT QUEEN'	NEW ZEALAND FLAX		M	21
○	TULBAGHIA VIOLACEA 'VARIAGATA'	SOCIETY GARLIC		L	58
●	SISYRINCHIUM ANGUSTIFOLIUM 'LUCERNE'	LUCERNE BLUE EYED GRASS		L	210
▨	ACACIA REDOLENS 'DESERT CARPET'	ACACIA	1 GALLON	L	-
⊗	ROSA X 'NOA97400A'	AMBER CARPET ROSE	1 GALLON	L	65
○	ROSMARINUS OFFICINALIS 'HUNTINGTON CARPET'	ROSEMARY	1 GALLON	L	36
○	LANTANA MONTEVIDENSIS	PURPLE LANTANA	1 GALLON	L	43
⊠	JUNCUS PATENS	CALIFORNIA RUSH	1 GALLON	L	-
⊠	IVA HAYESIANA	SAN DIEGO MARSH	24" O.C.	L	-
○	CALLISTEMON V. 'LITTLE JOHN'	DWARF BOTTLE BRUSH	1 GALLON	L	116
⊠	DIANELLA X 'CLARITY BLUE'	CLARITY BLUE DIANELLA	1 GAL	L	12
⊠	PHORMIUM 'JESTER'	NEW ZEALAND FLAX		L	75
⊠	BACCHARIS P.	COYOTE BRUSH	FLATS 36" O.C.	L	-

HYDROSEED AND MULCH NOTE
 ALL 3:1 SLOPES AND STEEPER SHALL RECEIVE HYDROSEED MIX AS SPECIFIED HEREIN. ALL OTHER LANDSCAPED AREAS LESS THAN 3:1 SLOPE INCLUDING FLAT AREAS SHALL RECEIVE SHREDDED WOOD MULCH AT 3-INCH DEPTH.

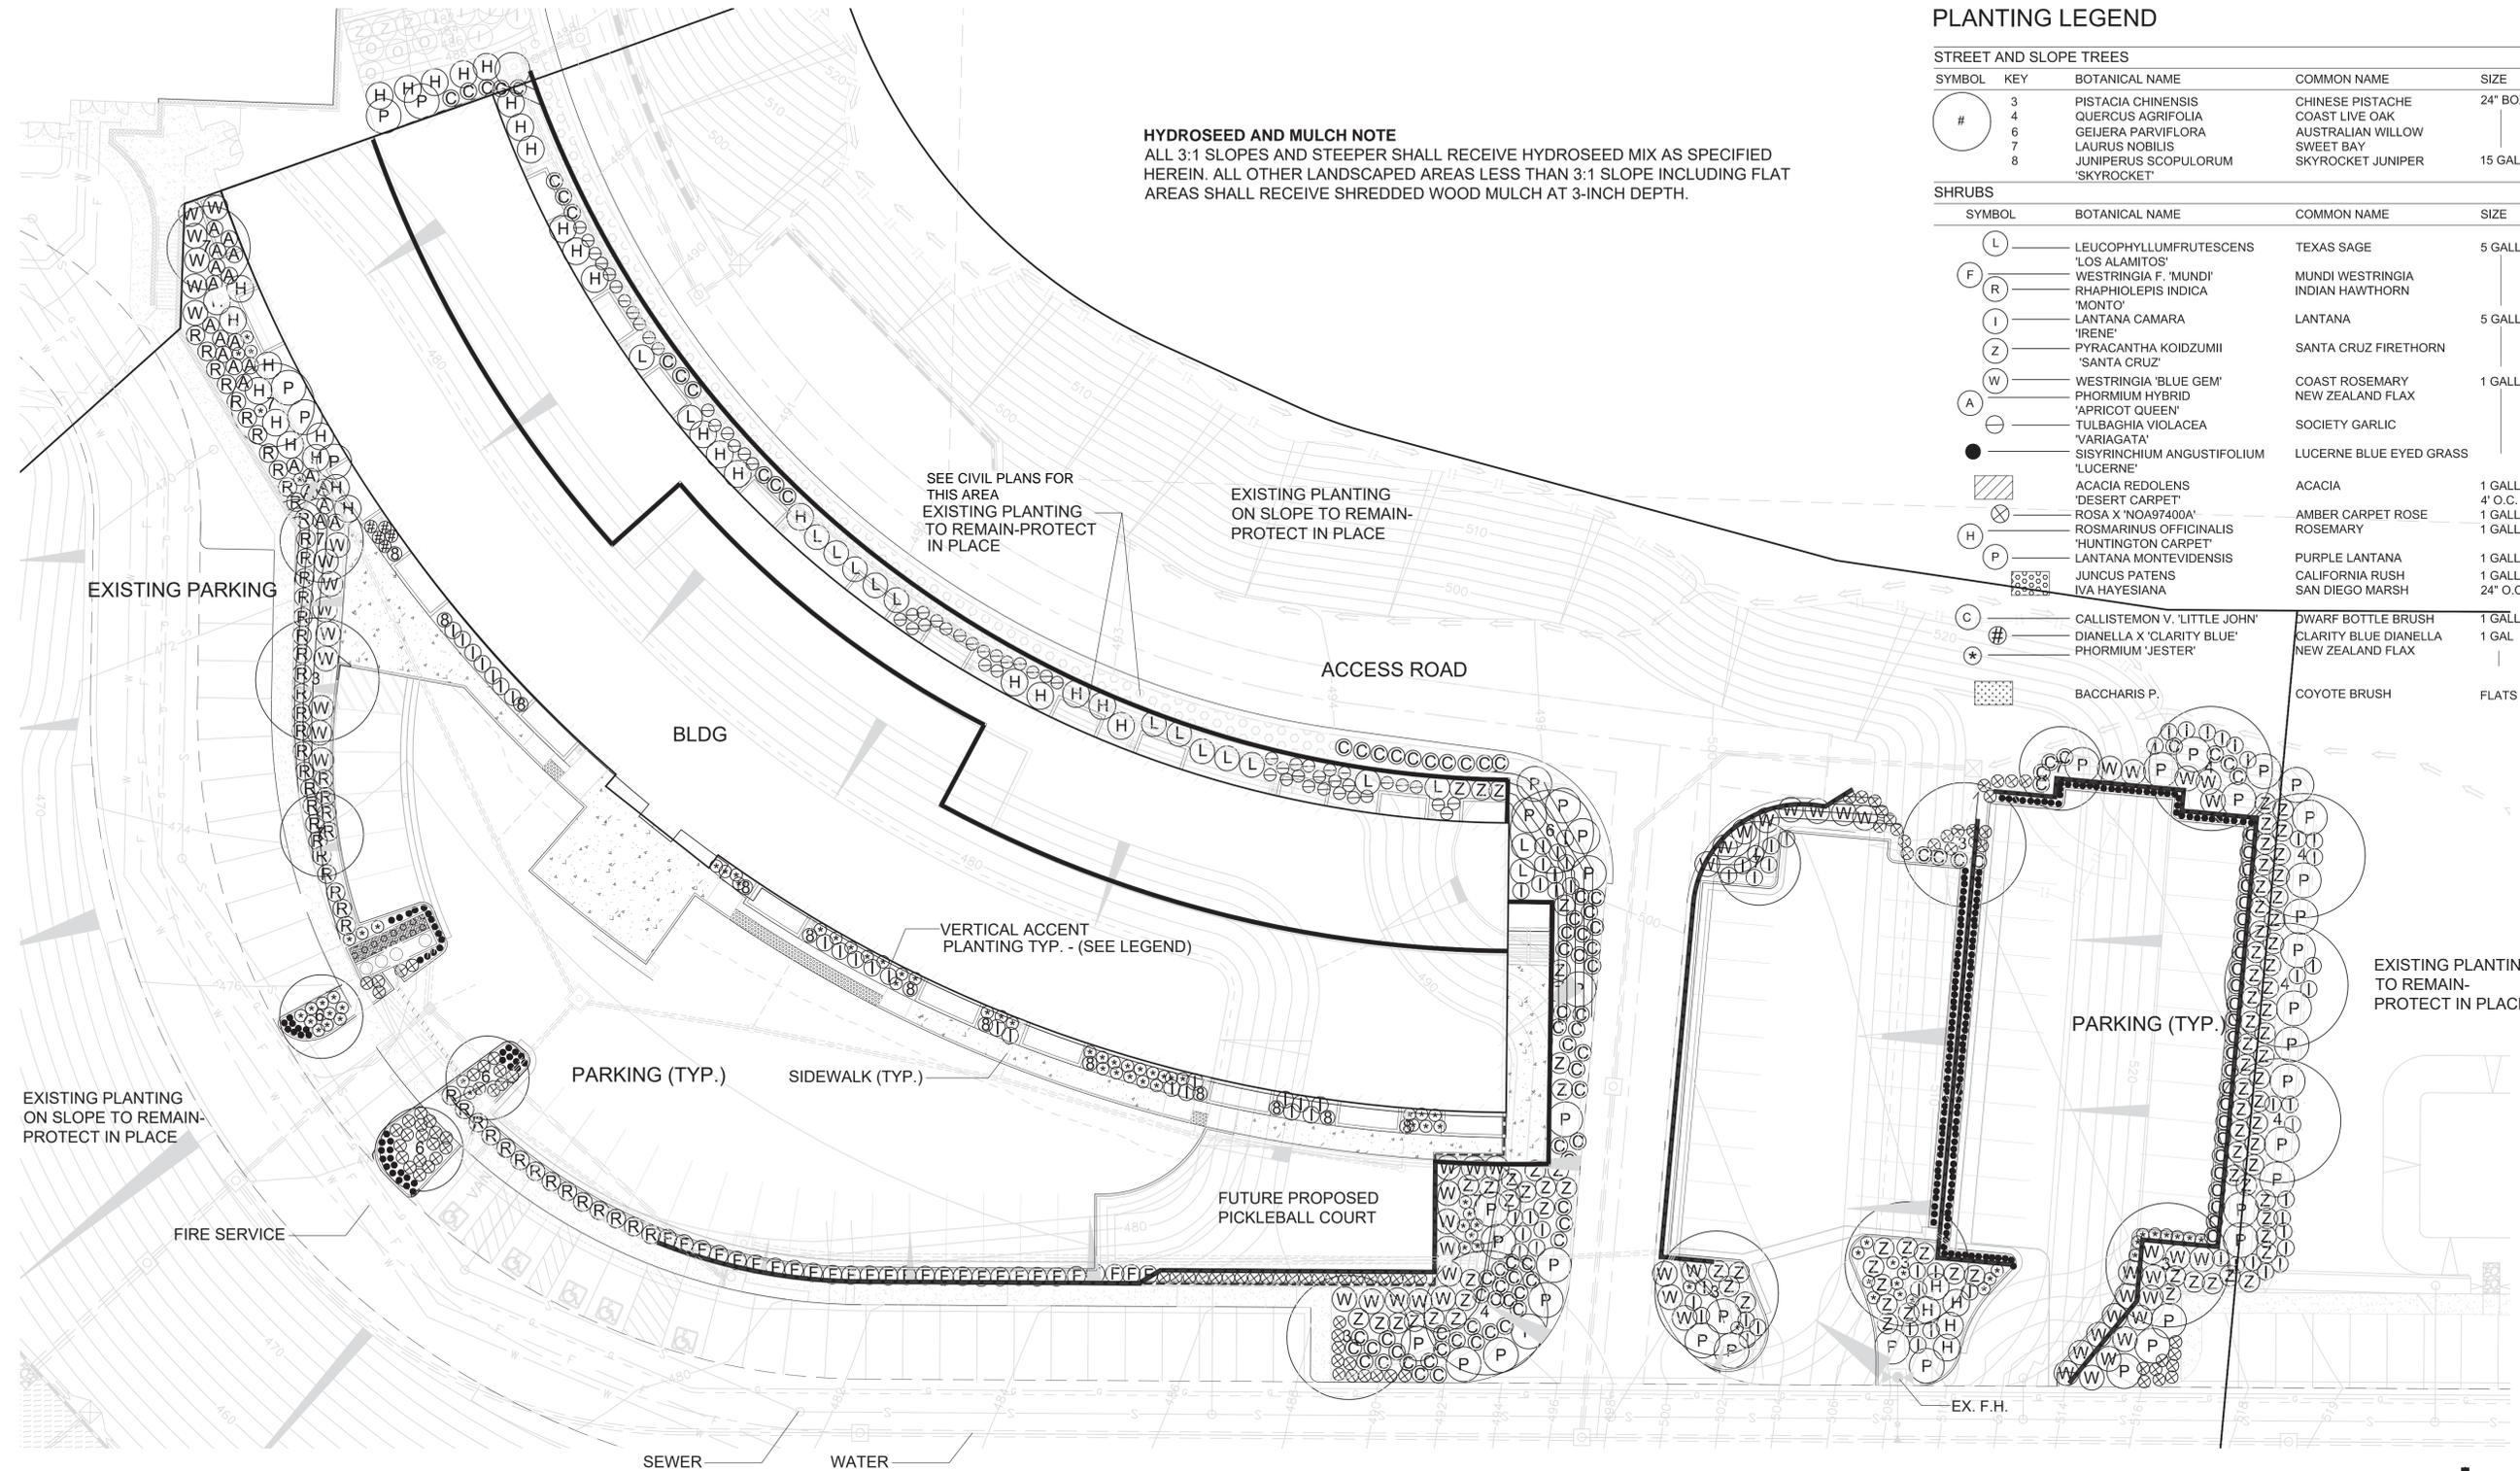

SEE SHEET L-2 FOR PLANTING DETAILS AND NOTES
 SEE SHEET L-3 FOR IRRIGATION SPECIFICATIONS

PRE-EMERGENT HERBICIDE SHALL BE APPLIED IN ALL LANDSCAPED AREAS PRIOR TO MULCH PLACEMENT.



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CONSTRUCTION RECORD		REFERENCES		DATE	BY	REVISIONS	ACPTD	BENCH MARK	SCALE	DESIGNED BY	DRAWN BY	CHECKED BY	CITY OF SANTEE DEPARTMENT OF DEVELOPMENT SERVICES LANDSCAPE PLAN FOR <i>LANTERN CREST PHASE 4</i>	DATE: 01-03-2023	L-1
CONTRACTOR	INSPECTOR	DATE COMPLETED	556W, 2254WS, 2255WS, 2263WS					CITY OF SANTEE VERTICAL CONTROL MONUMENT #2076 PER R.O.S. 11252, LOCATED AT THE INTERSECTION OF PROSPECT AVENUE & ARGENT STREET ELEVATION 346.35 FEET (MSL.)	1"=20'-0"	PML	PML	GFH		CITY W.O. NO.	DRAWING NO.
										PLANS PREPARED UNDER THE SUPERVISION OF GARY HOYT DATE 01/03/23 RCE NO. 2517 EXPIRES 12/31/24		G-1383		2022-	
										PROJECT PLANNER		P2007-12		SHEET 16 OF 18	