SITE NAME: SANTEE

PROJECT DESCRIPTION: PROPOSED

TELECOMMUNICATIONS

FACILITY

TOWER TYPE: 74' MONOPINE TOWER

SITE ADDRESS: 10400-CS FANITA PARKWAY

SANTEE, CA 92071 (SAN DIEGO COUNTY)

AREA OF 1,900 ± SQ. FT. **CONSTRUCTION:** (LEASE AREA)

LEGAL DESCRIPTION: **LOT 8 THAT POR OF**

DOC77-132403 IN\

JURISDICTION: **CITY OF SANTEE**

PARCEL #: 378-020-49-00

ZONING: PARK/ OPEN SPACE (P/OS)

PROJECT INFORMATION

N 32° 52' 06.183" (NAD '83) LATITUDE LONGITUDE W 117° 00' 27.534" (NAD '83) **GROUND ELEVATION** 399.0' AMSL (NAVD '88)*

* INFORMATION PROVIDED BY RLF CONSULTING IN THE FORM OF 1-A CERIFICATION, DATED JUNE 20, 2024.

1-A COORDINATES



LOCATION MAP

FROM SAN DIEGO AIRPORT DRIVING SOUTH ON I-5 TAKE EXIT 16 TO MERGE ONTO CA-163 AND STAY ON FOR 8.7 MILES. THEN TAKE EXIT 9A TO MERGE ONTO CA-52 AND STAY ON FOR 6.5 MILES. THEN TAKE EXIT 13 FOR MAST BLVD. TURN LEFT ONTO MAST BLVD. THEN TURN LEFT ONTO FANITA PKWY. THE SITE IS AT SANTEE LAKES RECREATION PRESERVE.

DRIVING DIRECTIONS



10400-CS FANITA PARKWAY **SANTEE, CA 92071** (SAN DIEGO COUNTY)

ALL WORK AND MATERIALS SHALL BE PERFORMED AND INSTALLED IN ACCORDANCE WITH THE CURRENT EDITIONS OF THE FOLLOWING CODES AS ADOPTED BY THE LOCAL GOVERNING AUTHORITIES, NOTHING IN THESE PLANS IS TO BE CONSTRUED TO PERMIT WORK NOT CONFORMING TO THE LATEST EDITIONS OF THE FOLLOWING:

- INTERNATIONAL BUILDING CODE 4. NATIONAL ELECTRIC CODE

UTILITIES:

PHONE:

POWER COMPANY:

METER # NEAR SITE:

- (2018 EDITION) (2017 EDITION) (2017 EDITION) (AND ADDRESS OF ANSI/ITA/EIA-222-G (CITY/COUNTY ORDINANCES
- CONSTRUCTION OF A TELECOMMUNICATION FACILITY, CONSISTING OF ANTENNAS & ASSOCIATED APPURTENANCES ON A PROPOSED MONOPOLE TOWER, FENCED OMPOUND & SERVICE EQUIPMENT FOR FUTURE CARRIERS. NO WATER OR SEWER IS REQUIRED. . FACILITY DESIGNED IN ACCORDANCE WITH CITY OF SANTEE REGULATIONS.
- THIS IS AN UNMANNED FACILITY WHICH WILL NOT REQUIRE ANY WATER OF SEWER FACILITIES. 3. TRAFFIC WILL CONSIST ONLY OF MAINTENANCE PERSONNEL, VISITING THE SITE
- APPROXIMATELY TWICE A MONTH.

 PROPOSED UTILITY TRENCHING TO BE AT A MINIMUM DEPTH OF 36" WITH A RUI
 LENGTH OF APPROXIMATELY 300FT.

CODE COMPLIANCE

SDG&E

(800) 336-7343

PROJECT DESCRIPTION & NOTES

SITE CONSTRUCTION MANAGER: WIBLUE, INC. COREY BONNER NAME: CONTACT: (986) 206-7071 SITE APPLICANT:

Know what's below.

Call before you dig.

NAME: WIBLUE, INC. ADDRESS: 2500 30TH ST., SUITE 304 CITY, STATE, ZIP: BOULDER, CO 80301 CONTACT: SANDRA LAYTON (801) 732-0624

ORIGINAL SURVEYOR:

CALL FOR UNDERGROUND

(800) 344-8377

EMERGENCY:

CALL 911

UTILITIES PRIOR TO DIGGING

RLF CONSULTING, LLC 2165 WEST PECOS ROAD NAME: CITY, STATE, ZIP: CHANDLER, AZ 85224
PHONE: STEVEN A WOOD. P.L. STEVEN A WOOD, P.L.S. (480) 445-9189

CIVIL ENGINEER:

NAME:

326 TRYON ROAD CITY, STATE, ZIP: RALEIGH, NC 27603 CONTACT: STEPHEN BUNTING, P.E. (919) 661-6351

ELECTRICAL ENGINEER:

NAME: ADDRESS:

326 TRYON ROAD CITY, STATE, ZIP: RALEIGH, NC 27603 CONTACT: MARK QUAKENBUSH, P.E. CONTACT: PHONE: (919) 661-6351

PROPERTY OWNER:

NAME: PADRE DAM MUNICIPAL WATER DISTRICT P.O. BOX 719003

CITY, STATE, ZIP: SANTEE, CA 92072

FACILITY OWNER:

NAME: ATLAS TOWER 1, LLC ADDRESS: 2500 30TH ST., SUITE 304 CITY, STATE, ZIP: BOULDER, CO 80301

CONTACT INFORMATION

SHEET	DESCRIPTION	REV
T1	TITLE SHEET	4
LS-1	TOPOGRAPHIC SURVEY	4
LS-2	TOPOGRAPHIC SURVEY	4
N1	GENERAL NOTES	4
C1	AREA PLAN	4
C2	SITE PLAN	4
C3	COMPOUND DETAIL	4
C4	TOWER ELEVATON	4
C5	AT&T ANTENNA SCHEDULE	4
C6	FENCE DETAILS	4
C7	GRADING & SOIL & EROSION CONTROL PLAN	4
C8	SILT FENCE DETAIL	4
C9	DRAINAGE PLAN	4
C10	LANDSCAPING PLAN	4
E1	ELECTRICAL NOTES	4
E2	POWER PLAN & ONE-LINE DIAGRAM	4
E3	EXTENDED POWER PLAN	4
E4	SERVICE RACK DETAILS	4
E5	GROUNDING PLAN	4
E6	GROUNDING DETAILS	4
E7	TOWER FOUNDATION GROUNDING DETAILS	4


INDEX OF SHEETS



4700 DAHLIA STREET **DENVER, CO 80216** OFFICE: (303) 566-9914 www.tepgroup.net

4	08-02-24	PRELIMINARY
3	06-20-24	PRELIMINARY
2	06-05-24	PRELIMINARY
- 1	05-15-24	PRELIMINARY
0	04-08-24	PRELIMINARY
REV	DATE	ISSUED FOR:

DRAWN BY: CHECKED BY: ASD

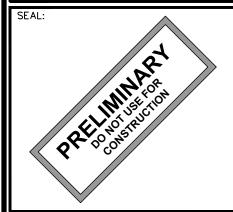

SHEET NUMBER

REVISION:

SCHEDULE B EXCEPTIONS

- 1. THERE WERE NO TAXES LEVIED FOR THE FISCAL YEAR 2020-2021 AS THE PROPERTY WAS VESTED IN A PUBLIC ENTITY.
- 2. ANY LIENS OR OTHER ASSESSMENTS, BONDS, OR SPECIAL DISTRICT LIENS INCLUDING WITHOUT LIMITATION, COMMUNITY FACILITY DISTRICTS, THAT ARISE BY REASON OF ANY LOCAL, CITY, MUNICIPAL OR COUNTY PROJECT OR SPECIAL DISTRICT.
- THE LIEN OF SUPPLEMENTAL OR ESCAPED ASSESSMENTS OF PROPERTY TAXES, IF ANY, MADE PURSUANT TO THE PROVISIONS OF CHAPTER 3.5 (COMMENCING WITH SECTION 75) OR PART 2, CHAPTER 3, ARTICLES 3 AND 4, RESPECTIVELY, OF THE REVENUE AND TAXATION CODE OF THE STATE OF CALIFORNIA AS A RESULT OF THE TRANSFER OF TITLE TO THE VESTEE NAMED IN SCHEDULE A OR AS A RESULT OF CHANGES IN OWNERSHIP OR NEW CONSTRUCTION OCCURRING PRIOR TO DATE OF POLICY.
- 4. WATER RIGHTS, CLAIMS OR TITLE TO WATER, WHETHER OR NOT DISCLOSED BY THE PUBLIC RECORDS.
- 5. EASEMENT(S) FOR THE PURPOSE(S) SHOWN BELOW AND RIGHTS INCIDENTAL THERETO, AS GRANTED IN A DOCUMENT: GRANTED TO: SAN DIEGO GAS AND ELECTRIC COMPANY PURPOSE: PUBLIC UTILITIES AND INCIDENTAL PURPOSES RECORDING DATE: DECEMBER 19, 1958
 RECORDING NO: IN BOOK 7406 PAGE 57 OF OFFICIAL RECORDS AFFECTS: AS SHOWN IN SAID DOCUMENT (BLANKET IN NATURE COVERS MULTIPLE PROPERTIES)
- EASEMENT(S) FOR THE PURPOSE(S) SHOWN BELOW AND RIGHTS INCIDENTAL THERETO, AS GRANTED IN A DOCUMENT:
 GRANTED TO: SAN DIEGO GAS AND ELECTRIC COMPANY PURPOSE: PUBLIC UTILITIES AND INCIDENTAL PURPOSES RECORDING DATE: JUNE 1, 1962
 RECORDING NO: 93993 OF OFFICIAL RECORDS AFFECTS: AS SHOWN IN SAID DOCUMENT (OUTSIDE PARENT PARCEL)
- 7. EASEMENT(S) FOR THE PURPOSE(S) SHOWN BELOW AND RIGHTS INCIDENTAL THERETO, AS GRANTED IN A DOCUMENT:
 GRANTED TO: SANTEE COUNTY WATER DISTRICT
 PURPOSE: WATER PIPELINES AND INCIDENTAL PURPOSES
 RECORDING DATE: JUNE 7, 1962
 RECORDING NO: 97160 OF OFFICIAL RECORDS
 AFFECTS: AS SHOWN IN SAID DOCUMENT
 (OUTSIDE PARENT PARCEL)
- 8. EASEMENT(S) FOR THE PURPOSE(S) SHOWN BELOW AND RIGHTS INCIDENTAL THERETO, AS GRANTED IN A DOCUMENT: GRANTED TO: SANTEE COUNTY WATER DISTRICT PURPOSE: WATER PIPELINES AND INCIDENTAL PURPOSES RECORDING DATE: MAY 10, 1966
 RECORDING NO: 77975 OF OFFICIAL RECORDS AFFECTS: AS SHOWN IN SAID DOCUMENT AND RE-RECORDING DATE: FEBRUARY 20, 1967
 AND RE-RECORDING NO: 22787 OF OFFICIAL RECORDS (OUTSIDE PARENT PARCEL)
- 9. EASEMENT(S) FOR THE PURPOSE(S) SHOWN BELOW AND RIGHTS INCIDENTAL THERETO, AS GRANTED IN A DOCUMENT: GRANTED TO: SANTEE COUNTY WATER DISTRICT PURPOSE: WATER PIPELINES AND INCIDENTAL PURPOSES RECORDING DATE: MAY 10, 1966
 RECORDING NO: 77976 OF OFFICIAL RECORDS AFFECTS: AS SHOWN IN SAID DOCUMENT AND RE-RECORDING DATE: FEBRUARY 20, 1967
 AND RE-RECORDING NO: 22786 OF OFFICIAL RECORDS (REFERENCED)

SURVEYOR NOTES

- 1. ALL TITLE INFORMATION IS BASED UPON A COMMITMENT FOR TITLE INSURANCE PREPARED BY TICOR TITLE/CHICAGO TITLE INSURANCE COMPANY, ORDER NO.: CA-FASD-IMP-72G28-1-21-00840538 EFFECTIVE DATE: 08/09/2021.
- 2. SURVEYOR HAS NOT PERFORMED A SEARCH OF PUBLIC RECORDS TO DETERMINE ANY DEFECT IN TITLE.
- 3. THE BOUNDARY SHOWN HEREON IS PLOTTED FROM RECORD INFORMATION AND DOES NOT CONSTITUTE A BOUNDARY SURVEY OF THE PROPERTY.
- 4. SURVEYOR DOES NOT GUARANTEE THAT ALL UTILITIES ARE SHOWN OR THEIR LOCATIONS. IT IS THE RESPONSIBILITY OF THE CONTRACTOR AND DEVELOPER TO CONTACT BLUE STAKE AND ANY OTHER INVOLVED AGENCIES TO LOCATE ALL UTILITIES PRIOR TO CONSTRUCTION. REMOVAL, RELOCATION AND/ OR REPLACEMENT IS THE RESPONSIBILITY OF THE CONTRACTOR.

FLOOD ZONE DESIGNATION

THE PROPOSED LEASE PREMISES SHOWN HEREON APPEAR TO BE WITHIN FLOOD ZONE "X" AS DELINEATED ON THE FEDERAL EMERGENCY MANAGEMENT AGENCY FIRM MAP NO. 06073C1632G DATED 05/16/2012.

FLOOD ZONE "X" IS DEFINED AS: AREAS DETERMINED TO BE OUTSIDE 500-YEAR FLOODPLAIN; DETERMINED TO BE OUTSIDE THE 1% AND 0.2% ANNUAL CHANCE FLOODPLAINS.

SCHEDULE B EXCEPTIONS (CONTINUED)

- 10. EASEMENT(S) FOR THE PURPOSE(S) SHOWN BELOW AND RIGHTS INCIDENTAL THERETO, AS GRANTED IN A DOCUMENT:
 GRANTED TO: THE PACIFIC TELEPHONE AND TELEGRAPH COMPANY PURPOSE: PUBLIC UTILITIES AND INCIDENTAL PURPOSES RECORDING DATE: AUGUST 1, 1968
 RECORDING NO: 130597 OF OFFICIAL RECORDS
 AFFECTS: AS SHOWN IN SAID DOCUMENT (REFERENCED)
- 11. EASEMENT(S) FOR THE PURPOSE(S) SHOWN BELOW AND RIGHTS INCIDENTAL THERETO, AS GRANTED IN A DOCUMENT: GRANTED TO: SAN DIEGO GAS AND ELECTRIC COMPANY PURPOSE: PUBLIC UTILITIES AND INCIDENTAL PURPOSES RECORDING DATE: JULY 8, 1974
 RECORDING NO: 74-181902 OF OFFICIAL RECORDS AFFECTS: AS SHOWN IN SAID DOCUMENT (REFERENCED)
- 12. EASEMENT(S) FOR THE PURPOSE(S) SHOWN BELOW AND RIGHTS INCIDENTAL THERETO, AS GRANTED IN A DOCUMENT: GRANTED TO: SAN DIEGO GAS AND ELECTRIC COMPANY PURPOSE: PUBLIC UTILITIES AND INCIDENTAL PURPOSES RECORDING DATE: JANUARY 9, 1975
 RECORDING NO: 75-005628 OF OFFICIAL RECORDS AFFECTS: AS SHOWN IN SAID DOCUMENT (OUTSIDE PARENT PARCEL)
- 13. EASEMENT(S) FOR THE PURPOSE(S) SHOWN BELOW AND RIGHTS INCIDENTAL THERETO, AS GRANTED IN A DOCUMENT:
 GRANTED TO: SAN DIEGO COUNTY FLOOD CONTROL DISTRICT PURPOSE: DRAINAGE RECORDING DATE: OCTOBER 20, 1980 RECORDING NO: 80-346612 OF OFFICIAL RECORDS AFFECTS: AS SHOWN IN SAID DOCUMENT (REFERENCED)
- 14. EASEMENT(S) FOR THE PURPOSE(S) SHOWN BELOW AND RIGHTS INCIDENTAL THERETO, AS GRANTED IN A DOCUMENT:
 GRANTED TO: SAN DIEGO GAS AND ELECTRIC COMPANY PURPOSE: PUBLIC UTILITIES AND INCIDENTAL PURPOSES RECORDING DATE: MARCH 9, 1982
 RECORDING NO: 82-064064 OF OFFICIAL RECORDS AFFECTS: AS SHOWN IN SAID DOCUMENT (OUTSIDE PARENT PARCEL)
- 15. MATTERS CONTAINED IN THAT CERTAIN DOCUMENT ENTITLED: "AGREEMENT TO PERFORM STORM WATER FACILITIES MAINTENANCE" EXECUTED BY: PADRE DAM MUNICIPAL WATER DISTRICT AND THE CITY OF SANTEE RECORDING DATE: SEPTEMBER 16, 2010 RECORDING NO: 2010-0491345 OF OFFICIAL RECORDS REFERENCE IS HEREBY MADE TO SAID DOCUMENT FOR FULL PARTICULARS. (NO PLOTTABLE EASEMENTS/EXCEPTIONS)
- 16. MATTERS CONTAINED IN THAT CERTAIN DOCUMENT ENTITLED: "MEMORANDUM OF UNRECORDED GRANT AGREEMENT" EXECUTED BY: PADRE DAMS SANTEE LAKES AND DEPARTMENT OF PARKS AND RECREATION RECORDING DATE: JANUARY 04, 2011 RECORDING NO: 2011-0005277 OF OFFICIAL RECORDS REFERENCE IS HEREBY MADE TO SAID DOCUMENT FOR FULL PARTICULARS. (OUTSIDE PARENT PARCEL)
- 17. MATTERS CONTAINED IN THAT CERTAIN DOCUMENT ENTITLED: "MEMORANDUM OF UNRECORDED GRANT AGREEMENT" EXECUTED BY: PADRE DAMS SANTEE LAKES AND DEPARTMENT OF PARKS AND RECREATION RECORDING DATE: NOVEMBER 08, 2012 RECORDING NO: 2012-0699549 OF OFFICIAL RECORDS REFERENCE IS HEREBY MADE TO SAID DOCUMENT FOR FULL PARTICULARS. (BLANKET IN NATURE DESCRIBES PARENT PARCEL)

ITEMS 1 THRU 8, 12, AND 14 THRU 17 OF THE CLIENT PROVIDED TITLE REPORT DO NOT CONTAIN GRAPHICALLY PLOTTABLE EASEMENTS, SETBACKS, RESTRICTIONS OR OTHER ENCUMBRANCES. THE SURVEYOR CANNOT GUARANTEE THAT NON-PLOTTABLE ENCUMBRANCES DO NOT EXIST THAT MAY AFFECT THE SUBJECT LEASED PREMISES.

PROJECT META DATA

- 1. ELEVATIONS SHOWN HEREON ARE REPRESENTED IN WORTH


 AMERICAN VERTICAL DATUM OF 1988 (NAVD88) ESTABLISHED FROM

 GPS DERIVED ELLIPSOID HEIGHTS, APPLYING GEOID 12B SEPARATIONS

 CONSTRAINING TO NGS CORS STATIONS PROVIDED IN THE "ONLINE


 POSITIONING USER SERVICE" (OPUS) SOLUTION FOR THIS SPECIFIC

 SITE.
- 2. BEARINGS SHOWED HEREON ARE BASED UPON U.S. STATE PLANE NAD83 COORDINATE SYSTEM *CALIFORNIA STATE PLANE COORDINATE ZONE VI*, DETERMINED BY GPS OBSERVATIONS.
- 3. FIELD WORK FOR THIS PROJECT WAS PERFORMED ON 08/09/2021.

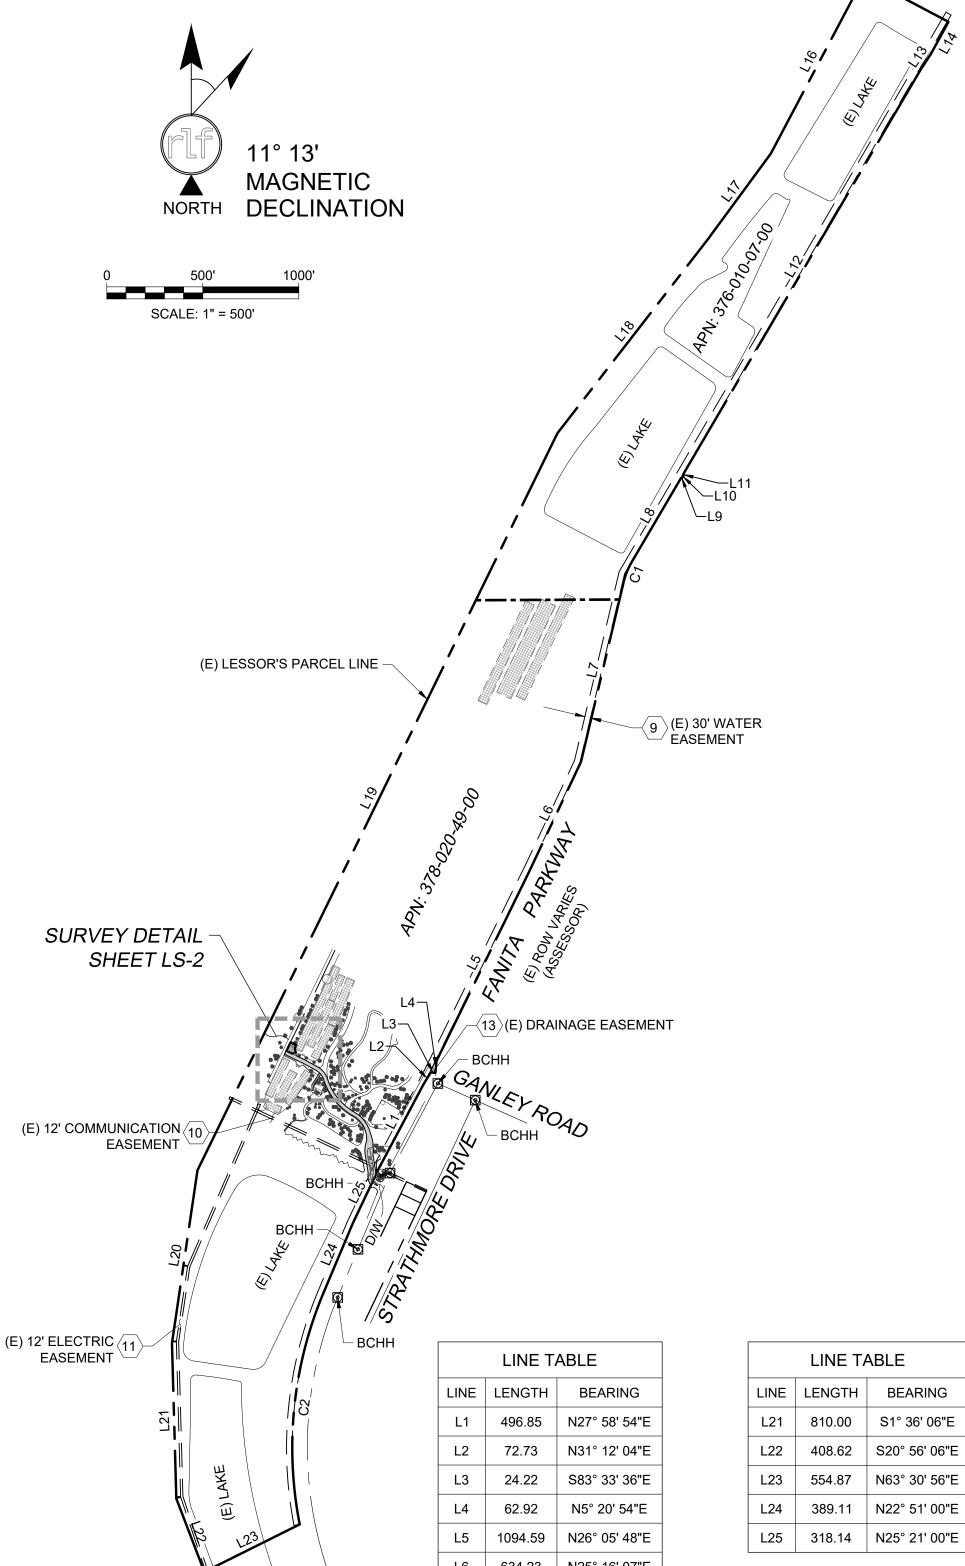

		C	CURVE TA	BLE	
CURVE	LENGTH	RADIUS	DELTA	CHORD BRG.	CHORD LENGTH
C1	111.57	375.00	17°02'48"	S21° 52' 48"W	111.16
C2	1231.57	2080.00	33°55'30"	S5° 53' 15"W	1213.66



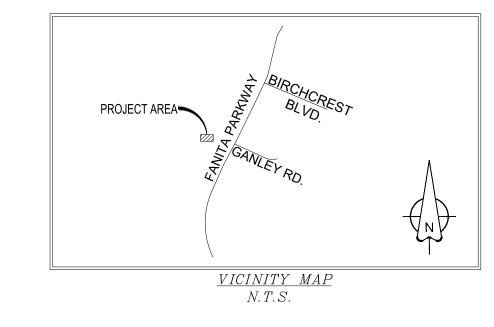

LESSOR'S LEGAL DESCRIPTION
THE LAND REFERRED TO HEREIN BELOW IS SITUATED SAN DIEGO, IN THE COUNTY OF SAN DIEGO, STATE OF CALIFORNIA, AND IS DESCRIBED AS FOLLOWS:

THOSE PORTIONS OF LOTS 8 AND 11 OF THE RESUBDIVISION OF A PART OF FANITA RANCHO, IN THE COUNTY OF SAN DIEGO, STATE OF CALIFORNIA, ACCORDING TO MAP THEREOF NO. 1703, FILED IN THE OFFICE OF THE COUNTY RECORDER OF SAN DIEGO COUNTY, FEBRUARY 28, 1912, DESCRIBED AS FOLLOWS:

COMMENCING AT THE MOST EASTERLY CORNER OF LOT 1065 OF CARLTON HILL3 UNIT NO. 5, ACCORDING TO MAP THEREOF NO. 4364, FILED IN THE OFFICE OF THE COUNTY RECORDER OF SAN DIEGO COUNTY, OCTOBER 14, 1959; THENCE ALONG THE NORTHEASTERLY LINE OF SAID LOT 1065 AND THE NORTHWESTERLY PROLONGATION THEREOF NORTH 64°36'54" WEST (RECORD - NORTH 64°39'00" WEST) 275.00 FEET TO AN ANGLE POINT IN THE SOUTHEASTERLY BOUNDARY OF THAT 30.00 FOOT WIDE EASEMENT FOR ROAD AND UTILITY PURPOSES AS DESCRIBED IN DEED TO SANTEE COUNTY WATER DISTRICT, RECORDED AUGUST 19, 1966 AS FILE NO. 134771 AND BEING THE TRUE POINT OF BEGINNING; THENCE ALONG SAID SOUTHEASTERLY BOUNDARY, NORTH 28°01'00" EAST, (RECORD - NORTH 27°54'27" EAST) 496.85 FEET; THENCE LEAVING SAID BOUNDARY NORTH 31°14'10" EAST, 72.73 FEET; THENCE SOUTH 83°31'30" EAST, 24.22 FEET; THENCE NORTH 05°23'00" EAST, 62.92 FEET; THENCE NORTH 26°07'54" EAST, 1094.59 FEET; THENCE NORTH 25°18'13" EAST, 634.23 FEET; THENCE NORTH 13°23'30" EAST, 963.35 FEET TO THE BEGINNING OF A TANGENT 375.00 FOOT RADIUS CURVE, CONCAVE SOUTHEASTERLY; THENCE NORTHEASTERLY ALONG THE ARC OF SAID CURVE THROUGH A CENTRAL ANGLE OF 17°02'47" A DISTANCE OF 111.57 FEET; THENCE TANGENT TO SAID CURVE NORTH 30°26'17" EAST, 507.30 FEET; THENCE NORTH 60°26'17" EAST, 10.00 FEET; THENCE NORTH 30°26'17" EAST, 10.00 FEET; THENCE NORTH 00°26'17" EAST, 10.00 FEET; THENCE NORTH 30°26'17" EAST, 2443.02 FEET; THENCE NORTH 33°27'17" EAST, 91.32 FEET; THENCE NORTH 28°44'34" EAST, 193.84 FEET TO THE MOST SOUTHERLY CORNER OF LAND DESCRIBED IN DEED TO SANTEE COUNTY WATER DISTRICT. RECORDED MAY 9, 1966 AS FILE NO. 77362; THENCE ALONG THE SOUTHWESTERLY LINE OF SAID LAND NORTH 62°06'50" WEST, 497.55 FEET (RECORD - NORTH 62°33'00" WEST, 500.00 FEET) TO THE NORTHWESTERLY BOUNDARY OF LAND DESCRIBED IN DEED TO CARLTON SANTEE CORP., RECORDED SEPTEMBER 26, 1956 IN BOOK 6275, PAGE 68 OF OFFICIAL RECORDS; THENCE ALONG SAID NORTHWESTERLY BOUNDARY AS FOLLOWS: SOUTH 27°53'10" WEST 1039.18 FEET (RECORD - SOUTH 27°27'00" WEST, 1039.86 FEET) TO AN ANGLE POINT THEREIN; SOUTH 36°21'00" WEST, 559.10 FEET (RECORD - SOUTH 35°55'00" WEST, 559.15 FEET) TO AN ANGLE POINT THEREIN; SOUTH 37°50'10" WEST, 1.273.12 FEET (RECORD - SOUTH 37°23'30" WEST, 1273.42 FEET) TO AN ANGLE POINT THEREIN; AND SOUTH 26°03'50" WEST (RECORD - SOUTH 25°37'30" WEST) 4271.79 FEET; THENCE LEAVING SAID BOUNDARY SOUTH 08°26'00 WEST, 910.19 FEET; THENCE SOUTH 01°34'00" EAST, 810.00 FEET; THENCE SOUTH 20°54'00" EAST, 408.62 FEET TO THE NORTHWESTERLY CORNER OF LAND DESCRIBED IN DEED TO SANTEE COUNTY WATER DISTRICT, RECORDED MAY 4, 1965 AS FILE NO. 79629; THENCE ALONG THE NORTHWESTERLY LINE OF SAID LAND NORTH 63°33'02" EAST, 554.87 FEET (RECORD - 553.67 FEET) TO THE SOUTHEASTERLY CORNER OF SAID 30.00 FOOT WIDE EASEMENT FIRST HEREINABOVE REFERRED TO, BEING A POINT ON THE ARC OF A 2080.00 FOOT RADIUS CURVE, CONCAVE EASTERLY, A RADIAL LINE OF SAID CURVE BEARS SOUTH 78°57'36" WEST (RECORD – SOUTH 78°58'31" WEST) TO SAID POINT: THENCE ALONG THE SOUTHEASTERLY BOUNDARY OF SAID 30.00 FOOT WIDE EASEMENT AS FOLLOWS: NORTHEASTERLY ALONG THE ARC OF SAID CURVE THROUGH A CENTRAL ANGLE OF 33°55'30" A DISTANCE OF 1231.57 FEET (RECORD - CENTRAL ANGLE OF 33°52'29" A DISTANCE OF 1229.75 FEET); TANGENT TO SAID CURVE. NORTH 22°53'06" EAST. (RECORD – NORTH 22°51'00" EAST) 389.11 FEET; AND NORTH 25°23'06" EAST (RECORD - NORTH 25°21'00" EAST) 318.14 FEET TO THE TRUE POINT OF BEGINNING.



DECIDUOUS TREE

BOLLARD

SPOT ELEVATION

SCHEDULE B HEX

POSITION OF GEOLE

PROPERTY LINE
CENTERLINE
CHAIN LINK FENCE

SANITARY SEWER MANHOLE






FIELD BY:	CEF
DRAWN BY:	JTJ
CHECKED BY:	RLF

REVISIONS

4	03/14/24	REVISION						
3	10/06/21	REVIEW DOCUMENTS						
2	09/16/21	TOWER RELOCATION						
1	09/15/21	TITLE REVIEW						
0	08/12/21	PRELIMINARY						
NO.	DATE	DESCRIPTION						
	1	-						



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REUSE OF DOCUMENT
THE IDEAS & DESIGN INCORPORATED HEREON, AS AN INSTRUMENT OF PROFESSIONAL SERVICE, IS THE PROPERTY OF RLF CONSULTING, LLC & IS NOT TO BE USED FOR ANY OTHER PROJECT WITHOUT WRITTEN AUTHORIZATION OF RLF CONSULTING, LLC.

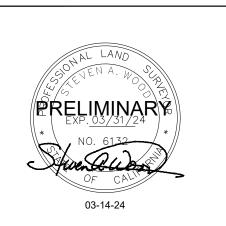PROJECT No. 130031080

SITE NAME:

SANTEE

SITE ADDRESS:

APN: 378-020-49-00 SANTEE, CA 92071

SHEET TITLE:


TOPOGRAPHIC SURVEY


SHEET NO.

3

REVISION:



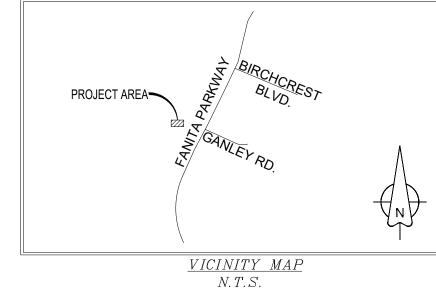


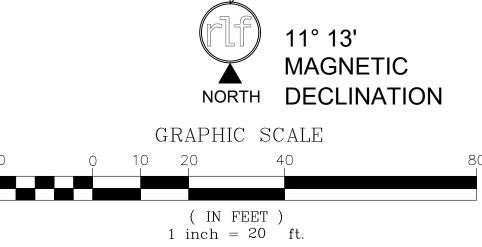

LEGEND

- BRASS CAP IN HANDHOLE (BCHH)
- SANITARY SEWER MANHOLE
- DECIDUOUS TREE BOLLARD
- × 5280.00 NG SPOT ELEVATION
 - 2 SCHEDULE B HEX
- POSITION OF GEODETIC COORDINATES PROPERTY LINE
- CENTERLINE CHAIN LINK FENCE




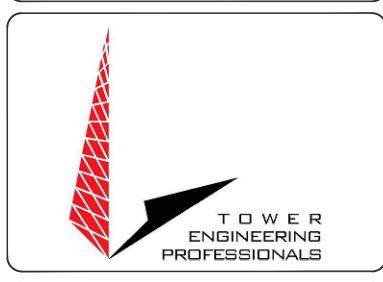

FIELD BY:	CEF
DRAWN BY:	JTJ
CHECKED BY:	RLF

	REVISIONS										
3	10/06/21	REVIEW DOCUMENTS									
2	09/16/21	TOWER RELOCATION									
1	09/15/21	TITLE REVIEW									
0	08/12/21	PRELIMINARY									
NO.	DATE	DESCRIPTION									



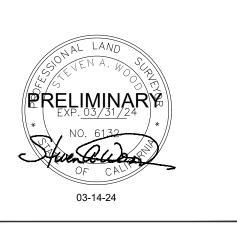

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PROJECT No. 130031080

SITE NAME: SANTEE

SITE ADDRESS: APN: 378-020-49-00 SANTEE, CA 92071

SHEET TITLE: TOPOGRAPHIC SURVEY

> SHEET NO. LS-2

9

REVISION:

GENERAL NOTES:

- ALL REFERENCES TO TOWER OWNER IN THESE DOCUMENTS SHALL BE CONSIDERED ATLAS TOWER 1, LLC OR IT'S DESIGNATED REPRESENTATIVE.
- 2. ALL WORK PRESENTED ON THESE DRAWINGS MUST BE COMPLETED BY THE CONTRACTOR UNLESS NOTED OTHERWISE. THE CONTRACTOR MUST HAVE CONSIDERABLE EXPERIENCE IN PERFORMANCE OF WORK SIMILAR TO THAT DESCRIBED HEREIN. BY ACCEPTANCE OF THIS ASSIGNMENT, THE CONTRACTOR IS ATTESTING THAT HE DOES HAVE SUFFICIENT EXPERIENCE AND ABILITY, THAT HE IS KNOWLEDGEABLE OF THE WORK TO BE PERFORMED AND THAT HE IS PROPERLY LICENSED AND PROPERLY REGISTERED TO DO THIS WORK IN THE STATE OF CALIFORNIA.
- 3. STRUCTURE IS DESIGNED IN ACCORDANCE WITH ANSI/TIA/EIA-222-H, 2017, THIS CONFORMS TO THE REQUIREMENTS OF THE INTERNATIONAL BUILDING CODE, 2018 EDITION.
- 4. WORK SHALL BE COMPLETED IN ACCORDANCE WITH THE INTERNATIONAL BUILDING CODE, 2018 EDITION.
- 5. UNLESS SHOWN OR NOTED OTHERWISE ON THE CONTRACT DRAWINGS, OR IN THE SPECIFICATIONS, THE FOLLOWING NOTES SHALL APPLY TO THE MATERIALS LISTED HEREIN, AND TO THE PROCEDURES TO BE USED ON THIS PROJECT.
- ALL HARDWARE ASSEMBLY MANUFACTURER'S INSTRUCTIONS SHALL BE FOLLOWED EXACTLY AND SHALL SUPERCEDE ANY CONFLICTING NOTES ENCLOSED HEREIN.
- 7. IT IS THE CONTRACTOR'S SOLE RESPONSIBILITY TO DETERMINE ERECTION PROCEDURE AND SEQUENCE TO ENSURE THE SAFETY
 OF THE STRUCTURE AND IT'S COMPONENT PARTS DURING ERECTION AND/OR FIELD MODIFICATIONS. THIS INCLUDES, BUT IS
 NOT LIMITED TO, THE ADDITION OF TEMPORARY BRACING, GUYS OR TIE DOWNS THAT MAY BE NECESSARY. SUCH MATERIAL
 SHALL BE REMOVED AND SHALL REMAIN THE PROPERTY OF THE CONTRACTOR AFTER THE COMPLETION OF THE PROJECT.
- B. ALL DIMENSIONS, ELEVATIONS, AND EXISTING CONDITIONS SHOWN ON THE DRAWINGS SHALL BE FIELD VERIFIED BY THE CONTRACTOR PRIOR TO BEGINNING ANY MATERIALS ORDERING, FABRICATION OR CONSTRUCTION WORK ON THIS PROJECT. CONTRACTOR SHALL NOT SCALE CONTRACT DRAWINGS IN LIEU OF FIELD VERIFICATIONS. ANY DISCREPANCIES SHALL BE IMMEDIATELY BROUGHT TO THE ATTENTION OF THE OWNER AND THE OWNER'S ENGINEER. THE DISCREPANCIES MUST BE RESOLVED BEFORE THE CONTRACTOR IS TO PROCEED WITH THE WORK. THE CONTRACT DOCUMENTS DO NOT INDICATE THE METHOD OF CONSTRUCTION. THE CONTRACTOR SHALL SUPERVISES AND DIRECT THE WORK AND SHALL BE SOLELY RESPONSIBLE FOR ALL CONSTRUCTION MEANS, METHODS, TECHNIQUES, SEQUENCES, AND PROCEDURES. OBSERVATION VISITS TO THE SITE BY THE OWNER AND/OR THE ENGINEER SHALL NOT INCLUDE INSPECTION OF THE PROTECTIVE MEASURES OR THE PROCEDURES.
- 9. ALL MATERIALS AND EQUIPMENT FURNISHED SHALL BE NEW AND OF GOOD QUALITY, FREE FROM FAULTS AND DEFECTS AND IN CONFORMANCE WITH THE CONTRACT DOCUMENTS. ANY AND ALL SUBSTITUTIONS MUST BE PROPERLY APPROVED AND AUTHORIZED IN WRITING BY THE OWNER AND ENGINEER PRIOR TO INSTALLATION. THE CONTRACTOR SHALL FURNISH SATISFACTORY EVIDENCE AS TO THE KIND AND QUALITY OF THE MATERIALS AND EQUIPMENT BEING SUBSTITUTED.
- 10. THE CONTRACTOR SHALL BE RESPONSIBLE FOR INITIATING, MAINTAINING, AND SUPERVISING ALL SAFETY PRECAUTIONS AND PROGRAMS IN CONNECTION WITH THE WORK. THE CONTRACTOR IS RESPONSIBLE FOR INSURING THAT THIS PROJECT AND RELATED WORK COMPLIES WITH ALL APPLICABLE LOCAL, STATE, AND FEDERAL SAFETY CODES AND REGULATIONS GOVERNING THIS WORK.
- 11. ACCESS TO THE PROPOSED WORK SITE ON THE PROPERTY IS RESTRICTED AND CONTROLLED. THE CONTRACTORS SHALL COORDINATE INTENDED CONSTRUCTION ACTIVITY INCLUDING MATERIALS DELIVERY AND ACCESS WITH PROPERTY OWNER. ADDITIONALLY, THE GATE(S) MUST BE CLOSED AND LOCKED EACH TIME THE CONTRACTORS ENTER THE PROPERTY, GATE(S) MUST REMAIN CLOSED DURING ALL WORK. WHEN CONTRACTORS LEAVE THE PROPERTY THE GATE(S) MUST BE SECURED WITH THE LOCKS, THE GATE CABLE MUST BE LOCKED, AND THE PYLON MUST BE PLACED IN THE CENTER OF THE CABLE.
- 12. BILL OF MATERIALS AND PART NUMBERS LISTED ON CONSTRUCTION DRAWINGS ARE INTENDED TO AID CONTRACTOR. CONTRACTOR SHALL VERIFY PARTS AND QUANTITIES WITH MANUFACTURER PRIOR TO BIDDING AND/OR ORDERING MATERIALS.
- 13. ALL PERMITS THAT MUST BE OBTAINED ARE THE RESPONSIBILITY OF THE CONTRACTOR. THE CONTRACTOR WILL BE RESPONSIBLE FOR ABIDING BY ALL CONDITIONS AND REQUIREMENTS OF THE PERMITS.
- 14. 24 HOURS PRIOR TO THE BEGINNING OF ANY CONSTRUCTION, THE CONTRACTOR MUST NOTIFY THE APPLICABLE JURISDICTIONAL (STATE, COUNTY OR CITY) ENGINEER.
- 15. THE CONTRACTOR SHALL REWORK (DRY, SCARIFY, ETC.) ALL MATERIAL NOT SUITABLE FOR SUBGRADE IN IT PRESENT STATE. AFTER REWORKING, IF THE MATERIAL REMAINS UNSUITABLE, THE CONTRACTOR SHALL UNDERCUT THIS MATERIAL AND REPLACE WITH APPROVED MATERIAL. ALL SUBGRADES SHALL BE PROOFROLLED WITH A FULLY LOADED TANDEM AXLE DUMP TRUCK PRIOR TO PAVING. ANY SOFTER MATERIAL SHALL BE REWORKED OR REPLACED.
- 16. THE CONTRACTOR SHALL EXERCISE EXTREME CAUTION IN DIGGING, DRILLING, EXCAVATING, ETC. ON THE PROPERTY. ESPECIALLY SENSITIVE IS WORK IN AND NEAR THE 10'WIDE UTILITY EASEMENT AND BUILDINGS. THERE IS EXISTING INFRASTRUCTURE IN THIS AREA (UNDERGROUND UTILITIES, POWER LINES, WATER LINES, PUMPS, PIPES, WIRES, CISTERNS, IRRIGATION, PITS, DITCHES, DRAINAGE STRUCTURES, ETC.). THE PROPERTY OWNER MUST BE NOTIFIED IN ADVANCE OF ALL SUCH WORK AND MAY BE ON SITE FOR SUCH WORK. THE CONTRACTOR IS REQUIRED TO MAINTAIN AND PROTECT ALL EXISTING INFRASTRUCTURE. THE CONTRACTOR IS RESPONSIBLE FOR ANY DAMAGE BY FAILURE TO MAINTAIN THE EXISTING INFRASTRUCTURE IN OPERABLE CONDITION. THE CONTRACTOR IS REQUIRED TO MAINTAIN ALL EXISTING INFRASTRUCTURE AND ADDED STRUCTURES FREE FROM OBSTRUCTION UNTIL WORK IS ACCEPTED BY THE TOWER OWNER AND THE PROPERTY OWNER.
- 17. ALL MATERIALS AND WORKMANSHIP SHALL BE WARRANTED FOR ONE YEAR FROM ACCEPTANCE DATE.
- 18. ALL BUILDING DIMENSIONS SHALL BE VERIFIED WITH THE PLANS (LATEST REVISION) PRIOR TO COMMENCING CONSTRUCTION.

 NOTIFY THE ENGINEER IMMEDIATELY IF ANY DISCREPANCIES ARE DISCOVERED. THE OWNER SHALL HAVE A SET OF APPROVED PLANS AVAILABLE AT THE SITE AT ALL TIMES WHILE WORK IS BEING PERFORMED. A DESIGNATED RESPONSIBLE EMPLOYEE SHALL BE AVAILABLE FOR CONTACT BY GOVERNING AGENCY INSPECTORS.

STRUCTURAL STEEL NOTES:

- 1. THE FABRICATION AND ERECTION OF STRUCTURAL STEEL SHALL CONFORM TO THE AISC SPECIFICATION FOR MANUAL OF STEEL CONSTRUCTION, ALLOWABLE STRESS DESIGN, 9TH EDITION.
- 2. UNLESS OTHERWISE NOTED, ALL STURCTURAL ELEMENTS SHALL CONFORM TO THE FOLLOWING REQUIREMENTS:
 - A. STRUCTURAL STEEL, ASTM DESIGNATION A36 OR A992 GR50.
 - B. ALL BOLTS, ASTM A325 TYPE I GALVANIZED HIGH STRENGTH BOLTS.
 - C. ALL NUTS, ASTM A563 CARBON AND ALLOY STEEL NUTS.
 D. ALL WASHERS. ASTM F436 HARDENED STEEL WASHERS.
- ALL CONNECTIONS NOT FULLY DETAILED ON THESE PLANS SHALL BE DETAILED BY THE STEEL FABRICATOR IN ACCORDANCE WITH AISC SPECIFICATIONS FOR MANUAL OF STEEL CONSTRUCTION, 14TH FDITION
- 4. HOLES SHALL NOT BE FLAME CUT THRU STEEL UNLESS APPROVED BY THE ENGINEER.
- 5. HOT-DIP GALVANIZE ALL ITEMS ULESS OTHERWISE NOTED, AFTER FABRICATION WHERE PRACTICABLE. GALVANIZING: ASTM A123, ASTM, A153/A153M OR ASTM A653/A653M, G90, AS APPLICABLE.
- 6. REPAIR DAMAGED SURFACES WITH GALVANIZING REPAIR METHOD AND PAINT CONFORMING TO ASTM A780 OR BY APPLICATION OF STICK OR THICH PASTED MATERIAL SPECIFICALLY DESIGNED FOR REPAIR OF GALVANIZING. CLEAN AREAS TO BE REPAIRED AND REMOVE SLAG FROM WELDS. HEAT SURFACES TO WHICH STICK OR PASTE MATERIAL IS APPLIED, WITH A TORCH TO A TEMPERATURE SUFFICIENT TO MELT THE METALLICS IN STICK OR PASTED; SPREAD MOLTEN MATERIAL UNIFORMLY OVER SURFACES TO BE COATED AND WIPE OFF EXCESS MATERIAL.
- 7. A NUT LOCKING DEVICE SHALL BE INSTALLED ON ALL PROPOSED AND/OR REPLACED BOLTS.
- 8. ALL PROPOSED AN/OR REPLACED BOLTS SHALL BE OF SUFFICIENT LENGTH TO EXCLUDE THE THREADS FROM THE SHEAR PLANE.
- . ALL PROPOSED AND/OR REPLACED BOLTS SHALL BE OF SUFFICIENT LENGTH SUCH THAT THE END OF THE BOLT BE AT LEAST FLUSH WITH THE FACE OF THE NUT. IT IS NOT PERMITTED FOR THE BOLT END TO BE BELOW THE FACE OF THE NUT AFTER TIGHTENING IS COMPLETED.
- 10. ALL ASSEMBLY AND ANCHOR BOLTS ARE TO BE TIGHTENED TO A "SNUG TIGHT" CONDITION AS DEFINED IN SECTION 8.1 OF THE AISC, "SPECIFICATION FOR STRUCTURAL JOINTS USING ASTM A325 OR A490 BOLTS", DATED JUNE 30, 2004.
- 11. FLAT WASHERS ARE TO BE INSTALLED WITH BOLTS OVER SLOTTED HOLES.
- 12. DO NOT OVER TORQUE ASSEMBLY BOLTS. GALVANIZING ON BOLTS, NUTS, AND STEEL PARTS; MAY ACT AS A LUBRICANT, THUS OVER TIGHTENING MAY OCCUR AND MAY CAUSE BOLTS TO CRACK AND SNAP OFF.
- 13. PAL NUTS ARE TO BE INSTALLED AFTER NUTS ARE TIGHT AND WITH EDGE LIP OUT. PAL NUTS ARE NOT REQUIRED WHEN SELF-LOCKING NUTS ARE PROVIDED.
- 14. GALVANIZED ASTM A325 BOLTS SHALL NOT BE REUSED.
- 15. WELDING SHALL BE PERFORMED IN ACCORDANCE WITH AMERICAN WELDING SOCIETY (AWS) D1.1-2010 STRUCTURAL WELDING CODE STEEL.

PROJECT INFORMATION:

SANTEE

10400-CS FANITA PARKWAY SANTEE, CA 92071 (SAN DIEGO COUNTY)

PLANS PREPARED FOR:




2500 30TH ST., SUITE 304 BOULDER, CO 80301 Office: (303) 448-8896

PLANS PREPARED BY:



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4	08-02-24	PRELIMINARY
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1	05-15-24	PRELIMINARY
0	04-08-24	PRELIMINARY
REV	DATE	ISSUED FOR:

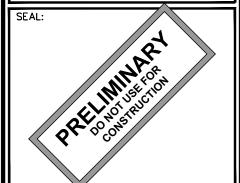DRAWN BY: ASD CHECKED BY: KES

SHEET TITLE:

GENERAL NOTES

SHEET NUMBER:

REVISION:

TEP#:305146.943556

N-1

TOWER 1-A COORDINATES

N 32° 52' 06.183" (NAD '83) LATITUDE: W 117° 00' 27.534" (NAD '83) LONGITUDE:

GROUND ELEVATION: 399.0'± (AMSL NAVD '88)

LEGEND

PARENT PROPERTY LINE

ADJACENT PROPERTY LINE

EASEMENT/LEASE CORNER

EXIST. METER M

XFMR EXIST. TRANSFORMER

β EXIST. UTILITY POLE

 \odot EXIST. TELCO PEDESTAL

PROPERTY CORNER

---500--- EXIST. CONTOUR LINE

EDGE OF PAVEMENT

---OHW--- OVERHEAD WIRE ----F---- BURIED FIBER

----G---- GAS LINE


---R/W--- RIGHT-OF-WAY

— X — FENCE

EXISTING TREE LINE

NOTES:

- BEARINGS SHOWED HEREON ARE BASED UPON U.S. STATE PLANE NAD83 COORDINATE SYSTEM CALIFORNIA STATE PLANE COORDINATE ZONE VI, DETERMINED BY GPS OBSERVATIONS.
- ELEVATIONS SHOWN HEREON ARE REPRESENTED IN NORTH AMERICAN VERTICAL DATUM OF 1988 (NAVD88) ESTABLISHED FROM GPS DERIVED ELLIPSOID HEIGHTS, APPLYING GEOID 12B SEPARATIONS CONSTRAINING TO NGS CORS STATIONS PROVIDED IN THE "ONLINE POSITIONING USER SERVICE" (OPUS) SOLUTION FOR THIS SPECIFIC SITE.
- ALL DISTANCES ARE GROUND UNLESS OTHERWISE NOTED.
- PROPERTY LOCATED IN FLOOD ZONE "X", AREA DETERMINED TO BE OUTSIDE THE 0.2% CHANCE OF ANNUAL FLOOD BASED ON COMMUNITY-PANEL NO. 06073C1632G, EFFECTIVE DATE 05/16/2012.

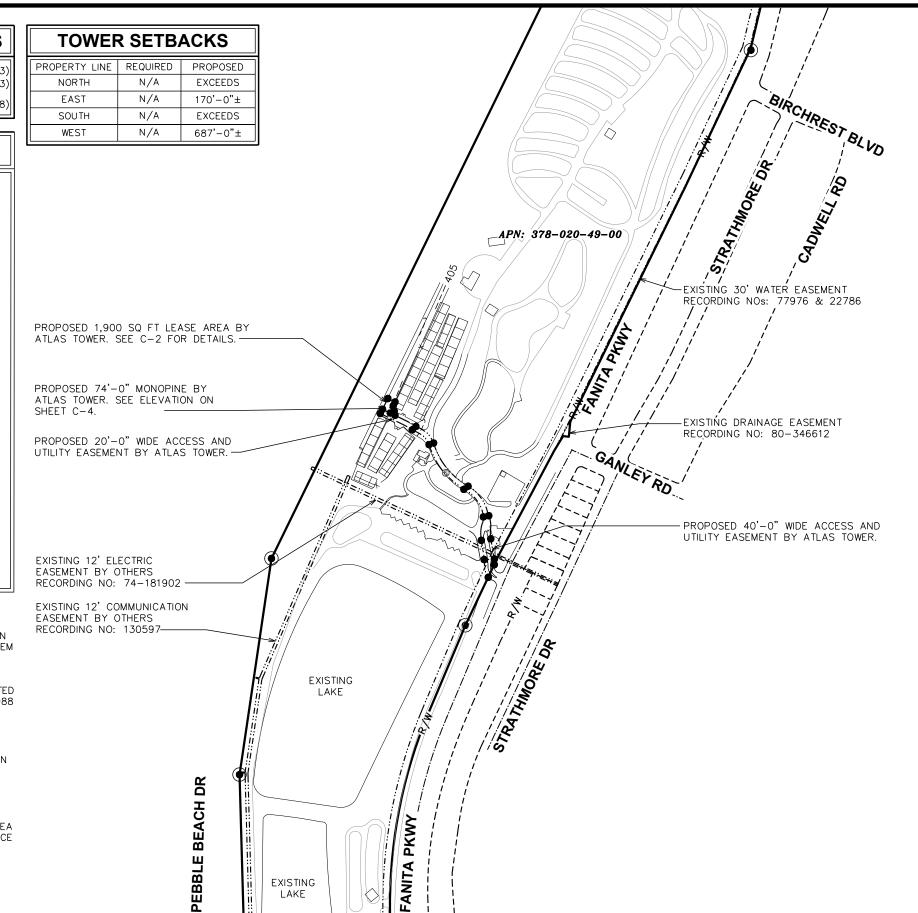

EXISTING LAKE

PROJECT INFORMATION:

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10400-CS FANITA PARKWAY SANTEE, CA 92071 (SAN DIEGO COUNTY)

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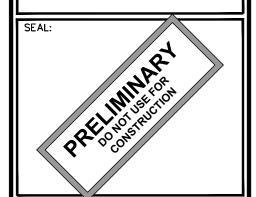


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4	08-02-24	PRELIMINARY

ASD CHECKED BY: DRAWN BY:

SHEET TITLE:

AREA PLAN

SHEET NUMBER:


REVISION:


TEP#:305146.9435

AREA PLAN

400 SCALE IN FEET

SCALE: 1" = 400'

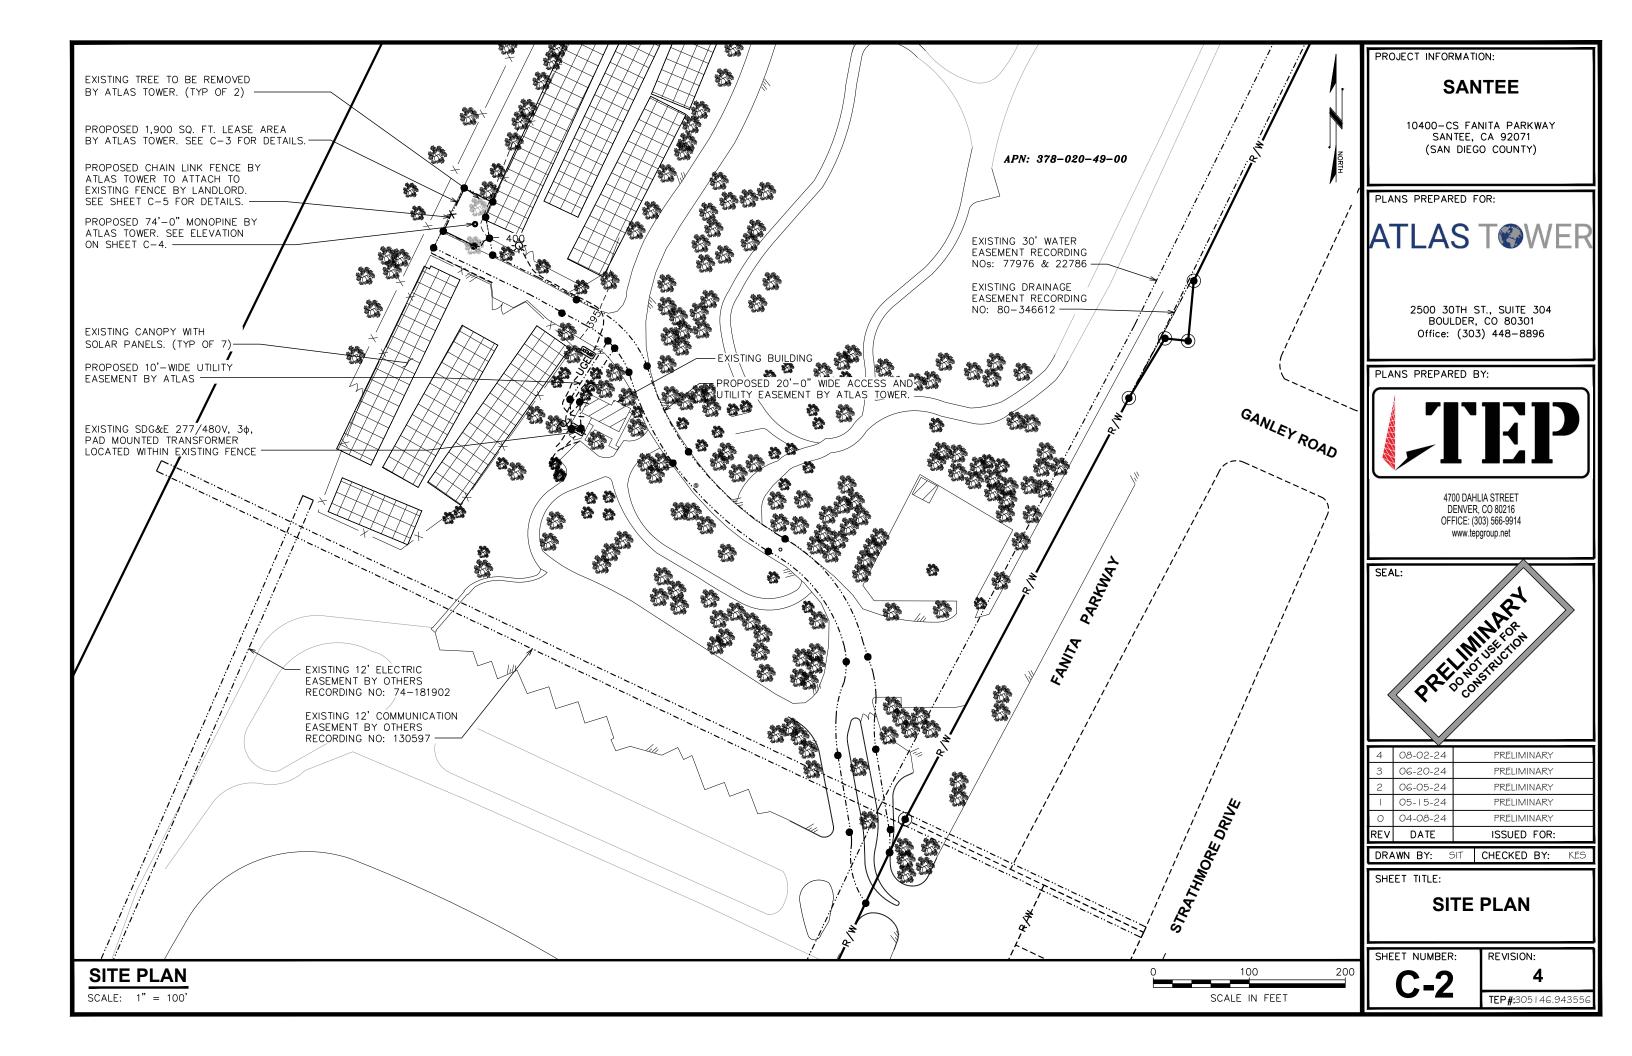

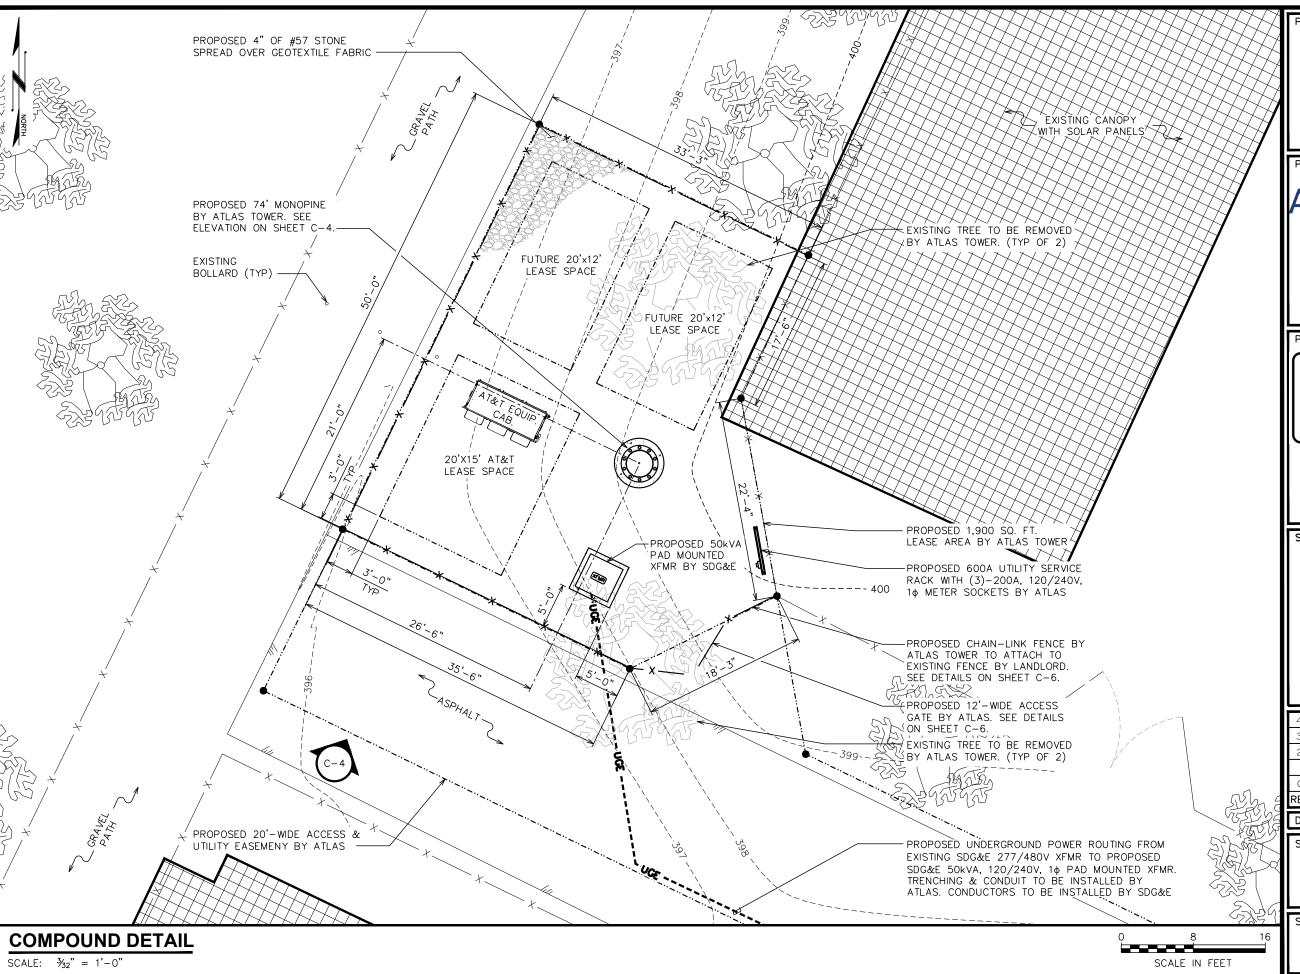

PROJECT INFORMATION:

SANTEE

10400-CS FANITA PARKWAY SANTEE, CA 92071 (SAN DIEGO COUNTY)

PLANS PREPARED FOR:




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4 08-02-24 PRELIMINARY 3 06-20-24 PRELIMINARY 2 06-05-24 PRELIMINARY 1 05-15-24 PRELIMINARY 0 04-08-24 PRELIMINARY	REV	DATE	ISSUED FOR:
3 06-20-24 PRELIMINARY 2 06-05-24 PRELIMINARY	0	04-08-24	PRELIMINARY
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	2	06-05-24	PRELIMINARY
4 08-02-24 PRELIMINARY	3	06-20-24	PRELIMINARY
	4	08-02-24	PRELIMINARY

DRAWN BY: ASD CHECKED BY: KES

SHEET TITLE:


COMPOUND DETAIL

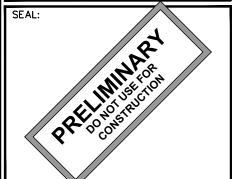SHEET NUMBER:

REVISION:

NOTES:

- 1. TOWER TO BE DISGUISED AS A FAUX EVERGREEN TREE USING NON-REFLECTIVE MATERIALS. REALISTIC FAUX PINE BARK WILL BE PROVIDED FROM 1' AGL TO 25' AGL. BROWN PAINT WILL CONCEAL THE MONOPOLE FORM 25' TO TOP.
- 2. ANTENNAS & MOUNTED EQUIPMENT TO BE PAINTED A NON-REFLECTIVE COLOR THAT EFFECTIVELY BLENDS WITH THE AREA. FINAL DETERMINATION OF COLOR SHALL BE SUBJECT TO APPROVAL OF THE REVIEW AUTHORITY.
- 3. ANTENNA SOCKS TO BE USED ON ALL PROPOSED ANTENNAS ON THE TOWER
- 4. TOWER SHALL NOT BE LIT UNLESS REQUIRED BY FEDERAL COMMUNICATIONS COMMISSION (FCC) OR FEDERAL AVIATION ADMINISTRATION (FAA).
- 5. PROPOSED COAX ROUTED INSIDE TOWER WITH HOISTING GRIPS.
- 6. TOWER NOT TO INCLUDE STEP PEGS OR SAFETY CLIMB.

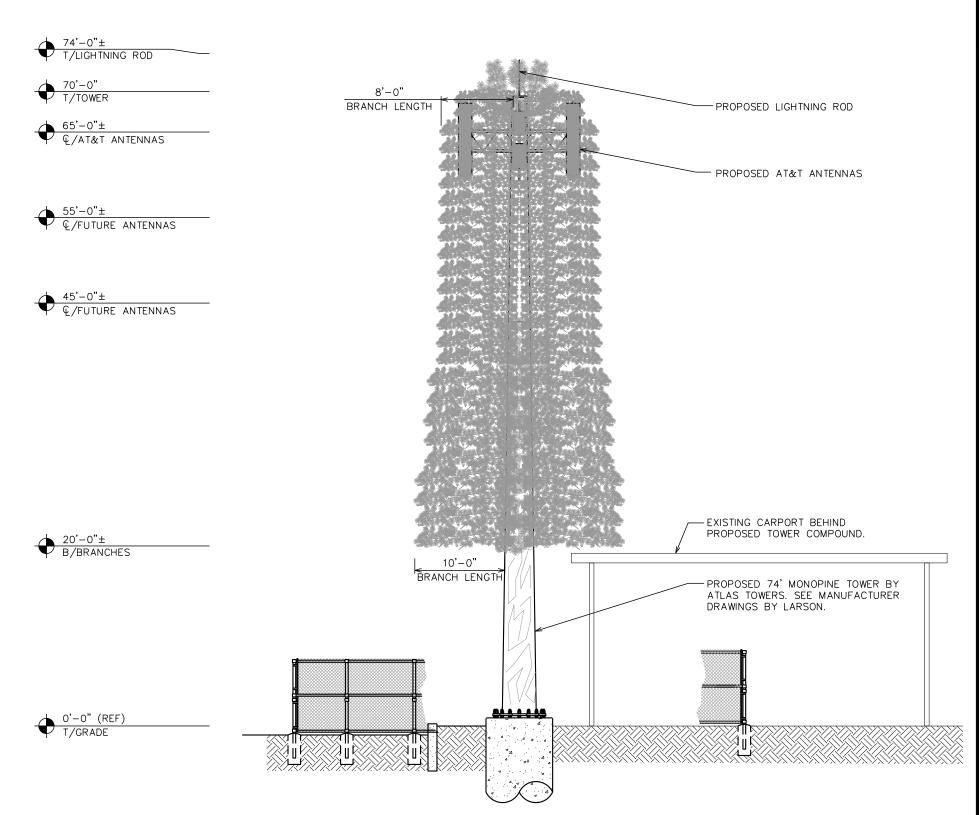

PROJECT INFORMATION:

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10400-CS FANITA PARKWAY SANTEE, CA 92071 (SAN DIEGO COUNTY)

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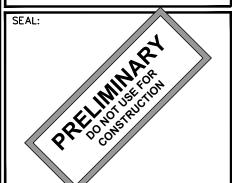


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REV	DATE	ISSUED FOR:

DRAWN BY: ASD CHECKED BY: KES

SHEET TITLE:

TOWER ELEVATION

SHEET NUMBER:

REVISION:

TEP#:305146.943556

TOWER ELEVATION

SCALE: $\frac{3}{32}$ " = 1'-0"

SCALE IN FEET

ANTENNA/COAX SCHEDULE

SEC.	STATUS	AZ.	POSITION	QTY.	MFG.	MODEL	HxWxD (in)	SERVICE	ANT. ﴿ (AGL)		. TILT MECH	RRH COUNT	SURGE PROTECTION	COAX/CABLE RUN	COAX/CABLE LENGTH
	PROPOSED	30°			0011160000	NAME	05 0 40 6 7 75	700	05' 0"	0.	0.	(1) 4449 B5/B12			
	PROPOSED 30	A-1	l	COMMSCOPE	NNH4-65C-R6V3	95.9x19.6x7.75	AWS	65'-0"± 0°		(1) 8843 B2/B66A					
ALPHA	PROPOSED	30°	A-2	1	ERICSSON	AIR 6419 B77G AIR 6449 B77D	28.2×16.1×7.2	700	65'-0"±	0.	0.	_	_	(1) 1¼" HYBRID	90'-0"±
"X"						(STACKED)	33.1×20.5×8.3	AWS			_			CABLE	
	PROPOSED	30°	A-3	1	COMMSCOPE	NNH4-65C-R6V3	95.9×19.6×7.75	700	65'-0"±	0.	0.	(1) 4478 B14			
	PROPOSED	30	A-3	ı	COMMSCOPE	NNH4-63C-R6V3	93.9x19.0x7.73	AWS	65 -U ±			(1) 4476 614			
			_					700				(1) 4449 B5/B12			
	PROPOSED	130°	B-1	1	COMMSCOPE	NNH4-65C-R6V3	95.9x19.6x7.75	AWS	65'-0"± 0°	0,	(1) 8843 B2/B66A				
BETA	PROPOSED	130°	B-2	1	ERICSSON	AIR 6419 B77G AIR 6449 B77D	28.2×16.1×7.2	700	65'-0"±	0.	0,	_	_	(1) 1¼" HYBRID CABLE	90'-0"±
"Y"	FNOFOSED	130	D 2	<u>'</u>	LINICSSON	(STACKED)	33.1×20.5×8.3	AWS	03 -0 1						
	PROPOSED	130°	B-3		COMMSCOPE	NAME OF CORRESPONDENCE	95.9×19.6×7.75	700	05' 0"	0.	0.	(1) 4478 B14			
	PROPOSED	130	B-3	ļ	COMMSCOPE	NNH4-65C-R6V3	95.9x19.6x7.75	AWS	65'-0"±		0	(1) 4470 614			
			_					700				(1) 4449 B5/B12			
	PROPOSED	200°	C-1	1	COMMSCOPE	NNH4-65C-R6V3	95.9x19.6x7.75	AWS	65'-0"±	0,	0°	(1) 8843 B2/B66A			
 GAMMA	DDODOCED	200°	C-2	1	ERICSSON	AIR 6419 B77G AIR 6449 B77D	28.2×16.1×7.2	700	65' 6"	0.	0.		(1) 1	(1) 1¼" HYBRID	90'-0"±
"Z"	PROPOSED	200	C-2	'	EKICSSON	(STACKED)	33.1×20.5×8.3	AWS	65'-0"±		0°	_		CABLE	90-0 ±
	DDODOCES	200°	6. 7	1	COMMISSORE	NAULA CEO DOVZ	0F 0.10 C.7 75	700	05' 0":	0.	0.	(1) 4479 D14			
	PROPOSED	200°	C-3	l l	COMMSCOPE	NNH4-65C-R6V3	95.9×19.6×7.75	AWS	65'-0"±		0°	(1) 4478 B14			

NOTE: CONTRACTOR TO VERIFY WITH FINAL RFDS BEFORE ORDERING OR INSTALLING ANY EQUIPMENT. PROJECT INFORMATION:

SANTEE

10400-CS FANITA PARKWAY SANTEE, CA 92071 (SAN DIEGO COUNTY)

PLANS PREPARED FOR:




2500 30TH ST., SUITE 304 BOULDER, CO 80301 Office: (303) 448-8896

PLANS PREPARED BY:



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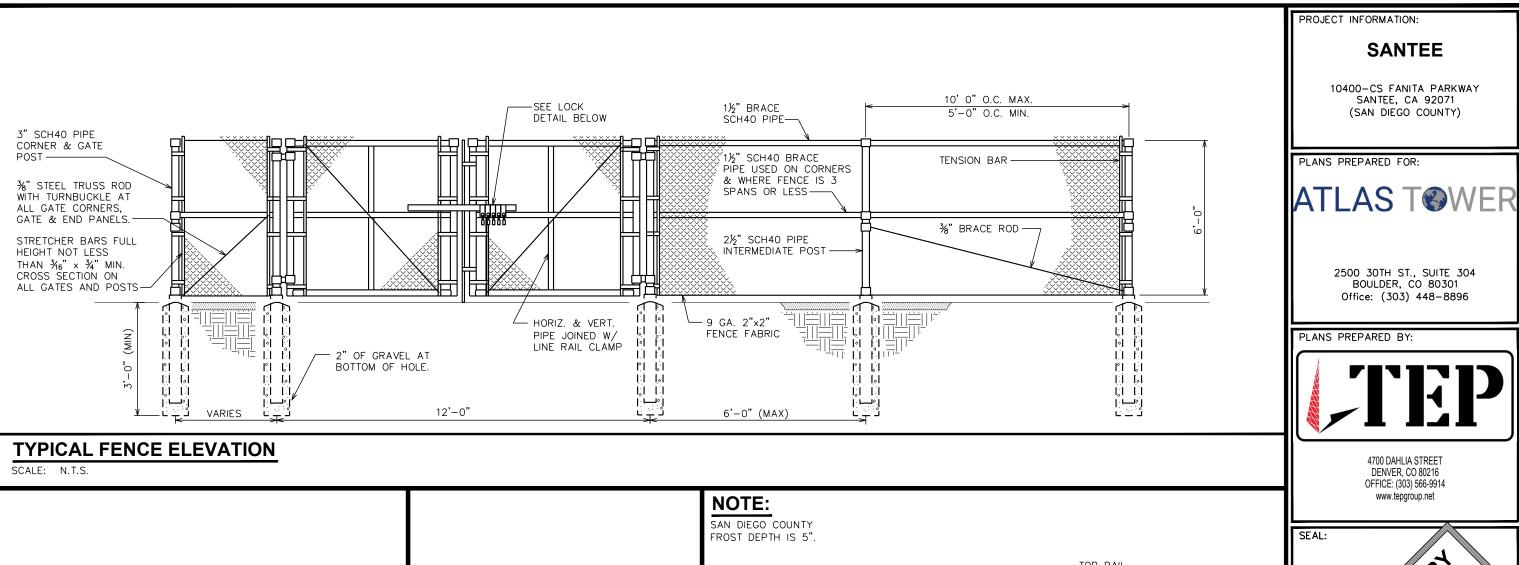
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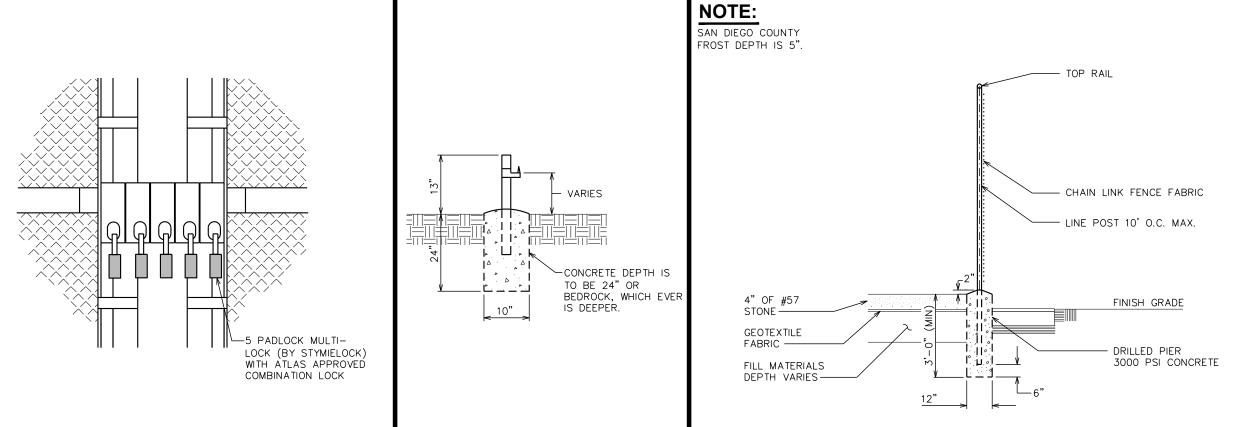
AT&T ANTENNA SCHEDULE

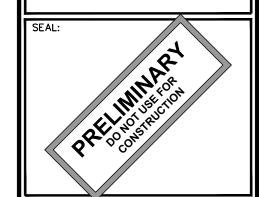SHEET NUMBER:

REVISION:

CHECKED BY:





PRELIMINARY 08-02-24 06-20-24 PRELIMINARY 06-05-24 PRELIMINARY PRELIMINARY 05-15-24 PRELIMINARY 04-08-24

SANTEE

10400-CS FANITA PARKWAY

SANTEE, CA 92071

(SAN DIEGO COUNTY)

2500 30TH ST., SUITE 304 BOULDER, CO 80301

Office: (303) 448-8896

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OFFICE: (303) 566-9914 www.tepgroup.net

ASD CHECKED BY: DRAWN BY:

SHEET TITLE:

DATE

REV

FENCE DETAILS

SHEET NUMBER:

REVISION:

ISSUED FOR:

TEP#:305146.9435


GATE STOP/KEEPER DETAIL

FENCE PROFILE DETAIL SCALE: N.T.S.

SCALE: N.T.S.

GATE LOCK DETAIL

SCALE: N.T.S.

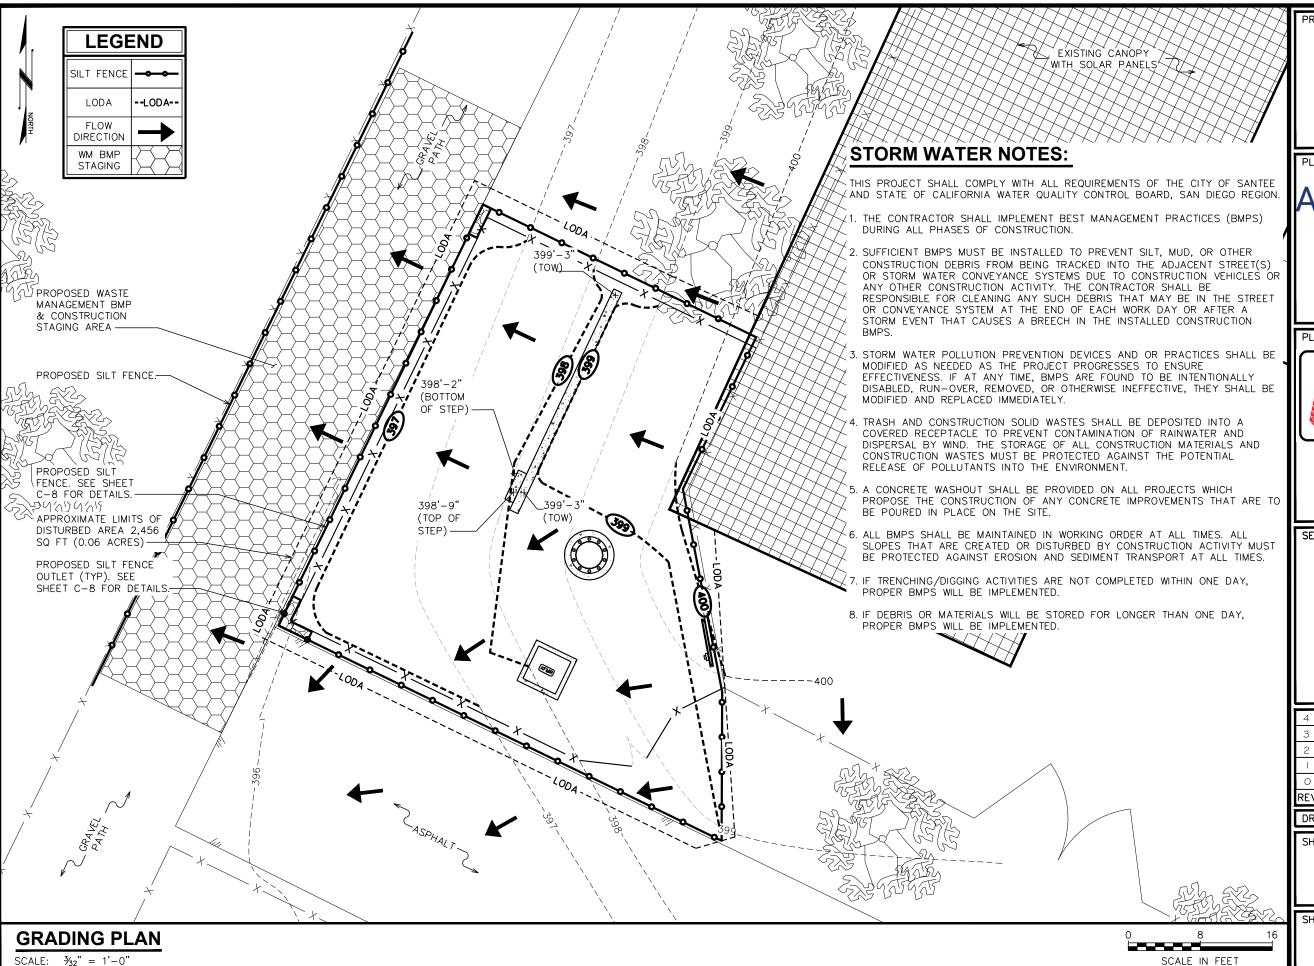

PROJECT INFORMATION:

SANTEE

10400-CS FANITA PARKWAY SANTEE, CA 92071 (SAN DIEGO COUNTY)

PLANS PREPARED FOR:




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DRAWN BY: ASD CHECKED BY:

SHEET TITLE

GRADING & SOIL & EROSION CONTROL PLAN


SHEET NUMBER:

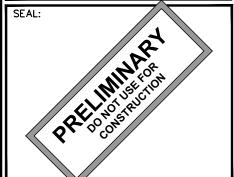C-7

REVISION:

NOTES:

- 1. FILTER FABRIC SHALL CONFORM TO THE REQUIREMENTS LISTED IN ASTM D 6461.
- 2. ENDS OF INDIVIDUAL FILTER FABRIC SHALL BE SECURELY FASTENED AT A SUPPORT POST WITH 4 FEET MINIMUM OVERLAP TO THE NEXT POST.
- 3. PLACE 12 INCHES OF FABRIC ALONG THE BOTTOM AND SIDE OF THE TRENCH.
- 4. INSPECT SEDIMENT FENCE(S) AT LEAST ONCE A WEEK AND AFTER EACH RAINFALL.
- 5. REMOVE SEDIMENT DEPOSITS AS NECESSARY TO PROVIDE ADEQUATE STORAGE VOLUME FOR THE NEXT RAIN AND TO REDUCE PRESSURE ON THE FFNCF
- 6. AFTER CONSTRUCTION IS COMPLETE, THE CONTRACTOR SHALL REMOVE ALL FENCING MATERIALS AND UNSTABLE SEDIMENT DEPOSITS, BRING THE AREA TO GRADE AND PROPERLY STABILIZE THE SITE.

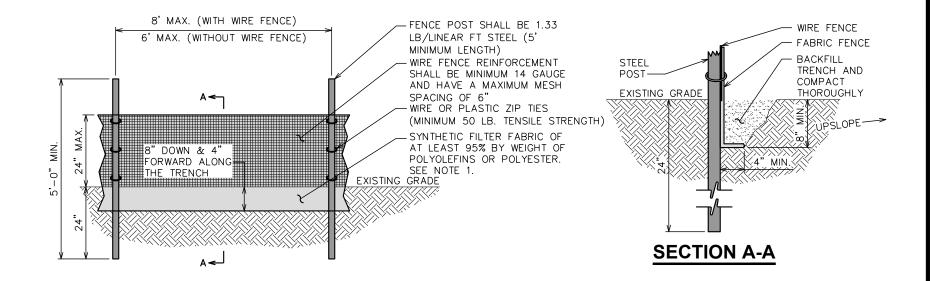

PROJECT INFORMATION:

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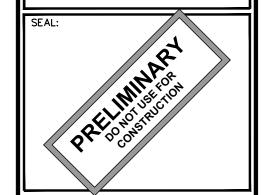


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4	08-02-24	PRELIMINARY

DRAWN BY: ASD CHECKED BY: K

SHEET TITLE:

SILT FENCE DETAILS


SHEET NUMBER:

REVISION:

TEP#:305146.94355


SILT FENCE DETAIL


SCALE: N.T.S.

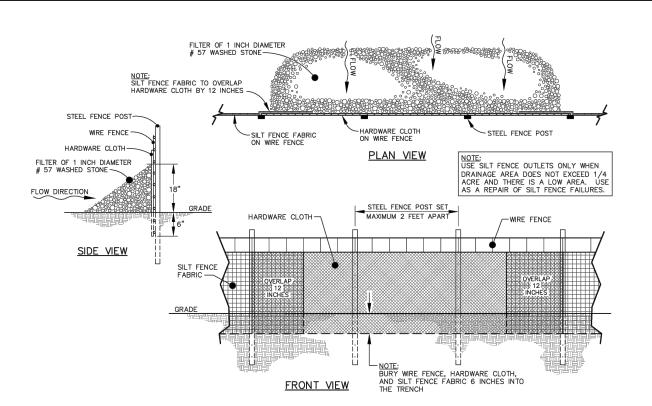

STANDARD SILT FENCE OUTLET DETAIL

SCALE: N.T.S

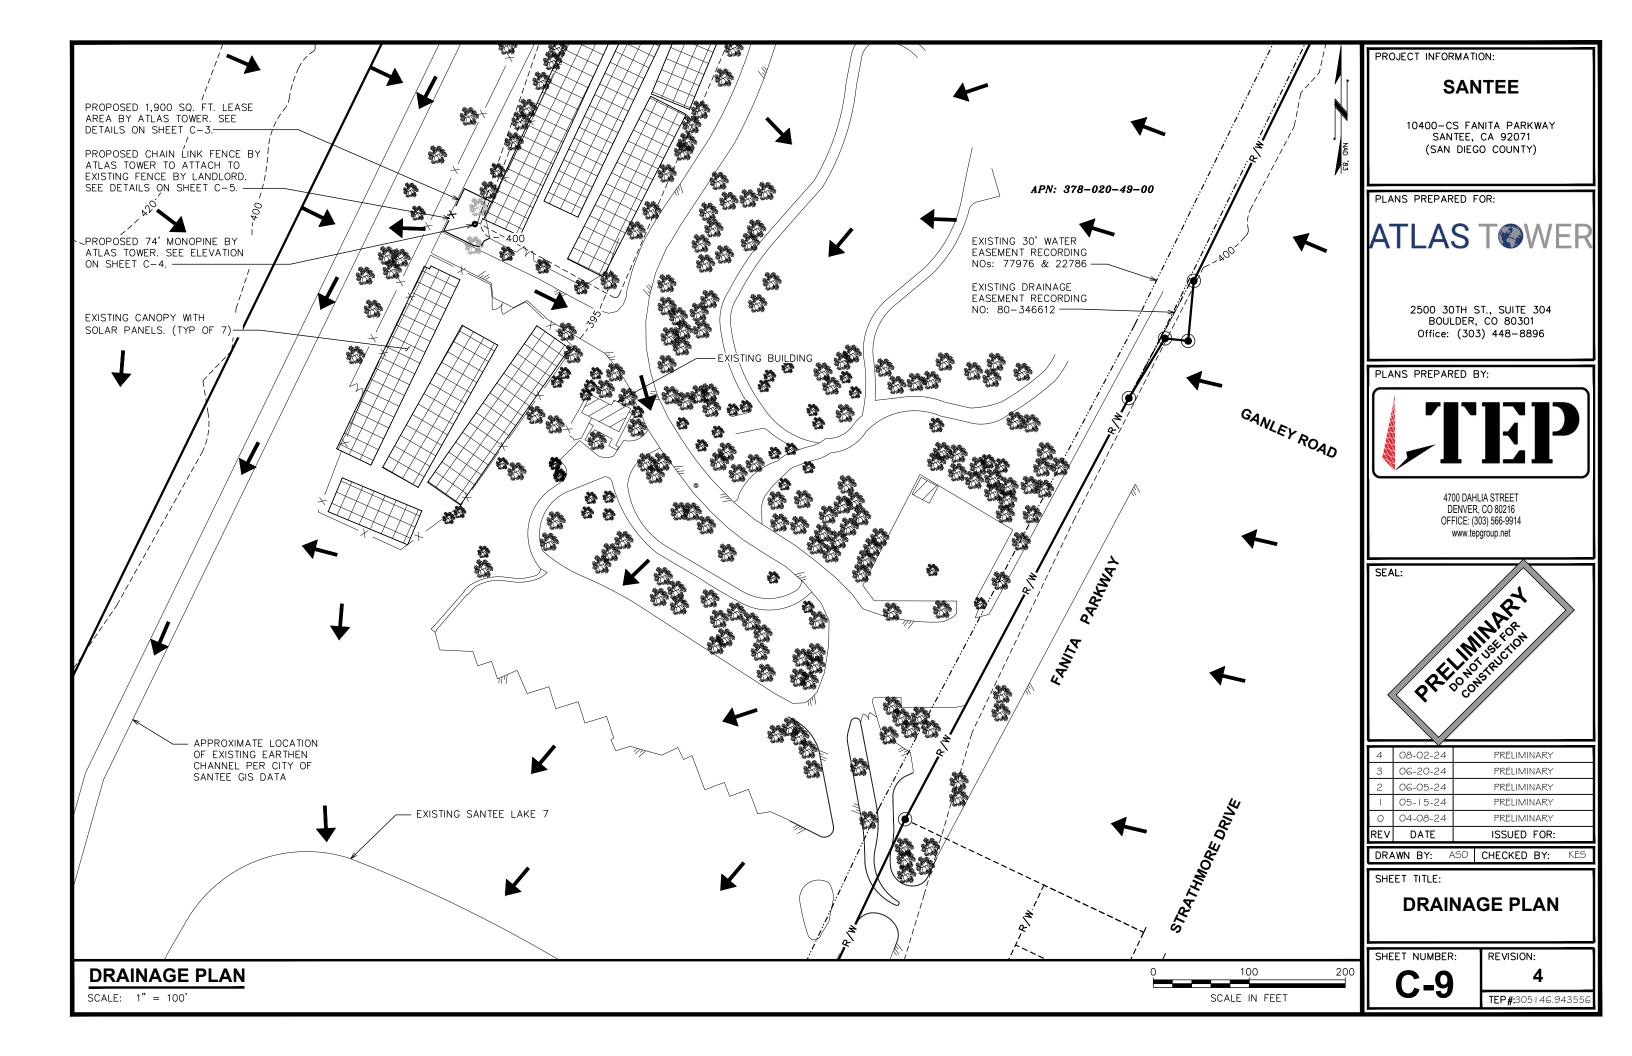

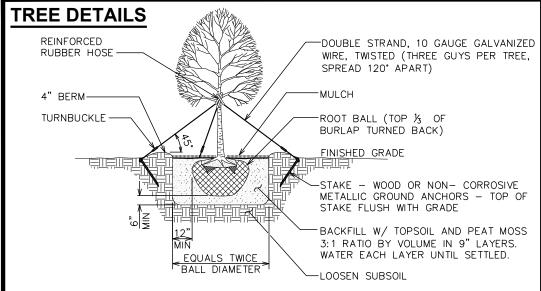


GENERAL LANDSCAPING NOTES

- 1. TOPSOIL TO BE PROVIDED BY SITE CONTRACTOR IN ROUGH GRADE TO WITHIN 1" OF FINISH GRADE.
- 2. EACH PLANT TO BE IN THE TOP OF ITS CLASS AFTER SHEARING AND PRUNING.
- 3. EACH PLANT TO BE FREE FROM DISEASE, INSECT INFESTATION, AND MECHANICAL INJURIES, AND IN ALL RESPECTS BE SUITABLE FOR FIELD PLANTING.
- PLANTS SHALL CONFORM TO THE AMERICAN STANDARD OF NURSURY STOCK, ANSI Z60.I-1973 IN REGARD TO SIZING, GROWING, AND B&B SPECIFICATIONS.
- 5. CONTRACTOR SHALL PROTECT ALL EXISTING TREES AND SHRUBS WITHIN CONSTRUCTION AREA IDENTIFIED AS "TO REMAIN" FROM DAMAGE BY EQUIPMENT AND CONSTRUCTION ACTIVITIES.

TREE PLANTING NOTES:

- 1. WHERE SEVERAL TREES WILL BE PLANTED CLOSE TOGETHER SUCH THAT THEY WILL LIKELY SHARE ROOT SPACE, TILL IN SOIL AMENDMENTS TO A DEPTH OF 4-6" OVER THE ENTIRE AREA.
- FOR CONTAINER GROWN TREES, USE FINGERS OR SMALL HAND TOOLS TO PULL THE ROOTS OUT OF THE OUTER LAYER OF POTTING SOIL; THEN CUT OR PULL APART ANY ROOTS CIRCLING THE PERIMETER OF THE CONTAINER.
- 3. DURING THE DESIGN PHASE, CONFIRM THAT THE WATER DRAINS OUT OF THE SOIL; USE TOWERED PLANTING HOLE DEPTH AND DESIGN ALTERNATIVE DRAINAGE SYSTEM AS REQUIRED.
- 4. THOROUGHLY SOAK THE TREE ROOT BALL AND ADJACENT PREPARED SOIL SEVERAL TIMES DURING FIRST MONTH AFTER PLANTING AND REGULARLY THROUGHOUT THE FOLLOWING TWO SUMMERS UNTIL ESTABLISHED.
- BEFORE PLANTING, ADD 3-4" OF WELL COMPOSTED LEAVES, RECYCLED YARD WASTE OR OTHER COMPOST AND TILL INTO 6" OF PREPARED SOIL. ADD COMPOST AT 20-35% BY VOLUME TO BACKFILL.
- DO NOT WRAP TRUNK; MARK THE NORTH SIDE OF THE TREE IN THE NURSERY AND LOCATE TO THE NORTH SIDE IN THE FIELD.
- AVOID PURCHASING TREES WITH TWO LEADERS OR REMOVE ONE AT PLANTING. OTHERWISE, DO NOT PRUNE TREE AT PLANTING EXCEPT FOR SPECIFIC STRUCTURAL CORRECTIONS.

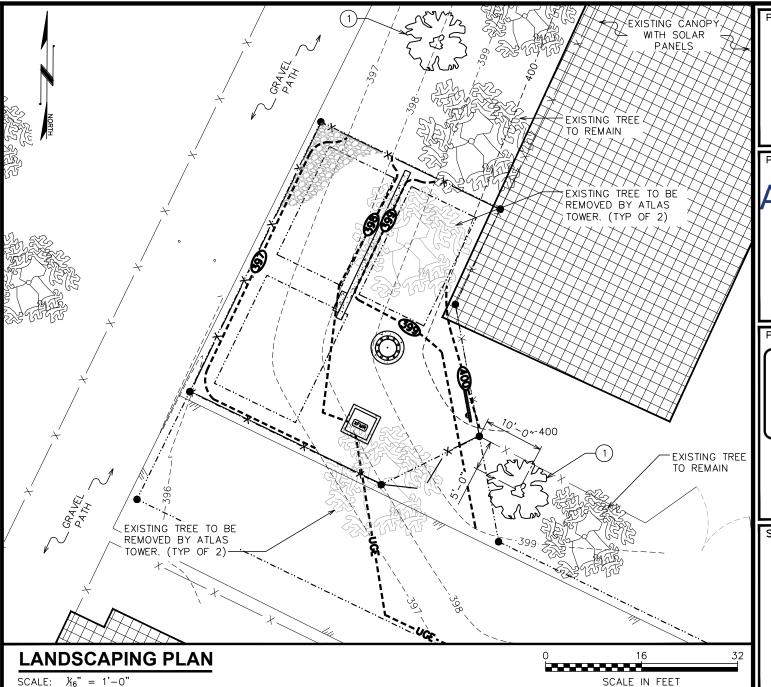

PROJECT INFORMATION:

SANTEE

10400-CS FANITA PARKWAY SANTEE, CA 92071 (SAN DIEGO COUNTY)

PLANS PREPARED FOR:




2500 30TH ST., SUITE 304 BOULDER, CO 80301 Office: (303) 448-8896

PLANS PREPARED BY:



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4	08-02-24	PRELIMINARY
3	06-20-24	PRELIMINARY
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0	04-08-24	PRELIMINARY
REV	DATE	ISSUED FOR:

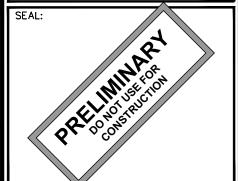DRAWN BY: KES CHECKED BY: ARB

SHEET TITLE:

LANDSCAPING PLAN

SHEET NUMBER:

REVISION:

	PLANTING SCHEDULE						
ITEM	QTY.	BOTANICAL NAME	COMMON NAME	HEIGHT REQ.	SPREAD/ CALIPER	SPACING	REMARKS
TRE	ES						
1	2	QUERCUS BERBERIDIFOLIA	SCRUB OAK	6'-0" (MIN)	15' (MAX)	8'-0"	SHOWN AS TREE
MULCH							
2.)	160 ± SQ FT	-	MULCH	_	_	_	APPLY 3"-4" DEEP FROM THE TRUNKLINE TO THE DRIPLINE IN 5' RINGS AROUND THE TREES. FOR GROUND COVER APPLY 1"-2" DEEP.

SCOPE:

PROVIDE LABOR, MATERIALS, INSPECTION, AND TESTING TO PROVIDE CODE COMPLIANCE FOR ELECTRIC, TELEPHONE, AND GROUNDING/LIGHTNING SYSTEMS.

- THE INSTALLATION SHALL COMPLY WITH APPLICABLE LAWS AND CODES. THESE INCLUDE BUT ARE NOT LIMITED TO THE LATEST ADOPTED EDITIONS OF:
 - A. THE NATIONAL ELECTRICAL SAFETY CODE
- D. LOCAL AND STATE AMENDMENTS
- B. THE NATIONAL ELECTRIC CODE NFPA-70
- E. THE INTERNATIONAL ELECTRIC CODE IEC (WHERE APPLICABLE)
- C. REGULATIONS OF THE SERVING UTILITY COMPANY
- 2. PERMITS REQUIRED SHALL BE OBTAINED BY THE CONTRACTOR.
- 3. AFTER COMPLETION AND FINAL INSPECTION OF THE WORK, THE OWNER SHALL BE FURNISHED A CERTIFICATE OF COMPLETION AND APPROVAL

TESTING:

UPON COMPLETION OF THE INSTALLATION, OPERATE AND ADJUST THE EQUIPMENT AND SYSTEMS TO MEET SPECIFIED PERFORMANCE REQUIREMENTS. THE TESTING SHALL BE DONE BY QUALIFIED PERSONNEL.

GUARANTEE:

- IN ADDITION TO THE GUARANTEE OF THE EQUIPMENT BY THE MANUFACTURER, EACH PIECE OF EQUIPMENT SPECIFIED HEREIN SHALL ALSO BE GUARANTEED FOR DEFECTS OF MATERIAL OR WORKMANSHIP OCCURRING DURING A PERIOD OF ONE (1) YEAR FROM FINAL ACCEPTANCE OF THE WORK BY THE OWNER AND WITHOUT EXPENSE TO THE OWNER
- 2. THE WARRANTEE CERTIFICATES & GUARANTEES FURNISHED BY THE MANUFACTURERS SHALL BE TURNED OVER TO THE OWNER.

UTILITY CO-ORDINATION:

CONTRACTOR SHALL COORDINATE WORK WITH THE POWER AND TELEPHONE COMPANIES AND SHALL COMPLY WITH THE SERVICE REQUIREMENTS OF EACH UTILITY COMPANY.

EXAMINATION OF SITE:

PRIOR TO BEGINNING WORK, THE CONTRACTOR SHALL VISIT THE SITE OF THE JOB AND SHALL FAMILIARIZE HIMSELF WITH THE CONDITIONS AFFECTING THE PROPOSED ELECTRICAL INSTALLATION AND SHALL MAKE PROVISIONS AS TO THE COST THEREOF. FAILURE TO COMPLY WITH THE INTENT OF THIS SECTION WILL IN NO WAY RELIEVE THE CONTRACTOR OF PERFORMING THE WORK NECESSARY FOR A COMPLETE AND WORKING SYSTEM OR SYSTEMS.

CUTTING, PATCHING AND EXCAVATION:

- COORDINATION OF SLEEVES, CHASES, ETC., BETWEEN SUBCONTRACTORS WILL BE REQUIRED PRIOR TO THE CONSTRUCTION OF ANY PORTION OF THE WORK. CUTTING AND PATCHING OF WALLS, PARTITIONS, FLOORS, AND CHASES IN CONCRETE, WOOD, STEEL OR MASONRY SHALL BE DONE AS PROVIDED ON THE DRAWINGS.
- NECESSARY EXCAVATIONS AND BACKFILLING INCIDENTAL TO THE ELECTRICAL WORK SHALL BE PROVIDED BY THE ELECTRICAL CONTRACTOR UNLESS SPECIFICALLY NOTED OTHERWISE ON THE DRAWING.
- 3. SEAL PENETRATIONS THROUGH RATED WALLS, FLOORS, ETC., WITH APPROVED METHOD AS LISTED BY UL.

RACEWAYS / CONDUITS GENERAL:

- CONDUCTORS SHALL BE INSTALLED IN LISTED RACEWAYS. CONDUIT SHALL BE RIGID STEEL, EMT, SCH40 PVC, OR SCH80PVC AS INDICATED ON THE DRAWINGS. THE RACEWAY SYSTEM SHALL BE COMPLETE COMPLETE BEFORE INSTALLING CONDUCTORS
- 2. EXTERIOR RACEWAYS AND GROUNDING SLEEVES SHALL BE SEALED AT POINTS OF ENTRANCE AND EXIT. THE RACEWAY SYSTEM SHALL BE BONDED PER NEC.

EXTERIOR CONDUIT:

- EXPOSED CONDUIT SHALL BE NEATLY INSTALLED AND RUN PARALLEL OR PERPENDICULAR TO STRUCTURAL ELEMENTS. SUPPORTS AND MOUNTING HARDWARE SHALL BE HOT DIPPED GALVANIZED STEEL
- 2. THE CONDUIT SHALL BE RIGID STEEL AT GRADE TRANSITIONS OR WHERE EXPOSED TO DAMAGE.
- 3. UNDERGROUND CONDUITS SHALL BE RIGID STEEL, SCH40 PVC, OR SCH80 PVC AS INDICATED ON THE DRAWINGS.
- 4. BURIAL DEPTH OF CONDUITS SHALL BE AS REQUIRED BY CODE FOR EACH SPECIFIC CONDUIT TYPE AND APPLICATION, BUT SHALL NOT BE LESS THAN THE FROST DEPTH AT THE SITE.
- 5. CONDUIT ROUTES ARE SCHEMATIC. CONTRACTOR SHALL FIELD VERIFY ROUTES BEFORE BID. COORDINATE ROUTE WITH WIRELESS CARRIER AND/OR BUILDING OWNER.

INTERIOR CONDUIT:

- 1. CONCEALED CONDUIT IN WALLS OR INTERIOR SPACES ABOVE GRADE MAY BE EMT OR PVC.
- CONDUIT RUNS SHALL USE APPROVED COUPLINGS AND CONNECTORS. PROVIDE INSULATED BUSHING FOR ALL CONDUIT TERMINATIONS. CONDUIT RUNS IN A WET LOCATION SHALL HAVE WATERPROOF FITTINGS.
- 3. PROVIDE SUPPORTS FOR CONDUITS IN ACCORDANCE WITH NEC REQUIREMENTS. CONDUITS SHALL BE SIZED AS REQUIRED BY NEC.

EQUIPMENT:

- 1. DISCONNECT SWITCHES SHALL BE SERVICE ENTRANCE RATED, HEAVY DUTY TYPE.
- 2. CONTRACTOR SHALL VERIFY MAXIMUM AVAILABLE FAULT CURRENT AND COORDINATE INSTALLATION WITH THE LOCAL UTILITY BEFORE STARTING WORK. CONTRACTOR WILL VERIFY THAT EXISTING CIRCUIT BREAKERS ARE RATED FOR MORE THAN AVAILABLE FAULT CURRENT AND REPLACE AS NECESSARY.
- 3. NEW CIRCUIT BREAKERS SHALL BE RATED TO WITHSTAND THE MAXIMUM AVAILABLE FAULT CURRENT AS DETERMINED BY THE LOCAL UTILITY.

CONDUCTORS:

- FURNISH AND INSTALL CONDUCTORS SPECIFIED IN THE DRAWINGS. CONDUCTORS SHALL BE COPPER AND SHALL HAVE TYPE THWN (MIN) (75° C) INSULATION, RATED FOR 600 VOLTS.
- 2. THE USE OF ALUMINUM CONDUCTORS SHALL BE LIMITED TO THE SERVICE FEEDERS INSTALLED BY THE UTILITY.
- 3. CONDUCTORS SHALL BE PROVIDED AND INSTALLED AS FOLLOWS:
 - A. MINIMUM WIRE SIZE SHALL BE #12 AWG.
 - CONDUCTORS SIZE #8 AND LARGER SHALL BE STRANDED. CONDUCTORS SIZED #10 AND #12 MAY BE SOLID OR STRANDED.
 - CONNECTION FOR #10 AWG #12 AWG SHALL BE BY TWISTING TIGHT AND INSTALLING INSULATED PRESSURE OR WIRE NUT CONNECTIONS.
 - CONNECTION FOR #8 AWG AND LARGER SHALL BE BY USE OF STEEL CRIMP-ON SLEEVES WITH NYLON INSULATOR.
- 3. CONDUCTORS SHALL BE COLOR CODED IN ACCORDANCE WITH NEC STANDARDS.

UL COMPLIANCE:

1. ELECTRICAL MATERIALS, DEVICES, CONDUCTORS, APPLIANCES, AND EQUIPMENT SHALL BE LABELED/LISTED BY UL OR ACCEPTED BY JURISDICTION (I.E., LOCAL COUNTY OR STATE) APPROVED THIRD PARTY TESTING AGENCY.

GROUNDING:

- 1. ELECTRICAL NEUTRALS, RACEWAYS AND NON-CURRENT CARRYING PARTS OF ELECTRICAL EQUIPMENT AND ASSOCIATED ENCLOSURES SHALL BE GROUNDED IN ACCORDANCE WITH NEC ARTICLE 250. THIS SHALL INCLUDE NEUTRAL CONDUCTORS, CONDUITS, SUPPORTS, CABINETS, BOXES, GROUND BUSSES, ETC. THE NEUTRAL CONDUCTOR FOR EACH SYSTEM SHALL BE GROUNDED AT A SINGLE POINT.
- 2. PROVIDE GROUND CONDUCTOR IN RACEWAYS PER NEC.
- 3. PROVIDE BONDING AND GROUND TO MEET NFPA 780 "LIGHTNING PROTECTION" AS A MINIMUM.
- 4. PROVIDE GROUNDING SYSTEM AS INDICATED ON THE DRAWINGS, AS REQUIRED BY THE NATIONAL ELECTRIC CODE, RADIO EQUIPMENT MANUFACTURERS, AND MOTOROLA R56 (AS APPLICABLE).

ABBREVIATIONS AND LEGEND

PNLBD - PANELBOARD AMPERE ABOVE FINISHED GRADE RIGID GALVANIZED STEEL CONDUIT - AUTOMATIC TRANSFER SWITCH RGS

ATS AMERICAN WIRE GAUGE AWG

BCW BARE COPPER WIRE BFG BELOW FINISHED GRADE

BKR BRFAKFR

 CONDUIT CKT CIRCUIT DISCONNECT

EXTERNAL GROUND RING

 ELECTRIC METALLIC TUBING FSC - FLEXIBLE STEEL CONDUIT

GENERATOR

GEN GPS GLOBAL POSITIONING SYSTEM

GRD GROUND IGB

 ISOLATED GROUND BAR **IGR** INTERIOR GROUND RING (HALO)

KILOWATTS

NATIONAL ELECTRIC CODE

- PERSONAL COMMUNICATION SYSTEM

PHASE PANFI

ΚW

- RIGID NON-METALLIC CONDUIT

SW SWITCH

TGB TOWER GROUND BAR

UL UNDERWRITERS LABORATORIES V VOLTAGE

W WATTS XFMR TRANSFORMER

XMTR - TRANSMITTER

— UNDERGROUND ELECTRICAL CONDUIT UNDERGROUND TELEPHONE CONDUIT KILOWATT-HOUR METER

UNDERGROUND BONDING AND GROUNDING CONDUCTOR.

Ø GROUND ROD

CADWELD

 \boxtimes GROUND ROD WITH INSPECTION WELL PROJECT INFORMATION:

SANTEE

10400-CS FANITA PARKWAY SANTEE, CA 92071 (SAN DIEGO COUNTY)

PLANS PREPARED FOR:




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REV	DATE	ISSUED FOR:
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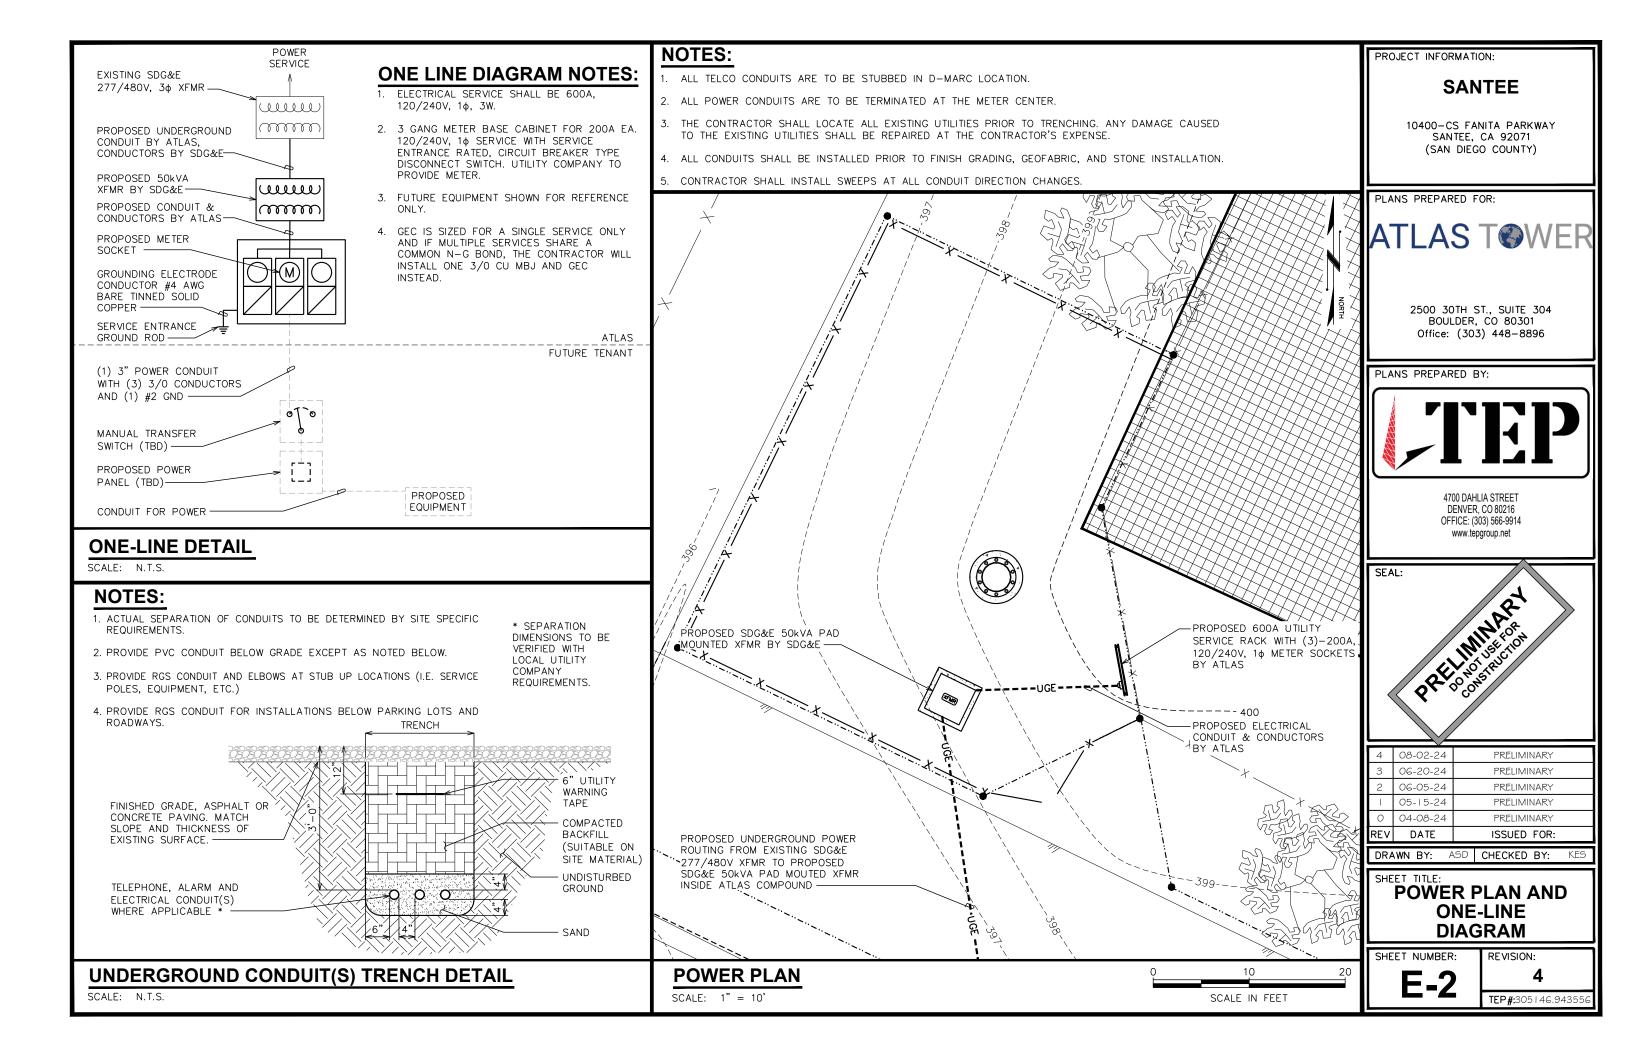
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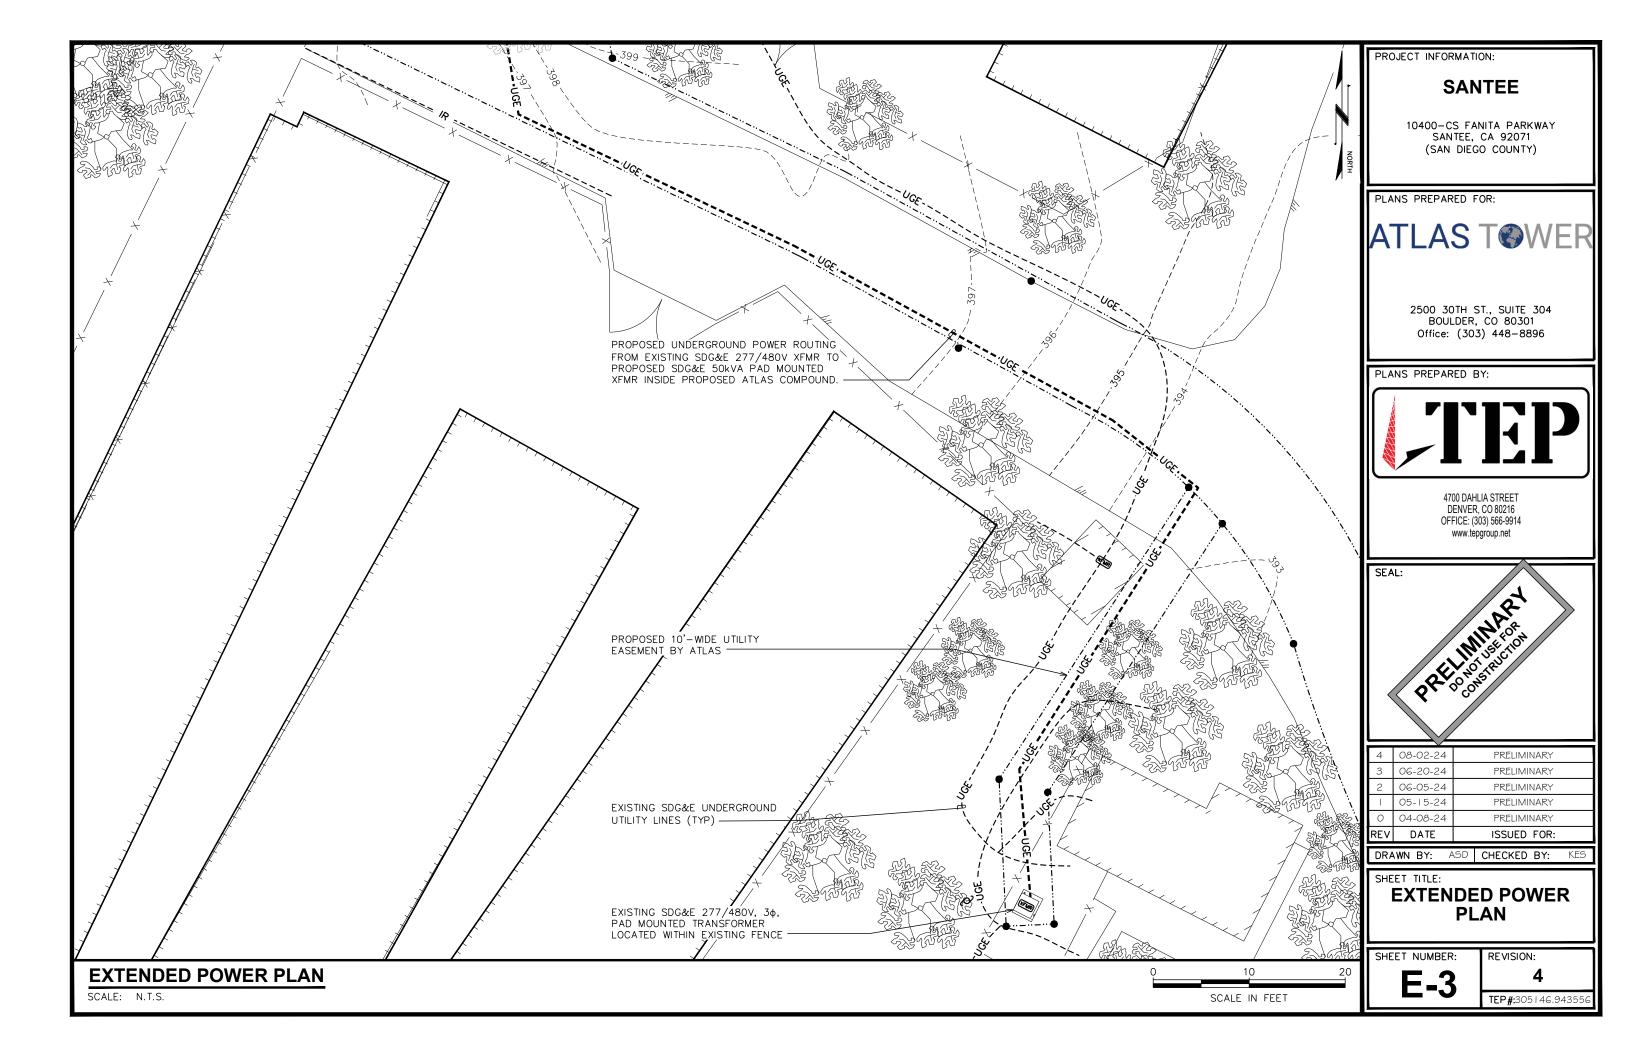
ELECTRICAL NOTES

SHEET NUMBER:

TEP#:305146.9435

REVISION:

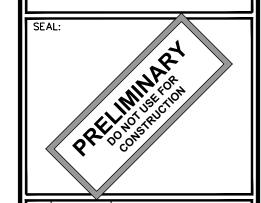




NOTES:

- $oxed{1}$ refer to the site layout plan for the exact location of the H-frame.
- (2) CONTRACTOR TO COORDINATE WITH LOCAL UTILITY COMPANY FOR METER.
- (3) UTILITY COMPANY TO PROVIDE AND INSTALL METER SOCKET.
- (4) CONTRACTOR TO ENSURE METER RACK WORKING SPACES REQUIRED BY THE NEC (ART. 110.26), STATE, OR LOCAL CODES ARE MAINTAINED BOTH ON THE FRONT SIDE AND THE BACK SIDE OF THE H-FRAME PRIOR TO INSTALLATION.
- (5) SHOW LOCATION (INCLUDING DIMENSIONS) OF ALL CAPPED UNDERGROUND CONDUIT ON FINAL AS-BUILT DRAWINGS SUBMITTED TO OWNER.

- (6) COORDINATE EXACT LOCATION OF UNDERGROUND FEEDERS AND CIRCUITRY WITH THE
- (7) CONTRACTOR SHALL COORDINATE EFFORTS WITH (LOCAL, ELECTRICAL) AUTHORITY HAVING JURISDICTION (AHJ) AND OTHER TRADES TO DETERMINE "FROST" LINE, AND TYPE(S) OF RACEWAYS REQUIRED FOR INSTALLATION.
- (8) BOND ALL ELECTRICAL EQUIPMENT TO RACK.
- (9) DIMENSIONS SHOWN ARE APPROXIMATE AND MAY BE ALTERED IN THE FIELD AS APPROVED BY OWNER TO BETTER SUIT ACTUAL CONDITIONS OR EQUIPMENT RECEIVED.

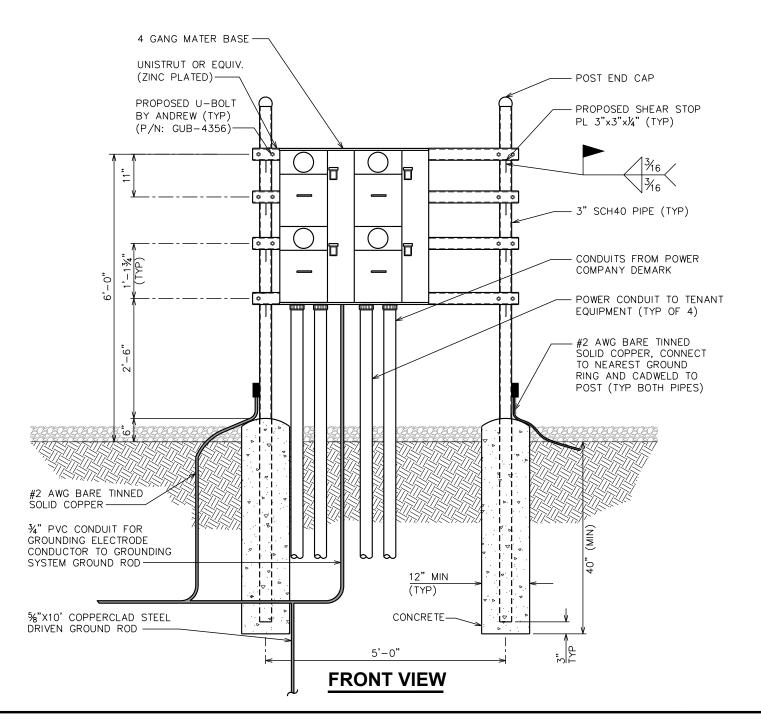

PROJECT INFORMATION:

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10400-CS FANITA PARKWAY SANTEE, CA 92071 (SAN DIEGO COUNTY)

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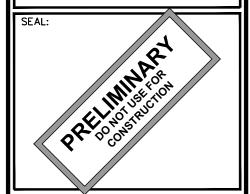


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REV	DATE	ISSUED FOR:

ASD CHECKED BY: DRAWN BY:

SHEET TITLE:

SERVICE RACK DETAILS

SHEET NUMBER:

REVISION:

TEP#:305146.9435

SERVICE RACK DETAILS

SCALE: $\frac{1}{2}$ " = 1'-0"

SCALE IN FEET

DRAWING NOTES:

- 1) %"x10' COPPER GROUND ROD (TYP).
- 2) GATE POST BONDING. SEE DETAIL ON THIS SHEET.
- 3 FENCE GATE GROUNDING. SEE DETAIL ON THIS SHEET.

GROUNDING NOTES

- 1. GROUNDING ELECTRODES SHALL BE CONNECTED IN A RING USING #2 SOLID CONDUCTOR. THE TOP OF THE GROUND RODS AND THE CONDUCTOR SHALL BE 30" (MIN) BELOW FINISHED GRADE. GROUNDING ELECTRODES SHALL BE DRIVEN ON 10'-0" CENTERS. (6'-0" MINIMUM; 16'-0" MAXIMUM)
- 2. BONDING OF THE GROUNDED CONDUCTOR (NEUTRAL) AND THE GROUNDING CONDUCTOR SHALL BE AT THE SERVICE DISCONNECTING MEANS. BONDING JUMPER SHALL BE INSTALLED PER N.E.C. ARTICLE 250.30.
- 3. ROUND SHELTER TO GROUND RING PER NSTD46 CELL SITE GROUNDING AND LIGHTING PROTECTION, ISSUED 2/1/11.

PROJECT INFORMATION:

SANTEE

10400-CS FANITA PARKWAY SANTEE, CA 92071 (SAN DIEGO COUNTY)

PLANS PREPARED FOR:




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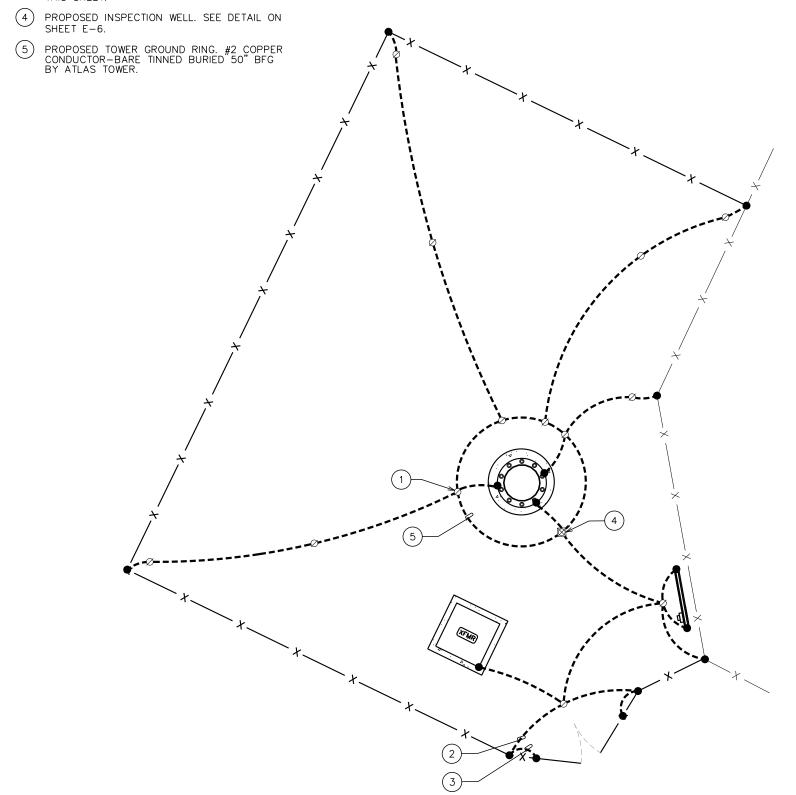
SHEET TITLE:

GROUNDING PLAN AND DETAILS

SHEET NUMBER:

REVISION:

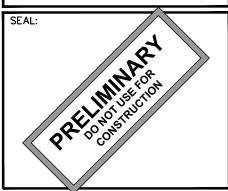TEP#:305146.943556



ANY STRUCTURE.

6"
(MIN)

MIN. 30" DEEP TRENCH
OR TO ROCK OR TO 6"
BELOW FROST LINE,
WHICHEVER IS DEEPER.

GROUND ROD.

TRENCH DETAIL

SCALE: N.T.S.

EXOTHERMIC CADWELD CONNECTION (TYP).


FLEXIBLE JUMPER.


TYPICAL GROUNDING PLAN


SCALE: N.T.S

GROUNDING AT GATE POST

SCALE: N.T.S.

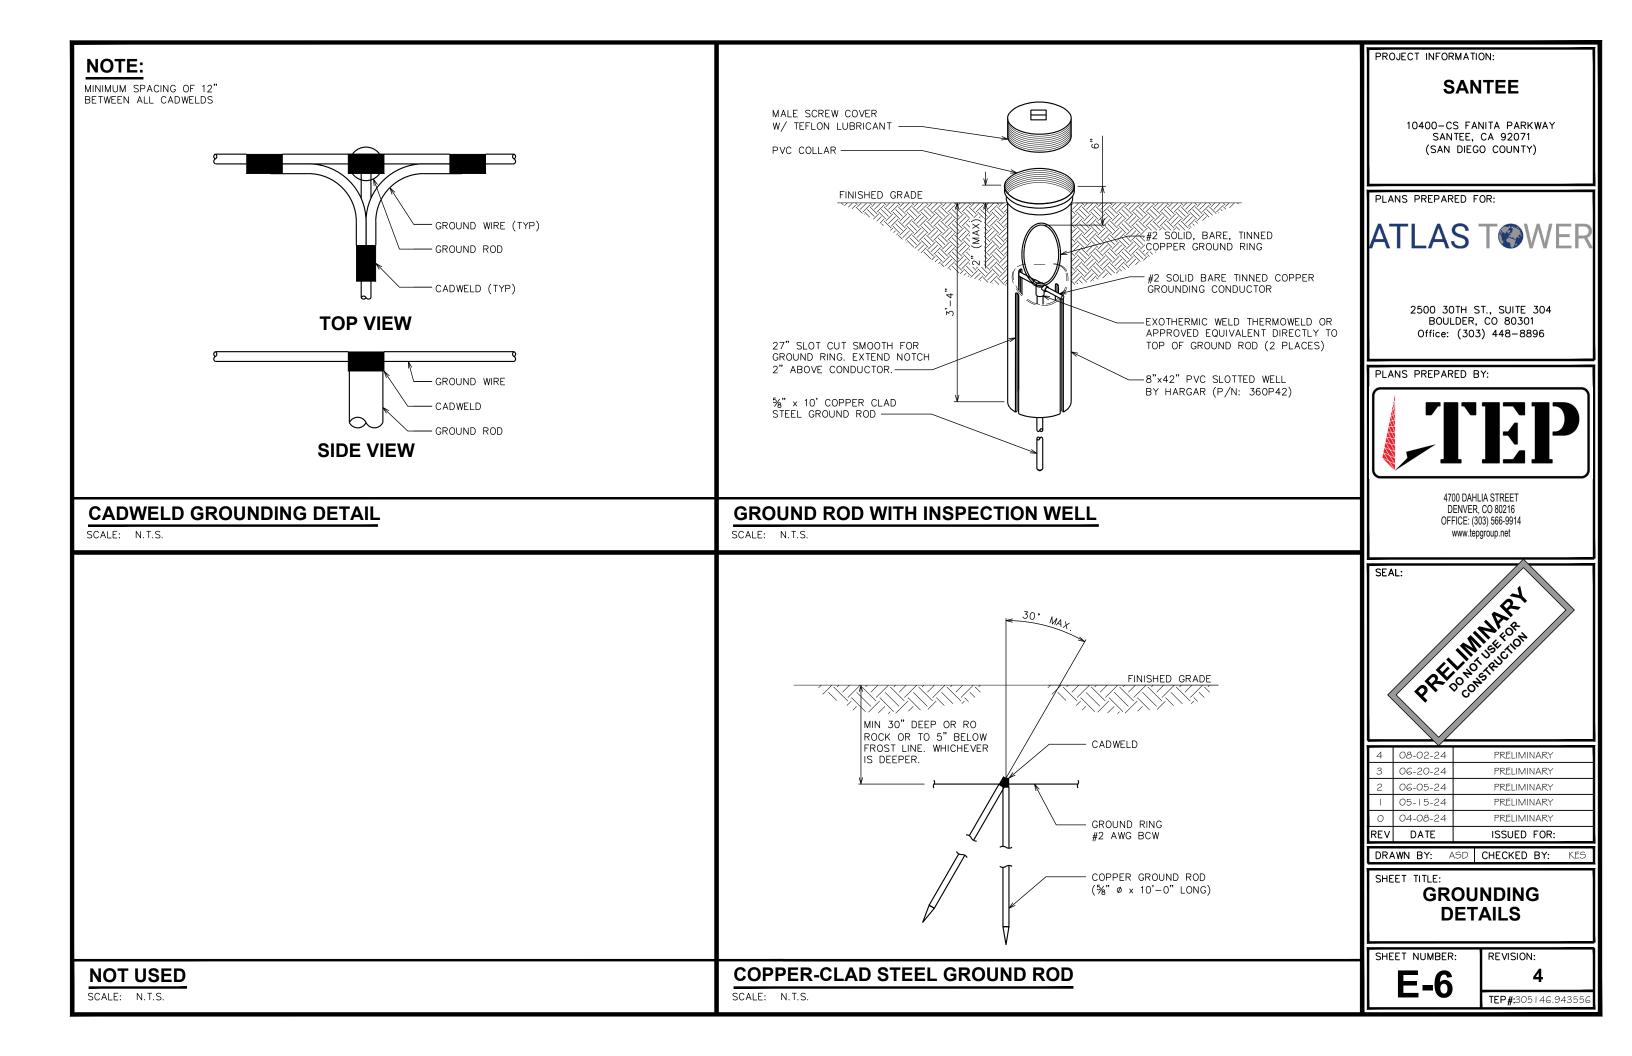

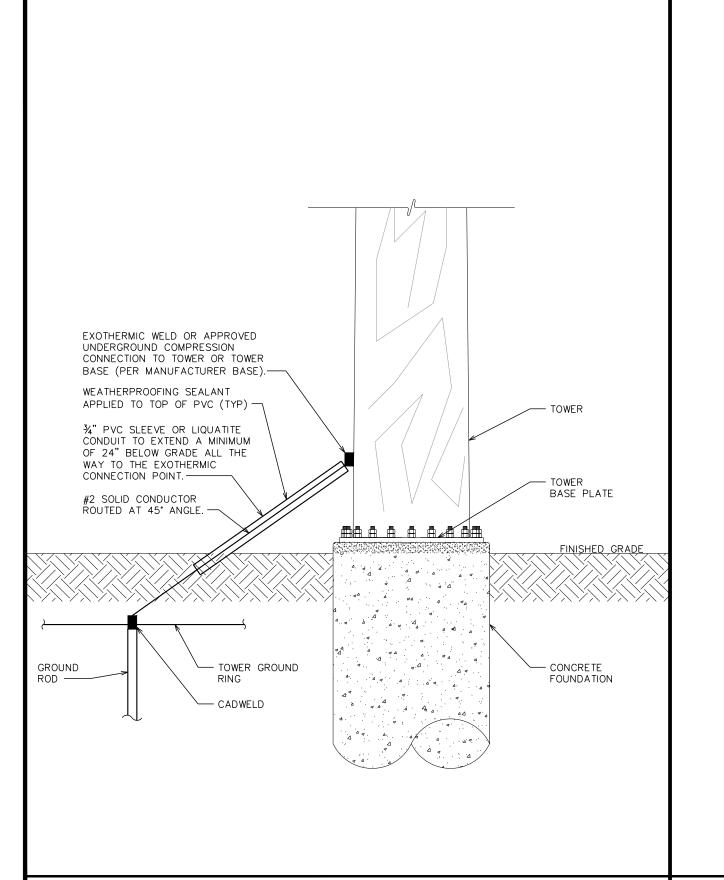

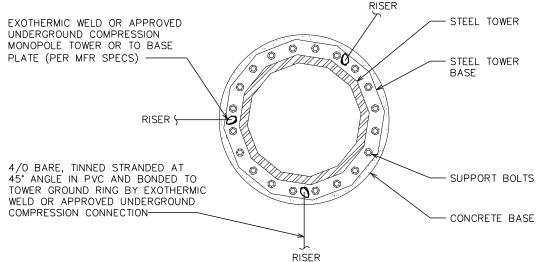

PROJECT INFORMATION:

SANTEE

10400-CS FANITA PARKWAY SANTEE, CA 92071 (SAN DIEGO COUNTY)

PLANS PREPARED FOR:


ATLAS TOWER

2500 30TH ST., SUITE 304 BOULDER, CO 80301 Office: (303) 448-8896

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3 06-20-24 PRELIMINARY	-1	05-15-24	PRELIMINARY
	2	06-05-24	PRELIMINARY
4 08-02-24 PRELIMINARY	3	06-20-24	PRELIMINARY
	4	08-02-24	PRELIMINARY

DRAWN BY: ASD CHECKED BY: KES

SHEET TITLE:

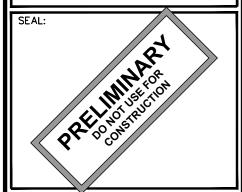TOWER FOUNDATION GROUNDING DETAILS

SHEET NUMBER:

E-7

REVISION:

TEP#:305146.9435

TOWER BASE GROUNDING DETAIL
SCALE: N.T.S.

SCALE: N.T.S.

TOWER GROUNDING