GENERAL NOTES

- AN ENCROACHMENT PERMIT SHALL BE OBTAINED FROM THE DEPARTMENT OF DEVELOPMENT SERVICES PRIOR TO THE START OF ANY CONSTRUCTION WITHIN THE LIMITS OF THE PUBLIC RIGHT-OF-WAY INCLUDING BUT NOT LIMITED TO UTILITY CONNECTIONS OR GRADING.
- ACCEPTANCE OF THESE IMPROVEMENTS AS SHOWN DOES NOT CONSTITUTE APPROVAL OF ANY CONSTRUCTION OUTSIDE THE PROJECT BOUNDARY.
- 3. ALL UNDERGROUND UTILITIES WITHIN THE STREET RIGHT-OF-WAY SHALL BE CONSTRUCTED, TESTED AND CONNECTED PRIOR TO CONSTRUCTION OF BERMS, CURBS, CROSS-GUTTERS, SIDEWALKS, RETAINING WALLS OR FINAL PAVING.
- 4. THE EXISTENCE AND LOCATION OF EXISTING UNDERGROUND FACILITIES SHOWN ON THESE PLANS WERE OBTAINED BY A SEARCH OF AVAILABLE RECORD DATA AND FIELD SURVEYS. TO THE BEST OF OUR KNOWLEDGE, EXISTING FACILITIES ARE SHOWN ON THESE PLANS. THE CONTRACTOR IS REQUIRED TO TAKE PRECAUTIONARY MEASURES TO PROTECT ANY EXISTING FACILITIES SHOWN HEREON AND TO MAKE A REASONABLE AND DILIGENT SEARCH TO DETERMINE ANY OTHER WHICH ARE NOT OF RECORD OR NOT SHOWN ON THESE PLANS AND TO PROTECT THE SAME. ANY FACILITIES SO LOCATED SHALL BE BROUGHT TO THE ATTENTION OF THE ENGINEER AND INCLUDED ON THE AS-BUILT DRAWINGS FOR THIS PROJECT.
- LOCATION AND ELEVATION OF IMPROVEMENTS TO BE MET BY WORK TO BE DONE SHALL BE CONFIRMED BY FIELD MEASUREMENTS PRIOR TO CONSTRUCTION OF NEW WORK. CONTRACTOR SHALL BE RESPONSIBLE FOR MAKING EXPLORATORY EXCAVATIONS AND LOCATING EXISTING UNDERGROUND FACILITIES SUFFICIENTLY AHEAD OF CONSTRUCTION TO ALLOW FOR REVISIONS TO PLANS IF REVISIONS ARE NECESSARY BECAUSE OF CHANGES IN LINE OR GRADE DUE TO THE ACTUAL LOCATION OF THE FXISTING FACILITIES.
- 6. THE CONTRACTOR SHALL NOTIFY SDG&E PRIOR TO STARTING WORK NEAR SDG&E FACILITIES AND SHALL COORDINATE THEIR WORK WITH COMPANY REPRESENTATIVES.
- FOR LOCATION OF ELECTRICAL CABLES AND GAS PIPING AND APPURTENANCES CONTACT THE SAN DIEGO GAS AND ELECTRIC COMPANY. TELEPHONE: DIAL 811
- THE CONTRACTOR SHALL NOTIFY THE AT&T TELEPHONE COMPANY PRIOR TO STARTING WORK NEAR AT&T FACILITIES AND SHALL COORDINATE THEIR WORK WITH
- NOTICE: FOR LOCATION OF CABLES AND APPURTENANCES CONTACT AT&T. TELEPHONE: DIAL 811
- 8. THE CONTRACTOR SHALL NOTIFY PADRE DAM MUNICIPAL WATER DISTRICT 48 HRS. PRIOR TO STARTING WORK NEAR PADRE DAM MUNICIPAL WATER DISTRICT FACILITIES AND SHALL COORDINATE THEIR WORK WITH DISTRICT REPRESENTATIVES.
- NOTICE: FOR LOCATION OF WATER AND SEWER FACILITIES AND APPURTENANCES CONTACT PADRE DAM MUNICIPAL WATER DISTRICT. TELEPHONE: DIAL 811
- 9. THE CONTRACTOR SHALL NOTIFY COX CABLE TV PRIOR TO STARTING WORK NEAR COX CABLE FACILITIES AND SHALL COORDINATE THEIR WORK WITH COMPANY REPRESENTATIVES.
- NOTICE: FOR LOCATION OF CABLES AND APPURTENANCES CONTACT COX CABLE. TELEPHONE: DIAL 811
- 10. IT SHALL BE THE RESPONSIBILITY OF THE CONTRACTOR TO CONTACT THE UTILITY AGENCIES, ADVISE THEM OF THE PROPOSED IMPROVEMENTS, AND COORDINATE RELOCATIONS, IF NEEDED.
- 11. POWER SOURCES AND RUNS SERVING STREET LIGHTS SHALL BE SHOWN ON THE "AS-BUILT" IMPROVEMENT DRAWINGS. ALL SOURCES SHALL BE LOCATED WITHIN THE DEDICATED RIGHT-OF-WAY, OR WITHIN EASEMENTS DEDICATED TO THE CITY OF SANTEE.
- 12. CITY OF SANTEE INSPECTION REQUIREMENTS:
 - A. CONTRACTOR SHALL INFORM THE CITY PROJECT ENGINEER 48 HRS. IN ADVANCE OF COMMENCING WORK. PHONE (619) 258-4100 EXT 168.
- B. THE CONTRACTOR SHALL GIVE A MINIMUM OF 24 HRS. NOTICE ON REQUESTS FOR INSPECTION.
- C. ANY WORK PERFORMED WITHOUT THE BENEFIT OF INSPECTION IS SUBJECT TO REMOVAL AND REPLACEMENT AT THE CONTRACTOR'S EXPENSE.
- 13. THE CONTRACTOR SHALL RELOCATE STREET SIGNS WHEN CONDITIONS SO DICTATE. CONTRACTOR SHALL PROTECT AND ASSUME RESPONSIBILITY FOR ALL OTHER TRAFFIC CONTROL DEVICES. CONTRACTOR SHALL REPLACE TRAFFIC STRIPING, STREET MARKINGS, AND CURB MARKINGS REMOVED OR DAMAGED BY HIS WORK.
- 14. SIDEWALK JOINT LOCATIONS SHALL BE INSTALLED IN ACCORDANCE WITH REGIONAL STANDARD DRAWING NO. G-9. CURB OR CURB AND GUTTER JOINT LOCATIONS SHALL INCLUDE EXPANSION JOINTS AT CURB RETURNS, ADJACENT TO WALLS AND STRUCTURES AND AT 45' INTERVALS. WEAKENED PLANE JOINTS SHALL BE PLACED EVERY 15' AND GROOVED JOINTS PLACED EVERY 5". ALL CONCRETE JOINTS SHALL CONFORM TO REGIONAL STANDARD DRAWING NO. G-10. SIDEWALKS SHALL BE REMOVED TO THE
- 15. SIDEWALKS AND BIKE PATHS ARE DESIGNED TO HAVE CLEAR UNOBSTRUCTED ACCESS. THESE FACILITIES SHALL BE KEPT CLEAR OF STREET LIGHTS, FIRE HYDRANTS, METER BOXES, TRANSFORMERS, ELECTRICAL PULL BOXES, BLOWOFFS, AIR VENTS OR OTHER SIMILAR OBSTRUCTIONS AT ALL TIMES AND SHALL MAINTAIN 4' MINIMUM CLEARANCE.
- 16. THE CONTRACTOR IS RESPONSIBLE FOR ENSURING ADEQUACY OF DESIGN AND CONSTRUCTION IN ACCORDANCE WITH THE SPECIFIED GENERAL STANDARDS OF CONSTRUCTION LISTED HEREON, AND TO PROTECT THE WORK AT ALL TIMES DURING THE COURSE OF CONSTRUCTION. FAILED OR DAMAGED WORK SUCH AS CRACKED SIDEWALKS, CURB AND GUTTER, CROSS GUTTERS, DRIVEWAY APRONS AND SO FORTH, SHALL BE REPLACED TO THE NEAREST JOINT OR SCORE LINE IN EACH DIRECTION PRIOR TO PLACEMENT OF THE FINAL PAVEMENT COURSE.
- 17. THE CONTRACTOR SHALL ENFORCE SAFETY MEASURES AND REGULATIONS INCLUDING THE DESIGN, CONSTRUCTION AND MAINTENANCE FOR CONFORMING TO ALL LOCAL, STATE, AND FEDERAL SAFETY AND HEALTH STANDARDS, LAWS AND REGULATIONS.
- 18. THE CONTRACTOR SHALL BE RESPONSIBLE FOR THE REMOVAL, DISPOSAL, AND COORDINATION OF ALL PRIVATE FACILITIES, FENCES, WALLS, DEBRIS, LANDSCAPING AND IRRIGATION WITHIN THE RIGHT OF WAY WHICH REQUIRES REMOVAL FOR CONSTRUCTION PURPOSES. EACH INDIVIDUAL OWNER EFFECTED SHALL BE NOTIFIED 5 DAYS IN ADVANCE PRIOR TO DEMOLITION OR REMOVAL OF PRIVATE PROPERTY WITHIN THE RIGHT OF WAY.
- 19. SOME UTILITIES MAY BE RELOCATED BY THE UTILITY COMPANIES PRIOR TO CONSTRUCTION. THE CONTRACTOR SHALL VERIFY THAT ALL UTILITIES ARE RELOCATED PRIOR TO START OF WORK BY CONTACTING THE CITY.
- 20. CONTRACTOR SHALL POSSESS A CLASS "A" LICENSE AT THE TIME OF BID SUBMISSION.
- 21. CONTRACTOR TO LOCATE AND ADJUST SURVEY MONUMENTS TO GRADE AND COORDINATE WITH LOCAL AGENCIES.

REFERENCES

22. MTS GENERAL NOTES SEE SHEET 2.

LIST OF CALTRANS STANDARD PLANS:

RSP A20D	PAVEMENT MARKERS AND TRAFFIC LINES - TYPICAL DETAILS
A24A	PAVEMENT MARKINGS - ARROWS
A24C	PAVEMENT MARKINGS - SYMBOLS AND NUMERALS
A24D	PAVEMENT MARKINGS - WORDS
RSP A24E	PAVEMENT MARKINGS - WORDS, LIMIT AND YIELD LINES
RSP ES-1A	ELECTRICAL SYSTEMS (LEGEND)
RSP ES-1B	ELECTRICAL SYSTEMS (LEGEND)
RSP ES-1C	ELECTRICAL SYSTEMS (LEGEND)
RSP ES-8A	ELECTRICAL SYSTEMS (NON-TRAFFIC PULL BOX)
ES-11	ELECTRICAL SYSTEMS (FOUNDATION INSTALLATIONS)
ES-13A	ELECTRICAL SYSTEMS (SPLICE INSULATION METHODS DETAILS)
ES-7H (2002)	SIGNAL AND LIGHTING STANDARDS CASE 5 ARM LOADING

WIND VELOCITY = 129 KM/H (80MPH) ARM LENGTHS 18.2M-19.8M (60'-65')

LIST OF WATER AGENCY STANDARDS

50MM (2") BLOWOFF INSTALLATION

CONSTRUCTION RECORD

CONTRACTOR

ATE COMPLETED

NSPECTOR



LIST OF SAN DIEGO REGIONAL STANDARD DRAWINGS:

LIST OF SA	N DIEGO REGIONAL STANDARD DRAWINGS.
G-2	CURB AND GUTTER - COMBINED
G-7	SIDEWALK - TYPICAL SECTIONS
G-9	SIDEWALK JOINT LOCATIONS
G-10	CONCRETE JOINT DETAILS
G-14G	ASPHALT CONCRETE DRIVEWAY
G-27	CURB RAMP - TYPES A AND B (NEW CONSTRUCTION)
G-30	TRUNCATED DOMES
G-32A	GENERAL NOTES FOR CURB RAMPS
G-32B	NOTES FOR CURB RAMPS
D-2	CURB INLET - TYPE B
D-11A	INLETS AND CLEANOUTS NOTES AND DETAIL
D-11B	INLETS AND CLEANOUTS NOTES AND DETAIL
D-12	CURB INLET OPENING
D-13	WELDED STEEL GRATE FRAME
D-15	DRAINAGE STRUCTURE GRATE
D-25A	CURB OUTLET-TYPE A
D-29	CATCH BASIN-TYPE I
D-62	PIPE COLLAR
SC-01	SEWER CLEANOUT
I—15	ELECTRICAL PULLBOX FOR DIRECT BURIAL CONTROL WIRES AND SPLICING NOTES

LIST OF CITY OF SANTEE PUBLIC WORKS STANDARDS

ATION 2075 PER ROS 11252 - LEAD PLUG & BRASS TAG STAMPED "RCE

16930" PER MAP 9372, LOCATED AT THE SOUTHEAST RETURN AT THE

RSECTION OF MISSION GORGE ROAD AND OLIVE LANE.


LEVATION: 337.97, M.S.L. DATUM

PW-02	NARROW IRENCH RESURFACING
PW-03	SLOT TRENCH RESURFACING
PW-17	METAL POLE WALKWAY LIGHTING STANDARD
PW-20	CONCRETE POLE STREET LIGHTING STANDARD
PW-21	COMMERCIAL DRIVEWAY/ALLEY APRON

REVISIONS

CUYAMACA STREET RIGHT TURN POCKET CIP 2014-02

INTERSECTION OF CUYAMACA STREET AND MISSION GORGE ROAD

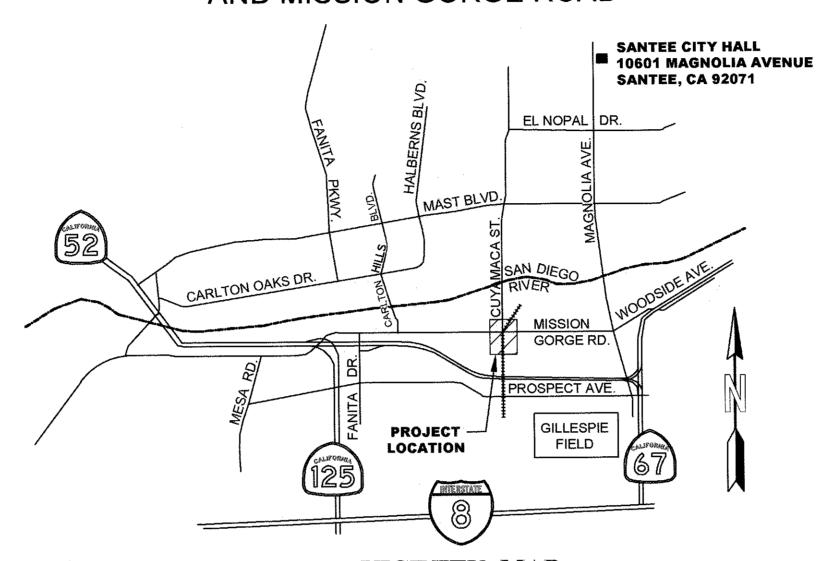

VICINITY MAP NO SCALE

LEGEND:

SCALE

HORIZ:

VERT: N/A

MISSION GORGE ROAD AND **CUYAMACA STREET INTERSECTION SANTEE, CA 92071**

* ALL DIMENSIONS IN FEET UNLESS OTHERWISE SHOWN

ITEM (SDRSD)	SYMBOL	EXIST MTS CATENARY WIRE	· · · · · · · · · · · · · · · · · · ·
CENTERLINE	10+00	EXIST GUY WIRE	State State - In a constitute of the state o
PROPOSED RIGHT OF WAY		EXIST STREET LIGHT	
EXIST RIGHT OF WAY			(#)
EXIST EASEMENT		CONSTRUCTION NOTE	π
EXIST TELEPHONE		EXIST SIGN	e de de la companya del companya de la companya del companya de la
EXIST CABLE TV	was a second of grants	COLD MILLING (2") AND 2" AC PAVEMENT	
EXIST ELECTRIC		6" AC ON 12" CAB	
EXIST FIBER OPTIC			
EXIST SANITARY SEWER (SIZE AND TYPE AS NOTED ON PLANS)		4" PCC (UNLESS OTHERWISE NOTED)	4 4 4 4
EXIST WATER	And the second s	4" AC PAVEMENT OVER NATIVE SOIL	
EXIST GAS		SAWCUT LINE	
EXIST RECYCLED WATER		DAYLIGHT/SLOPE LINE	
EXIST CURB INLET		PROPERTY BOUNDARY	
EXIST CURB AND GUTTER	Lauren II. (1905) de muste en	BMP	1 1 1 1 1
EXIST STORM DRAIN		ROCK COBBLE AND LANDSCAPE BOULDERS	
EXIST MTS CATENARY POLE	and the second s		harring and a second

ENGINEER OF WORK'S DESIGN CERTIFICATION

DRAWN BY

VINCENT MALONG

MARK TARRALL HEREBY DECLARE THAT I AM THE ENGINEER OF WORK FOR THIS PROJECT, THAT I HAVE EXERCISED RESPONSIBLE CHARGE, AS DEFINED IN SECTION 6703 OF THE BUSINESS AND PROFESSIONS CODE, OVER THE ENGINEERING DESIGN OF THIS PROJECT AND THAT THE DESIGN IS CONSISTENT WITH CURRENT STANDARDS.

_ EXPIRES__

REGISTRATION NO. C71953. MY REGISTRATION EXPIRES ON 12/31/2025

PLANS PREPARED UNDER THE SUPERVISION OF

VINCENT MALONG

MARCH 4, 2024

CHECKED BY REVIEWED_ MARK TARRALL 12/31/2025

STANDARD SPECIFICATIONS: SHEET INDEX . STANDARD SPECIFICATIONS FOR PUBLIC WORKS CONSTRUCTION

DESCRIPTION	("GREENBOOK") 2015 EDITION.
TITLE SHEET	2 STANDARD SPECIAL PROVISI

DRAINAGE PLAN, PROFILE, AND DETAIL

LIGHTING AND TRAFFIC SIGNAL PLANS

PLAN AND PROFILE

UTILITY PLAN

14-15

16-21

BENCHMARK:

"RCE 16930"

N: 1885688.621

E: 6334933.142

ELEV:337.97 MSL

CSF: 0.9999864

N: 1885702.986

E: 6336950.070

CONVERGENCE: -0°24'20.29"

MONUMENT STAMPED "RCE 9416"

CONSTRUCTION DETAILS

JACK AND BORING DETAIL

TRAFFIC HANDLING PLAN

STRUCTURE PLANS

STATION 2075 PER ROS 11252 - LEAD PLUG & BRASS TAG STAMPED "RCE 16930" PER MAP 9372, LOCATED

AT THE SOUTHEAST RETURN AT THE INTERSECTION

THE BASIS OF BEARINGS FOR THIS SURVEY IS THE

CALIFORNIA COORDINATE SYSTEM OF 1983 (CCS83)

BETWEEN GPS STATIONS 2075 AND 2082 PER RECORD

ZONE 6. NAD83 BASED UPON THE GRID BEARING

GRID BEARING 2075 TO 2082: N 89°35'31 E 2016.98'

STATION 2075: LEAD PLUG & BRASS TAG STAMPED

OF SURVEY 11252 AND IS DETERMINED BY GPS

MEASUREMENTS TAKEN ON OCTOBER 2, 2019.

STATION 2082: STANDARD STREET SURVEY

SEWER & WATER AGENCY

PADRE DAM MUNICIPAL WATER DISTRICT

VALID FOR ONE YEAR FROM DATE OF SIGNATURE.

SIGNATURE OF THESE PLANS IS NOT A COMMITMENT TO SERVE.

CUYAMACA STREET RIGHT TURN POCKET

APPROVED BY Director of Engineering and Planning

CITY OF SANTEE

TITLE SHEET

OF MISSION GORGE ROAD AND OLIVE LANE

ELEVATION: 337.97, M.S.L. DATUM

BASIS OF BEARINGS:

2. STANDARD SPECIAL PROVISIONS. NOTES, LEGEND, AND KEY MAP TYPICAL CROSS-SECTION

3. CITY OF SANTEE DEVELOPMENT SERVICES STANDARDS, LATEST EDITION.

4. CALIFORNIA DEPARTMENT OF TRANSPORTATION, "MANUAL OF TRAFFIC CONTROLS FOR CONSTRUCTION AND MAINTENANCE WORK ZONES," LATEST

5. STANDARD SPECIFICATIONS OF THE PADRE DAM MUNICIPAL WATER DISTRICT WATER AGENCIES' STANDARDS, W.A.S., LATEST EDITION

PAVEMENT DELINEATION AND SIGN PLANS 6.CALTRANS STANDARD PLANS 2002 AND 2018

STANDARD DRAWINGS:

1. CITY OF SANTEE STANDARD DRAWINGS

2. SAN DIEGO REGIONAL STANDARD DRAWINGS (SDRSD) AS RECOMMENDED BY THE REGIONAL STANDARDS COMMITTEE, MAINTAINED AND PUBLISHED BY THE SAN DIEGO COUNTY DEPARTMENT OF PUBLIC WORKS, 2018 EDITION.

3. STANDARD DRAWINGS OF THE PADRE DAM MUNICIPAL WATER DISTRICT, WATER AGENCY STANDARDS, W.A.S. (LATEST EDITION)

4. CALTRANS STANDARD SPECIFICATIONS 2002 AND 2018

Call 2 Rull Working Days in Advance

UTILITY ALERT NOTE:

ATTENTION IS DIRECTED TO THE POSSIBLE EXISTENCE OF UNDERGROUND UTILITY FACILITIES NOT KNOWN OR IN A LOCATION DIFFERENT FROM THAT WHICH IS SHOWN ON THE PLANS OR IN THE SPECIAL PROVISIONS. THE CONTRACTOR SHALL TAKE STEPS TO ASCERTAIN THE EXACT LOCATION OF ALL UNDERGROUND FACILITIES PRIOR TO PERFORMING WORK THAT MAY DAMAGE SUCH FACILITIES OR INTERFERE WITH THEIR SERVICE. FORTY-EIGHT HOURS BEFORE EXCAVATING, THE CONTRACTOR SHALL VERIFY THE LOCATION OF UNDERGROUND FACILITIES BY CONTACTING UNDERGROUND SERVICE ALERT AT TELEPHONE 8-1-1.

	AS-BUILT	
- Allertine and the second sec		A A A A A A A A A A A A A A A A A A A
SIGNATURE	RCE NUMBER	DATE

	CITY OF SANTEE		
~ ~ ~ ~ ~ ~ ~ ~ ~ ~ ~ ~ ~ ~ ~ ~ ~ ~ ~	FIRE DEPARTMENT FIRE MARSHAL		24
BENCY	COMMUNITY SERVICES DEPARTI	MENT 7-()	-2024
	ENGINEERING DIVISION	7/10	dad
TER DISTRICT	FOR CITY ENGINEER	DATE	/24
7/10/24 Date /2/31/24 Date Exp	PLANNING DIVISION PROJECT PLANNER	7/10/ DATE	124
SA OF SIGNATURE. T A COMMITMENT TO SERVE.	TRAFFIC ENGINEERING DIVISION	7 · 16 · 2 DATE	4
DEPARTMENT OF DEVELO	PMENT SERVICES	CITY W.O. NO.	DRAWING NO.

CIP 2014-02

2021-100

SHEET 1 OF 21

HTTP://WWW.SDMTS.COM/BUSINESS/PERMITS.ASP OR CONTACT MTS PERMITS AT MTSROW@SDMTS.COM. APPLICANT/CONTRACTOR IS REFERRED TO AS THE

2. CERTIFICATION OF INSURANCE FROM YOUR INSURANCE COMPANY FOR GENERAL LIABILITY, AUTOMOBILE LIABILITY, POLLUTION LIABILITY (IF APPLICABLE), PROFESSIONAL LIABILITY (IF APPLICABLE). AND WORKMAN'S COMPENSATION MUST BE SUBMITTED AND APPROVED BY MTS BEFORE THE PERMIT WILL BE PROCESSED. FULL INSURANCE REQUIREMENT GUIDELINES CAN BE ACCESSED FROM THE MTS WEBSITE NOTED ABOVE

3. MOST GENERAL LIABILITY INSURANCE POLICIES DO NOT COVER RAILROADS. ANY EXCLUSIONS RELATING TO PERFORMANCE OF OPERATIONS WITHIN THE VICINITY OF ANY RAILROAD, BRIDGE, TRESTLE, TRACK, ROADBED, TUNNEL, UNDERPASS, OR CROSSING MUST BE DELETED FROM ALL POLICIES BY ENDORSEMENT. ADDITIONALLY. A SEPARATE RAILROAD PROTECTIVE LIABILITY POLICY WILL MOST LIKELY BE REQUIRED AFTER PROJECT REVIEW AS DEEMED NECESSARY BY MTS.

4. ALL PERSONNEL PERFORMING WORK ON MTS R/W, OR ENTERING MTS R/W SHALL REQUIRE PROPER MTS RAIL SAFETY TRAINING CERTIFICATION PRIOR TO ENTERING MTS R/W. ANY CONTRACTORS OR SUBCONTRACTORS PERFORMING WORK ON BEHALF OF PERMITTEE, SHALL BE DEEMED AS AGENTS OF PERMITTEE AND SHALL REQUIRE SAID TRAINING AS WELL, FOR TRAINING INFORMATION, EMAIL MTSROW@SDMTS.COM. TRAINING CERTIFICATION IS VALID FOR ONE YEAR AND IS CONFINED TO MTS/SD&AE FACILITIES ONLY.

5. PERMITTEE SHALL PROVIDE MTS WITH AN APPROVED SET OF TRAFFIC CONTROL PLANS THAT CONFORM TO THE MANUAL OF UNIFORM TRAFFIC CONTROL DEVICES (MUTCD) AND COMPLY IN PARTICULAR WITH PART 8 "TRAFFIC CONTROL FOR RAILROAD AND LIGHT RAIL TRANSIT GRADE CROSSINGS".

6. IF PROJECT INVOLVES CASING SLEEVES UNDER RAILROAD TRACKS AND ACROSS MTS R/W. PERMITTEE SHALL ADHERE TO MTS JACK AND BORE DESIGN CRITERIA AND CONSTRUCTION NOTES.

7. A PRE-CONSTRUCTION MEETING WILL BE REQUIRED WITH MTS/SDTI PRIOR TO WORK COMMENCING WITHIN MTS R/W. A WRITTEN NOTICE OF PLANNED START OF WORK MUST BE SUBMITTED TO MTS A MINIMUM OF FIVE (5) BUSINESS DAYS PRIOR TO WORK STARTING IN MTS R/W. ALL WORK WILL BE STOPPED AND PERMITTEE WILL NOT BE ALLOWED IN MTS R/W WITHOUT PROPER NOTIFICATION.

8. PERMITTEE'S ON-SITE SUPERVISION SHALL RETAIN/MAINTAIN A FULLY EXECUTED COPY OF THE RIGHT OF ENTRY PERMIT AT ALL TIMES WHILE ON MTS R/W.

9. SDTI RAIL FLAGGING WILL BE REQUIRED ANYTIME WORK IS WITHIN FIFTEEN (15) FEET OF ANY OPERABLE TRACK INCLUDING AIRSPACE OR AS DEEMED NECESSARY BY MTS. A SDTI FLAGPERSON / RIGHT-OF-WAY WORK REQUEST FORM MUST BE SUBMITTED TO SDTI A MINIMUM OF THREE (3) BUSINESS DAYS PRIOR TO ANTICIPATED WORK, FORMS ARE ATTACHED TO THE ROE PERMIT OR CAN BE REQUESTED THROUGH MTS RIGHT OF WAY SERVICES.

10. A SDTI TRACTION POWER SHUTDOWN MAY BE NECESSARY FOR THE WORK ZONE TO PROTECT AND MAINTAIN THE REQUIRED TEN (10) FOOT CLEARANCE FROM TROLLEY OVERHEAD HIGH VOLTAGE CATENARY SYSTEM (OCS). PERMITTEE SHALL SUBMIT A SDTI RED TAG/TRACTION POWER REMOVAL REQUEST FORM TO SDTI AT LEAST THREE (3) BUSINESS DAYS PRIOR TO START OF WORK, POWER SHUTDOWNS SHALL ONLY BE ALLOWED DURING NON-OPERATING TROLLEY HOURS. FORMS ARE ATTACHED TO THE ROE PERMIT OR CAN BE REQUESTED THROUGH MTS RIGHT OF WAY SERVICES.

11. PERMITTEE SHALL CONTACT AND SCHEDULE DIG-ALERT AND CABLE PIPE AND LEAK ("CPL") PRIOR TO ANY EXCAVATION IN MTS R/W. PERMITTE SHALL NOTIFY MTS A MINIMUM OF THREE (3) BUSINESS DAYS PRIOR TO THE SCHEDULED UTILITY MARKOUT REQUEST AND SHALL SUBMIT A SDTI FLAGPERSON / RIGHT-OF-WAY WORK REQUEST FORM. SDTI PERSONNEL SHALL ACCOMPANY CPL FOR ANY MARKOUT OF TROLLEY FACILITIES.

12. PERMITTEE SHALL ADHERE TO CONSTRUCTION AND SAFETY STANDARDS REQUIRED BY MTS OF THEIR CONTRACTORS WHEN WORKING WITHIN MTS R/W.

13. PERMITTEE SHALL PERFORM ALL WORK IN ACCORDANCE WITH APPLICABLE CALIFORNIA PUBLIC UTILITIES COMMISSION (CPUC) AND CALIFORNIA OCCUPATIONAL SAFETY AND HEALTH ADMINISTRATION (CAL-OSHA) REGULATIONS, MTS LRT DESIGN CRITERIA, AMERICAN RAILWAY ENGINEERING AND MAINTENANCE OF WAY ASSOCIATION (AREMA) STANDARD SPECIFICATIONS, MANUAL OF UNIFORM TRAFFIC CONTROL DEVICES (MUTCD) GUIDELINES AND MTS, SDTI AND SD&IV OPERATIONS AND SAFETY POLICIES.

ABBREVIATIONS:

SUITE 100 SAN DIEGO, CA 92108

CONTRACTOR

DATE COMPLETED

NSPECTOR

AB	AGGREGATE BASE	Ε	EAST	LL	LANE LINE	PT	EMPTY CONDUCT WITH PULL TAPE
AC	ASPHALT CONCRETE PAVEMENT	EΑ	EACH	LT	LEFT	PVC	POLYVINYL CHLORIDE
ACP	ASBESTOS CEMENT PIPE	ECR	END CURB RETURN	МН	MANHOLE	R	RADIUS
ADA	AMERICAN DISABILITIES ACT	EG	EXISTING GRADE	MAX	MAXIMUM	RCP	REINFORCED CONCRETE PIPE
BCR	BEGIN CURB RETURN	ELEV	ELEVATION	MIN	MINIMUM	RCPT	RECEPTACLE
BEG	BEGIN	EP	EDGE OF PAVEMENT	MISC	MISCELLANEOUS	RSP	REVISED STANDARD PLAN
ВМ	BENCHMARK	EXIST	EXISTING	MOD	MODIFIED	RT	RIGHT
ВМР	BEST MANAGEMENT PRACTICE	FG	FINISHED GRADE	Ν	NORTH	RW	RECYCLED WATER
BOP	BOTTOM OF PIPE	FS	FINISHED SURFACE	NO.	NUMBER	R/W	RIGHT OF WAY
BSM	BIOFILTRATION SOIL MEDIA	FL	FLOW LINE	NTS	NOT TO SCALE	S	SEWER SERVICE -OR- SLOPE
BSW	BACK OF SIDEWALK	FSW	FRONT OF SIDEWALK	O.C.	ON CENTER		-OR- SOUTH
С	CONDUIT	FT	FEET	OD	OUTSIDE DIAMETER	SC	SAWCUT
CC	CROWN CASTLE	G	GROUND	OG	ORIGINAL GROUND	SCH.	SCHEDULE
C&G	CURB & GUTTER	GB	GRADE BREAK	PVMT	PAVEMENT	SD	STORM DRAIN
CAB	CRUSHED AGGREGATE BASE	GL	GUTTER LIP	MIN	MINIMUM	SDG&E	SAN DIEGO GAS & ELECTRIC
CCP	CONCRETE CYLINDER PIPE	GV	GATE VALVE	MISC	MISCELLANEOUS	SDRSD	SAN DIEGO COUNTY REGIONAL
CL	CENTERLINE	HH	HAND HOLE	MOD	MODIFIED		STANDARD DRAWING
CKT	CIRCUIT	HI	HIGH POINT	Ν	NORTH	SF	SQUARE FEET
CONT	CONTINUOUS	HMA	HOT MIX ASPHALT	NO	NUMBER	SG	SUBGRADE
CITY	CITY OF SANTEE	HP	HIGH PRESSURE	NTS	NOT TO SCALE	SL	STREET LIGHT
COX	COX COMMUNICATIONS	IN	INCHES	O.C.	ON CENTER	SM	SEWER MANHOLE
CSP	CALTRANS STANDARD PLANS	ΙE	INVERT ELEVATION	OD	OUTSIDE DIAMETER	STA	STATION
CT	CALTRANS	IOD	IRREVOCABLE OFFER OF	OG	ORIGINAL GROUND	STD	STANDARD
CY	CUBIC YARDS		DEDICATION	PVMT	PAVEMENT	STL	STEEL
DIA	DIAMETER	Jt	JOINT	PB	PULL BOX	SW	SIDEWALK
DWG	DRAWING	L	LENGTH	PCC	PORTLAND CEMENT CONCRETE	TC	TOP OF CURB
DWY	DRIVEWAY	LF	LINEAR FEET		-OR-	TEL	TELECOMMUNICATIONS
					POINT ON COMPOUND CURVE	TYP	TYPICAL
			POFFSCY	PDMWD	PADRE DAM MUNICIPAL WATER	VAR	VARIABLE
			PROFESSIONAL		DISTRICT	VCP	VITRIFIED CLAY PIPE
		//.\.\.\	/ \\ \\ \\ \\				

POLYETHYLENE

POUR IN PLACE

PROPERTY LINE

POWER POLE

POINT OF INFLECTION

POINT ON REVISE CURVE

13. PERMITTEE SHALL PERFORM ALL WORK IN ACCORDANCE WITH APPLICABLE CALIFORNIA PUBLIC UTILITIES COMMISSION (CPUC) AND CALIFORNIA OCCUPATIONAL SAFETY AND HEALTH ADMINISTRATION (CAL-OSHA) REGULATIONS, MTS LRT DESIGN CRITERIA, AMERICAN RAILWAY ENGINEERING AND MAINTENANCE OF WAY ASSOCIATION (AREMA) STANDARD SPECIFICATIONS, MANUAL OF UNIFORM TRAFFIC CONTROL DEVICES (MUTCD) GUIDELINES AND MTS, SDTI AND SD&IV OPERATIONS AND SAFETY POLICIES.

14. PERMITTEE AGREES THAT NO WORK BY HIMSELF OR HIS AUTHORIZED AGENT WILL INTERFERE WITH RAILROAD/TROLLEY OPERATIONS.

15. PERMITTEE AGREES TO COORDINATE ON A DAILY BASIS A REASONABLE ACCESS TO ALL MTS/SD&AE FACILITIES WITH CONTRACT OPERATORS, SDTI, AND SD&IV. SDTI TROLLEY OPERATIONS ARE GENERALLY FROM THE HOURS OF 4:00 A.M. TO 2:00 A.M. THE FOLLOWING DAY. SD&IV FREIGHT TRAINS NORMAL OPERATIONS ARE DURING NON-TROLLEY HOURS.

16. PERMITTEE SHALL MAINTAIN SAFE PEDESTRIAN ACCESS TO ALL TROLLEY PLATFORMS AND BUS STOPS AT ALL TIMES. A MINIMUM OF FIVE (5) FOOT WIDE ACCESSIBLE PEDESTRIAN PATH THROUGH THE CONSTRUCTION SITE SHALL BE MAINTAINED AT ALL TIMES. THE CONSTRUCTION BOUNDARY SHALL CONSIST OF A TOP AND BOTTOM RAIL CONSTRUCTED OF PLASTIC PIPE, OSHA PLASTIC MESH, OR APPROVED EQUAL. YELLOW CAUTION TAPE IS NOT ACCEPTABLE.

17. PERMITTEE SHALL NOT STORE EQUIPMENT, TOOLS, AND MATERIALS WITHIN FIFTEEN (15) FEET FROM TROLLEY OPERABLE TRACK AND WITHIN TWENTY-FIVE (25) FEET FROM THE FREIGHT TRACK OPERATIONS.

18. PERMITTEE SHALL NOT USE OR STORE HAZARDOUS SUBSTANCES, AS DEFINED BY THE COMPREHENSIVE ENVIRONMENTAL RESPONSE, COMPENSATION, AND LIABILITY ACT, AS AMENDED ("CERCLA") OR PETROLEUM OR OIL AS DEFINED BY APPLICABLE ENVIRONMENTAL LAWS ON MTS R/W.

19. NO VEHICULAR CROSSING OVER TRACKS SHALL BE INSTALLED OR USED BY PERMITTEE WITHOUT PRIOR WRITTEN PERMISSION OF RAILROAD.

20. A WRITTEN NOTICE SHALL BE SUBMITTED TO MTS ONE (1) BUSINESS DAY AFTER WORK IS COMPLETED WITHIN MTS R/W. ANY ADDITIONAL WORK REQUIRED TO REPLACE OR REPAIR THE RAILROAD FACILITIES IN GOOD WORKING ORDER WILL BE THE PERMITTEE'S RESPONSIBILITY PRIOR TO RELIEF FROM MAINTENANCE WITHIN THE PERMIT AREA

21. PERMITTE SHALL REMOVE ALL OF PERMITTEE'S TOOLS, EQUIPMENT, AND MATERIALS FROM RAILROAD PREMISES PROMPTLY UPON COMPLETION OF WORK AND SHALL RESTORE ALL FACILITIES, IMPROVEMENTS, LANDSCAPING, ETC., TO THEIR ORIGINAL CONDITION OR AS SHOWN ON PROJECT WORK SITE PLANS.

MTS JACK AND BORE DESIGN CRITERIA

NOTE: FOR THE PURPOSES OF THIS DESIGN CRITERIA AND SUBSEQUENT CONSTRUCTION NOTES, THE TERM "JACK AND BORE" IS USED GENERICALLY TO REFER TO SEVERAL TRENCHLESS CONSTRUCTION METHODS - A FEW OF WHICH ARE DESCRIBED IN THESE NOTES. THE LIMITATIONS OF THESE NOTES DO NOT PRECLUDE THE USE OF OTHER TRENCHLESS CONSTRUCTION METHODS, PROVIDED THEY ARE APPROVED BY MTS.

THE BASIC GUIDELINES TO BE FOLLOWED FOR JACK AND BORE DESIGN ARE REFERENCED IN THE AREMA (AMERICAN RAILWAY ENGINEERING AND MAINTENANCE OFWAY ASSOCIATION) MANUAL. AS AN MTS SUPPLEMENT TO THE AREMA, THE FOLLOWING STANDARDS AND DESIGN CRITERIA SHALL ALSO APPLY:

 ALL UNDERGROUND UTILITIES UNDER RAILROAD TRACKS SHALL BE ENCASED IN A LARGER PIPE OR CONDUIT CALLED THE "CASING PIPE."

2. INSTALLATION OF CASING PIPES BY OPEN TRENCH IS PROHIBITED UNLESS APPROVED BY MTS.

CASING PIPE SHALL BE INSTALLED ACROSS THE ENTIRE WIDTH OF THE RAILROAD RIGHT-OF- WAY AND SHALL EXTEND BEYOND THE RIGHT-OF-WAY A MINIMUM OF 10 FEET UNLESS OTHERWISE APPROVED BY MTS.

4. THE TOP OF CASING SHALL HAVE A MINIMUM DEPTH OF 5.5 FEET BELOW THE TOP OF TIE AND A MINIMUM DEPTH 3 FEET BELOW GROUND SURFACE INCLUDING BOTTOM OF DITCHES AND OTHER LOW POINTS WITHIN THE RAILROAD RIGHT-OF-WAY.

5. ALL CASING PIPES SHALL BE INSTALLED WITH A MINIMUM SLOPE OF 1% UNLESS. OTHERWISE APPROVED BY MTS AND/OR OTHERWISE APPROVED BY OTHER JURISDICTIONAL DESIGN CRITERIA.

6. THE ENGINEER/CONTRACTOR SHALL SUBMIT TO MTS FOR REVIEW, LOAD CALCULATIONS FOR THE PROPOSED CASING WITH APPLIED LOAD AS DEFINED BY COOPER E-80 WITH A 50% ADDED IMPACT LOAD. THE CALCULATIONS SHALL BE SIGNED AND STAMPED BY A CALIFORNIA LICENSED CIVIL OR STRUCTURAL ENGINEER.

MTS JACK AND BORE CONSTRUCTION NOTES:

1. SEE MTS STANDARD CONSTRUCTION NOTES FOR ADDITIONAL REQUIREMENTS

2. FOR PIPELINES CARRYING FLAMMABLE OR HAZARDOUS MATERIALS, THE CONTRACTOR SHALL ADHERE TO AREMA AND REGULATORY AGENCY GUIDELINES.

3. THE CONTRACTOR SHALL OBTAIN ALL PERMITS NECESSARY FOR THE PROPOSED PROJECT INCLUDING BUT NOT LIMITED TO ENCROACHMENT, SWPPP, AND ENVIRONMENTAL PERMITS, AND THIRD-PARTY UTILITY PERMITS.

4. PRIOR TO ANY COMMENCEMENT OF WORK, THE CONTRACTOR SHALL SUBMIT TO MTS FOR REVIEW AND APPROVAL, AN UPDATED DESCRIPTION OF THE WORK PROCESS INCLUDING ALL PLAN AND FIELD CHANGES/MODIFICATIONS, CERTIFICATES OF COMPLIANCE, AND SCHEDULED ACTIVITIES FOR WORK AFFECTING RAILROAD RIGHT-OF-WAY.

5. PRIOR TO ANY COMMENCEMENT OF WORK, THE CONTRACTOR SHALL SUBMIT TO MTS FOR REVIEW AND APPROVAL. SHORING DRAWINGS AND CALCULATIONS, ALL DRAWINGS AND CALCULATIONS SHALL BE SIGNED AND STAMPED BY A CIVIL OR STRUCTURAL ENGINEER LICENSED IN THE STATE OF CALIFORNIA.

6. THE CONTRACTOR SHALL VERIFY AND MARK OUT ALL RAILROAD RIGHT OF WAY LIMITS AND PROPERTY ENTITLEMENTS (EASEMENTS, LICENSE AGREEMENTS, ETC.) WITHIN THE VICINITY OF THE WORK AND/OR RELATED TO THE WORK.

7. PRIOR TO ANY COMMENCEMENT OF WORK. THE CONTRACTOR SHALL LAYOUT THE PROPOSED JACKING AND RECEIVING PITS FOR MTS INSPECTION AND ACCEPTANCE. BOTH PITS SHALL BE CONSTRUCTED OUTSIDE OF THE RAILROAD RIGHT-OF-WAY UNLESS OTHERWISE APPROVED BY MTS.

8. THE CONTRACTOR SHALL MONITOR RAIL ELEVATIONS PRIOR TO, DURING, AND IMMEDIATELY AFTER THE JACK AND BORE OPERATION. BOTH RAILS OF EACH TRACK SHALL BE MONITORED AT THE POINT OF CROSSING, AND AT 10' AND 20' OUT IN EACH DIRECTION FROM THE CROSSING POINT, UNLESS OTHERWISE DIRECTED BY MTS. TOP OF RAIL ELEVATIONS SHALL BE RECORDED WITH AN ACCURACY OF ONE (1) ONE-HUNDREDTH OF A FOOT (0.01'), AND SHALL BE SUBMITTED TO MTS FOR REVIEW, SURVEYS SHALL BE CONDUCTED:

a. PRIOR TO CONSTRUCTION TO ESTABLISH A BASELINE, NO GREATER THAN 2 WEEKS BEFORE START OF CONSTRUCTION.

b. THREE TIMES A DAY FOR THE DURATION OF THE CONSTRUCTION.

ONCE PER DAY FOR 1 WEEK FOLLOWING 'STABLE' CONDITION WITH COMPLETION OF ALL CONSTRUCTION ACTIVITIES. IF NO MOVEMENT, NO FURTHER MONITORING IS NEEDED.

MTS MAY REQUIRE MORE FREQUENT MONITORING AT CERTAIN LOCATIONS SUCH AS BRIDGE AND GRADE CROSSING APPROACHES, OR LOCATIONS WITH SOFT SOIL CONDITIONS.

9. ALL AREAS BACKFILLED WITHIN THE RAILROAD RIGHT-OF-WAY, OR THAT ENCROACH WITHIN A 2:1 DOWNWARD SLOPING LINE FROM THE EDGE OF RIGHT-OF-WAY, SHALL BE AT 90% RELATIVE DRY COMPACTION. BACKFILLING IN ALL OTHER AREAS SHALL BE IN ACCORDANCE WITH THE LOCAL JURISDICTION'S STANDARDS. THE CONTRACTOR SHALL SUBMIT A COMPACTION REPORT PREPARED BY A CALIFORNIA LICENSED GEOTECHNICAL ENGINEER.

10. THE CONTRACTOR SHALL REMOVE ALL TEMPORARY FACILITIES CONSTRUCTED ON THE RAILROAD RIGHT-OF-WAY, IN ADDIITON TO DEBRIS, TRASH, AND OTHER ITEMS NOT ORIGINALLY AT THE SITE PRIOR TO CONTRUCTION, AND SHALL NOTIFY MTS WITHIN 24 HOURS THAT ALL CONTRUCTION HAS BEEN

JACK AND BORE OPERATIONS

PRIOR TO ANY COMMENCEMENT OF WORK, THE CONTRACTOR SHALL SUBMIT TO MTS FOR REVIEW AND APPROVAL, A PLAN SHOWING THE PROPOSED METHOD OF CASING INSTALLATION, CONSTRUCTION ACCESS, STOCKPILE LOCATIONS, SWPPP CONTROL MEASURES, FENCING TYPE AND LOCATION, AND A MILESTONE SCHEDULE. THE CONTRACTOR MAY UTILIZE ANY ONE OF THE FOLLOWING METHODS OF INSTALLING CASING AND SHALL ADHERE TO ITS RESPECTIVE REQUIREMENTS:

JACKING:

- a. THIS METHOD SHALL BE IN ACCORDANCE WITH THE AREMA (AMERICAN RAILWAY ENGINEERING AND MAINTENANCE OFWAY ASSOCIATION) MANUAL, VOLUME 1, CHAPTER 1, PART "EARTH BORING AND JACKING CULVERT PIPE THROUGH FILLS." THIS OPERATION SHALL BE CONDUCTED WITHOUT HANDMINING AHEAD OF THE PIPE AND WITHOUT THE USE OF ANY TYPE OF BORING, AUGERING, OR DRILLING EQUIPMENT.
- BRACING AND BACKSTOPS SHALL BE DESIGNED AND JACKS WITH SUFFICIENT RATING USED SO THAT THE JACKING CAN PROGRESS WITHOUT STOPPAGE (EXCEPT FOR ADDING LENGTHS OF PIPE) UNTIL THE LEADING EDGE OF THE PIPE REACHES THE RECEIVING PIT.
- c. DURING JACKING, AN EARTH PLUG 1.5 TIMES THE DIAMETER OF THE CASING SHALL BE MAINTAINED AT ALL TIMES. JACKING OPERATIONS SHALL BE CONTINUOUS ON A 24-HOUR PER DAY BASIS UNTIL THE JACKING OPERATION IS COMPLETED.

a. THIS METHOD CONSISTS OF PUSHING THE CASING PIPE INTO THE EARTH WITH A HORIZONTAL AUGER BORING MACHINE WITH AN AUGER ROTATING WITHIN THE CASING PIPE TO REMOVE THE SPOIL. THE FRONT OF THE CASING PIPE SHALL BE PROVIDED WITH MECHANICAL ARRANGEMENTS OR DEVICES THAT WILL PREVENT THE AUGER FROM ADVANCING IN FRONT OF THE CASING SO THAT THERE WILL BE NO UNSUPPORTED EXCAVATION AHEAD OF THE CASING. THE AUGER AND CUTTING HEAD ARRANGEMENT SHALL BE REMOVABLE FROM WITHIN THE PIPE IN THE EVENT AN OBSTRUCTION IS ENCOUNTERED. THE OVER-CUT BY THE CUTTING HEAD SHALL NOT EXCEED THE OUTSIDE DIAMETER OF THE CASING PIPE BY MORE THAN ONE-HALF INCH. THE FACE OF THE CUTTING HEAD SHALL BE ARRANGED TO PROVIDE REASONABLE OBSTRUCTION TO THE FREE FLOW OR RUNNING OF EARTH MATERIAL

b. THE USE OF WATER OR OTHER LIQUIDS TO FACILITATE CASING PLACEMENT AND/OR SPOIL REMOVAL IS PROHIBITED.

PLANS AND DESCRIPTIONS OF THE AUGER STOP ARRANGEMENT TO BE USED SHALL BE SUBMITTED TO MTS FOR REVIEW AND APPROVAL PRIOR TO COMMENCEMENT OF WORK.

NOTE: ANY METHOD WHICH EMPLOYS SIMULTANEOUS BORING AND JACKING OR DRILLING AND JACKING FOR PIPES OVER 8 INCHES IN DIAMETER THAT DOES NOT ADHERE TO THE ABOVE REQUIREMENTS WILL NOT BE PERMITTED. FOR CASING PIPES 8 INCHES AND SMALLER IN DIAMETER, AUGERING OR BORING WITHOUT THE SAME REQUIREMENTS MAY BE CONSIDERED IF APPROVED BY MTS.

DIRECTIONAL DRILLING (FOR CASINGS 12" IN DIAMETER OR LESS)

- a. THIS METHOD CONSISTS OF UTILIZING SPECIALIZED DRILLING EQUIPMENT TO BORE A SMALL DIAMETER PILOT HOLE ALONG THE DESIRED ALIGNMENT USING A MECHANICAL CUTTING HEAD WITH HIGH-PRESSURE BENTONITE SLURRY TO REMOVE THE CUTTINGS. THE DRILL STRING IS ADVANCED WITH THE BENTONITE SLURRY PUMPED THROUGH THE STRING TO THE CUTTING HEAD AND THEN FORCED BACK ALONG THE STRING, CARRYING THE CUTTINGS BACK TO THE SURFACE FOR REMOVAL. AFTER THE CUTTING HEAD REACHES THE FAR SIDE OF THE CROSSING. IT IS REMOVED AND A REAMER (WITH A DIAMETER WIDER THAN THE CUTTING HEAD) IS ATTACHED TO THE LEAD END OF THE DRILL STRING. THE CASING IS ATTACHED TO THE REAMER AND THE CASING IS THEN PULLED BACK INTO ITS FINAL POSITION.
- b. EXCAVATING THE SOIL BY MEANS OF JETTING OF FLUID OR JETTING OF SLURRY ARE NOT ALLOWED.
- SLURRY USE SHALL BE KEPT TO A MINIMUM AND SHALL ONLY BE USED FOR HEAD LUBRICATION AND/OR SPOILS RETURN. THE CONTRACTOR SHALL CALCULATE ANTICIPATED SLURRY USE AND MONITOR ACTUAL USE DURING THE BORING OPERATION IN ORDER TO DETERMINE THE SLURRY LOSS INTO THE SURROUNDING SOIL. THE BENTONITE SLURRY SHALL SEAL THE ANNULAR SPACE BETWEEN THE CASING AND THE EXCAVATED SOIL WITH A MINIMUM RETURN OF 95%.
- JACKING AND RECEIVING PITS SHALL BE FENCED ON ALL SIDES AND SECURED IN COMPLIANCE WITH OSHA REQUIREMENTS

3 ALL JACK AND BORE OPERATIONS WITHIN THE RAILROAD RIGHT-OF-WAY SHALL BE ADVANCED IN A TIMELY MANNER WITH MINIMAL BREAKS IN OPERATION AND NO CHANGE IN CREW OR OPERATOR. AN MTS INSPECTOR SHALL BE PRESENT AT ALL TIMES UNLESS OTHERWISE APPROVED BY MTS. SHOULD WORK BEGIN WITHOUT THE PROPER APPROVALS, THE WORK WILL BE HALTED AND ANY CASING INSTALLED WILL BE ABANDONED IN PLACE, PRESSURE GROUTED FULL, AND CAPPED TO THE SATISFACTION OF THE MTS.

4. PRESSURE GROUTING OF THE SOILS BEFORE OR DURING JACKING OR BORING MAY BE REQUIRED TO STABILIZE THE SOIL, CONTROL WATER, PREVENT LOSS OF MATERIAL, AND PREVENT SETTLEMENT OR DISPLACEMENT OF THE GROUND AND/OR TRACKS. GROUT SHALL BE CEMENT, CHEMICAL, OR OTHER SPECIAL INJECTION MATERIAL SELECTED TO ACCOMPLISH THE NECESSARY STABILIZATION. THE GROUTING CONTRACTOR SHALL BE A SPECIALIST IN THE FIELD WITH A MINIMUM OF 5 YEARS CONTINUOUS EXPERIENCE OF SUCCESSFULLY GROUTING SOIL. MATERIALS TO BE USED AND THE METHOD OF INJECTION SHALL BE PREPARED BY A CALIFORNIA LICENSED GEOTECHNICAL ENGINEER, OR BY AN EXPERIENCED AND QUALIFIED COMPANY SPECIALIZING IN THIS WORK AND SUBMITTED FOR APPROVAL BY MTS PRIOR TO THE COMMENCEMENT OF WORK. PROOF OF EXPERIENCE AND COMPETENCY SHALL ACCOMPANY THE SUBMISSION.


BORED OR JACKED INSTALLATIONS SHALL HAVE A BORED-HOLE DIAMETER ESSENTIALLY THE SAME AS THE OUTSIDE DIAMETER OF THE CASING PLUS THE THICKNESS OF THE PROTECTIVE COATING. IF VOIDS SHOULD DEVELOP OR IF THE BORED-HOLE DIAMETER IS GREATER THAN THE OUTSIDE DIAMETER OF THE CASING PIPE, PLUS COATING, BY MORE THAN APPROXIMATELY 1 INCH, GROUTING OR OTHER METHODS AS APPROVED BY MTS SHALL BE EMPLOYED TO FILL SUCH VOIDS.

CASING AND CARRIER PIPES SHALL BE CONSTRUCTED TO PREVENT LEAKAGE OF ANY SUBSTANCE.

IF AN OBSTRUCTION IS ENCOUNTERED DURING INSTALLATION OF THE CASING PIPE THAT WILL STOP THE FORWARD ACTION OF THE PIPE. AND IT BECOMES EVIDENT THAT IT IS IMPOSSIBLE TO ADVANCE THE PIPE, OPERATIONS WILL CEASE AND THE PIPE SHALL BE ABANDONED IN-PLACE AND PRESSURE GROUTED FULL WITH A 2-SACK SLURRY BEFORE CONTINUING WITH WORK.

8. IF GROUND OR TRACK DISPLACEMENT OF 1/4" OR GREATER IS DETECTED DURING THE INSTALLATION OF THE CASING PIPE, THE CONTRACTOR SHALL CONTACT MTS AND CLOSELY MONITOR DISPLACEMENT. IF DISPLACEMENT OF 1/2" IS DETECTED, THEN ALL OPERATIONS SHALL STOP. THE CONTRACTOR SHALL DEVELOP A REMEDIATION PLAN THAT IS APPROVED BY MTS BEFORE RESUMING OPERATIONS. THE CONTRACTOR IS LIABLE FOR ALL DAMAGES RESULTING FROM GROUND OR TRACK DISPLACEMENT. SHOULD THE TRACK DISPLACE, CORRECTIVE ACTION SHALL BE TAKEN BY MTS FORCES OR THE CONTRACTOR AS APPROVED BY MTS. MTS EXPENSES SHALL BE REIMBURSED BY THE CONTRACTOR.

SHOULD GROUND WATER OR OTHER LOOSE AND UNSTABLE SOILS CONDITIONS BE ENCOUNTERED DURING CONSTRUCTION, THE CONTRACTOR SHALL IMMEDIATELY STOP WORK, NOTIFY THE RAILROAD INSPECTOR AND FLAGMAN, PROVIDE NECESSARY SUPPORT TO

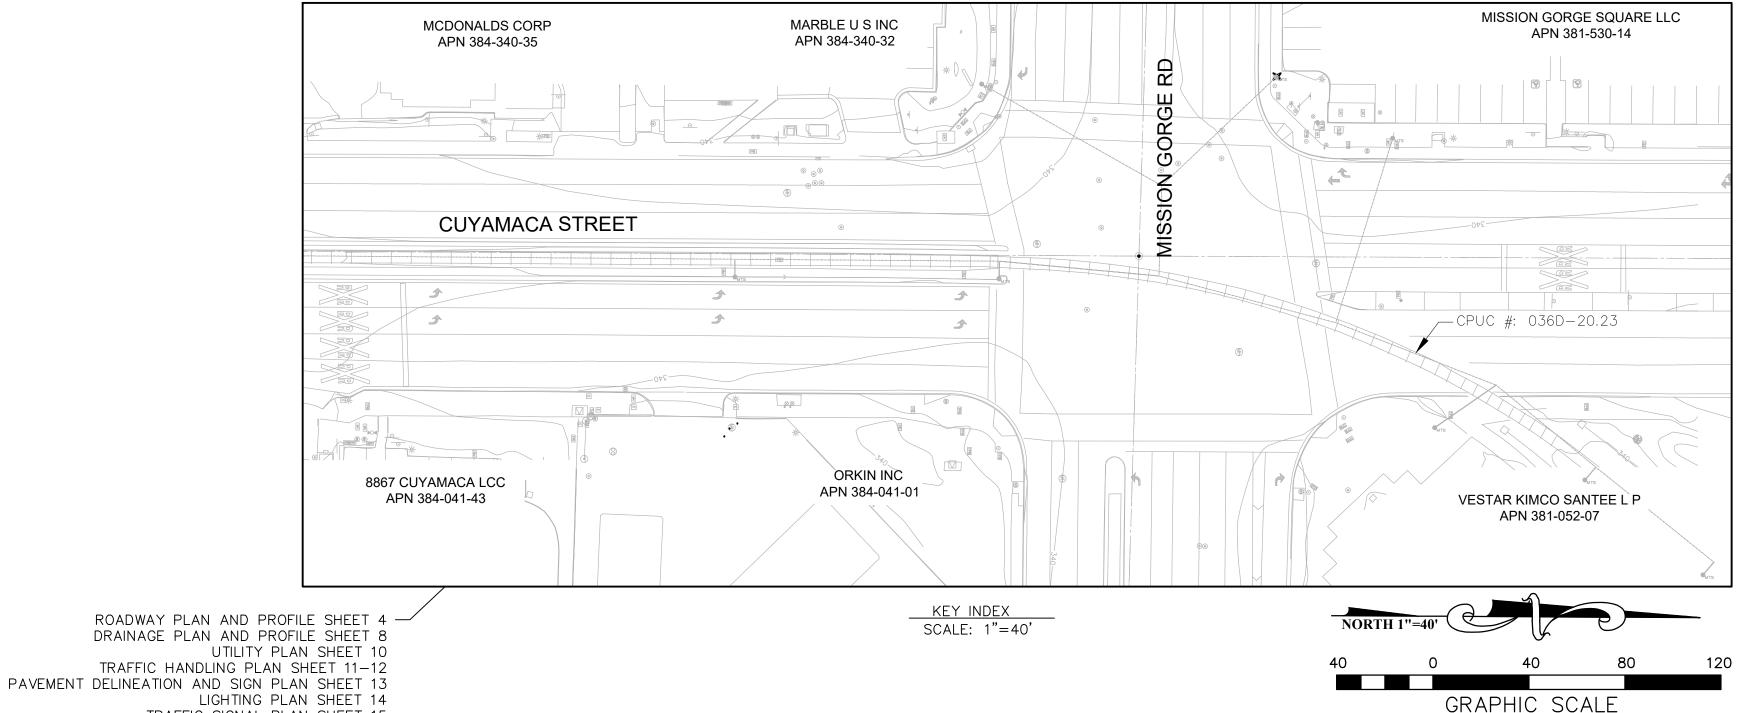

PROP PROPOSED CROSSING X-ING LIGHTING PLAN SHEET 14 TRAFFIC SIGNAL PLAN SHEET 15 CONSTRUCTION RECORD REFERENCES DATE BY REVISIONS ACPTD DESIGNED BY DRAWN BY CHECKED BY SCALE ATION 2075 PER ROS 11252 - LEAD PLUG & BRASS TAG STAMPED "RCE REVIEWED VINCENT MALONG MARK TARRALL VINCENT MALONG 330" PER MAP 9372, LOCATED AT THE SOUTHEAST RETURN AT THE SECTION OF MISSION GORGE ROAD AND OLIVE LANE PLANS PREPARED UNDER THE SUPERVISION OF HORIZ: MARK TARRALI PROJECT ENGINEER 71953 LEVATION: 337.97, M.S.L. DATUM _ EXPIRES__

WAS

WM

WQ

WIDTH -OR- WEST

WATER METER

WATER QUALITY

WATER SERVICE


WATER AGENCIES' STANDARD

CITY OF SANTEE DEPARTMENT OF DEVELOPMENT SERVICES CITY W.O. NO. KEY MAP AND LINE INDEX CIP 2014-02 **CUYAMACA STREET RIGHT TURN POCKET**


DRAWING NO.

1 INCH=40 FEET

SHEET 2 OF 21

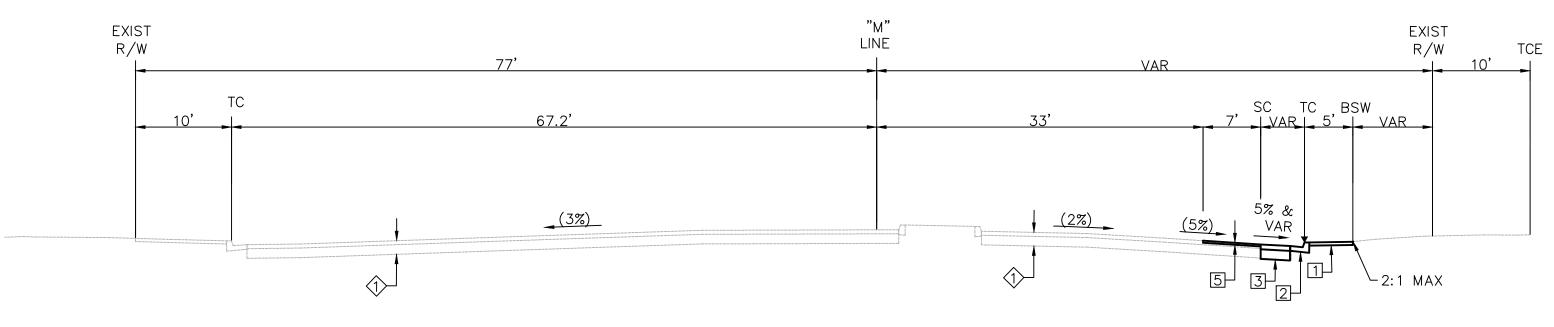


MISSION GORGE RD 11+01.29 TO 11+34.64 1"=10'

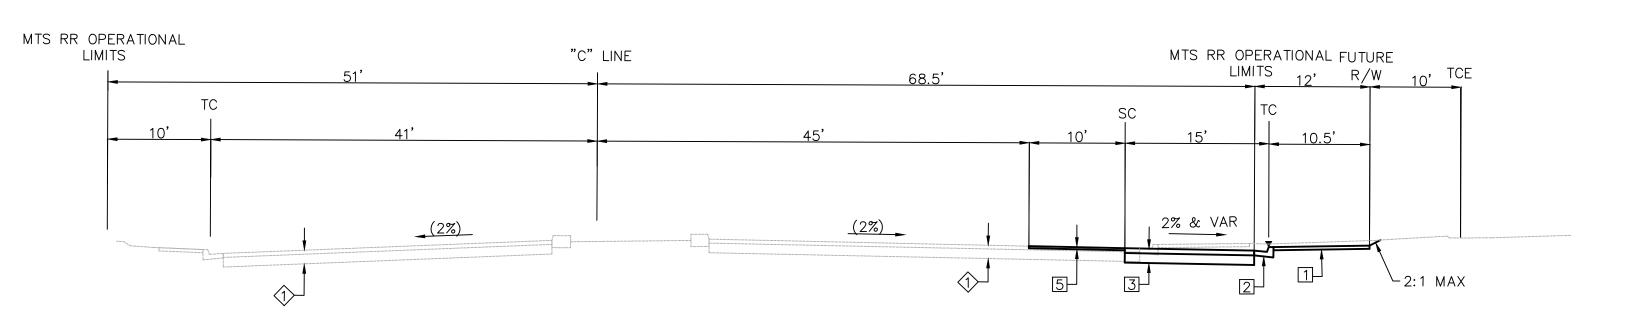

CUYAMACA STREET


7+34.89 TO 9+22.43

1"=10'

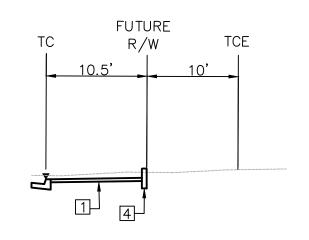

CUYAMACA STREET

7+65.21 TO 7+88.40 8+36.90 TO 8+65.20 1"=10'

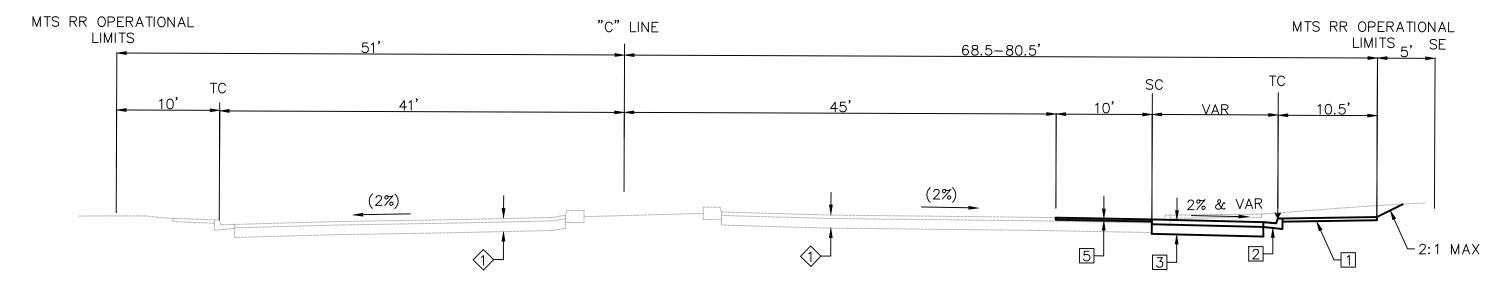



CUYAMA	CUYAMACA STREET									
6+71.21	TO 7+34.89									
1	"=10'									


	PROPOSED PAVEMENT STRUCT	URAL SECTIONS
	DESCRIPTION	TYPE
1	PCC SIDEWALK	SDRSD G-7
2	CURB AND GUTTER	SDRSD G-2 (TYPE G)
3	NEW PAVEMENT SECTION	6" AC 12" CAB
4	RETAINING CURB (MOD)	SEE SHEET 5
5	COLD MILLING (2")	2" MILL AC PVMT 2" AC PVMT
	EXISTING PAVEMENT STRUCTUR	RAL SECTIONS
\Diamond	DESCRIPTION	TYPE
1	EXISTING PAVEMENT	5" AC


1450 FRAZEE ROAD SUITE 100 SAN DIEGO, CA 92108	KKI NEER	No. C71953 Exp. 12/31/2025	ıll		
CONSTRUCTION R	ECORD	REFERENCES	DATE	BY	REVISIONS
CONTRACTOR					
INCRECTOR					

CONSTRUCTION RECORD	REFERENCES	DATE BY	REVISIONS	ACPTD	BENCH MARK	SCALE	DESIGNED BY	DRAWN BY	CHECKED BY		CITY OF SANTEE	DEPARTMENT OF DEVELOPMENT SERVICES	CITY W.O. NO.	DRAWING NO.
CONTRACTOR				STATIO 16930" F	N 2075 PER ROS 11252 - LEAD PLUG & BRASS TAG STAMPED "RCE PER MAP 9372, LOCATED AT THE SOUTHEAST RETURN AT THE		VINCENT MALONG	VINCENT MALONG	MARK TARRALL	REVIEWED				
INSPECTOR				INTERS	ECTION OF MISSION GORGE ROAD AND OLIVE LANE.	HORIZ: 1"=10'	PLANS PREPARED UNI	DER THE SUPERVISION OF			TYPICAL CROSS SECTION		CIP 2014-02	2021-102
DATE COMPLETED							MARK T	ARRALL DAT	E01/12/2024	BY	LCUYAMACA STRE	ET RIGHT TURN POCKET	CIP 2014-02	
				ELEVAT	TION: 337.97, M.S.L. DATUM	VERT: N/A	RCE NO.	71953 EXP	PIRES 12/31/2025	PROJECT ENGINEER			S	SHEET 3 OF 21

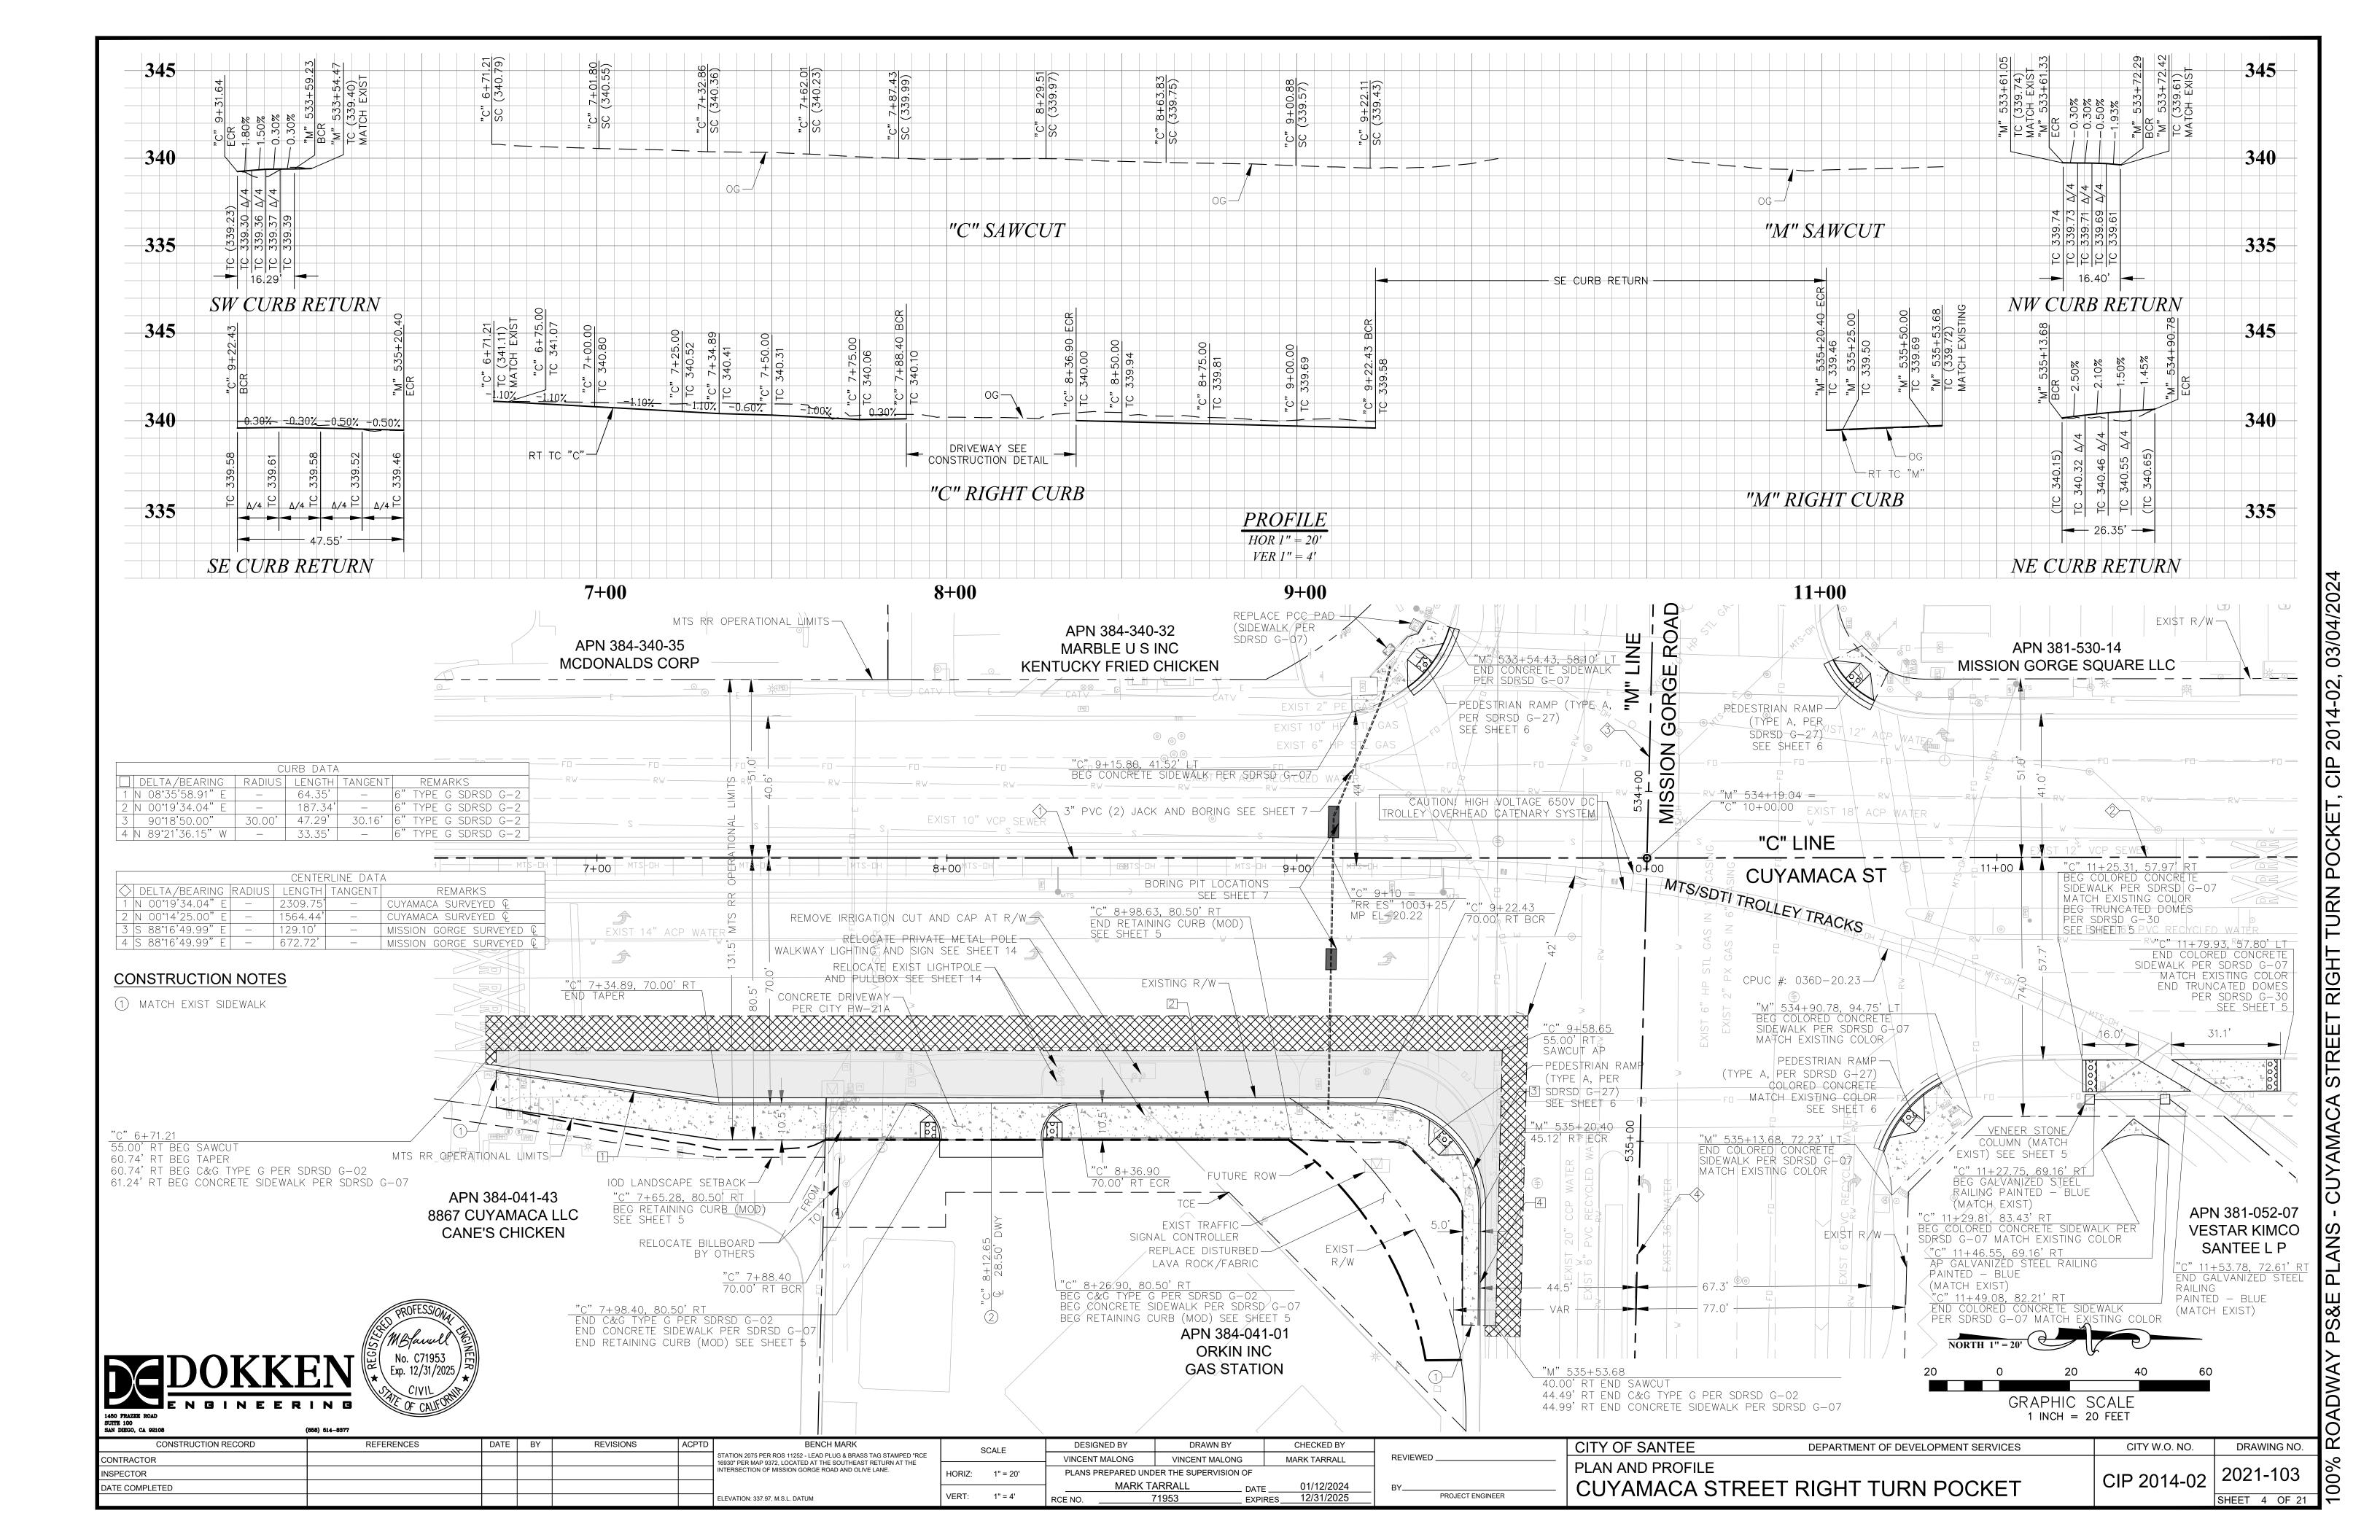


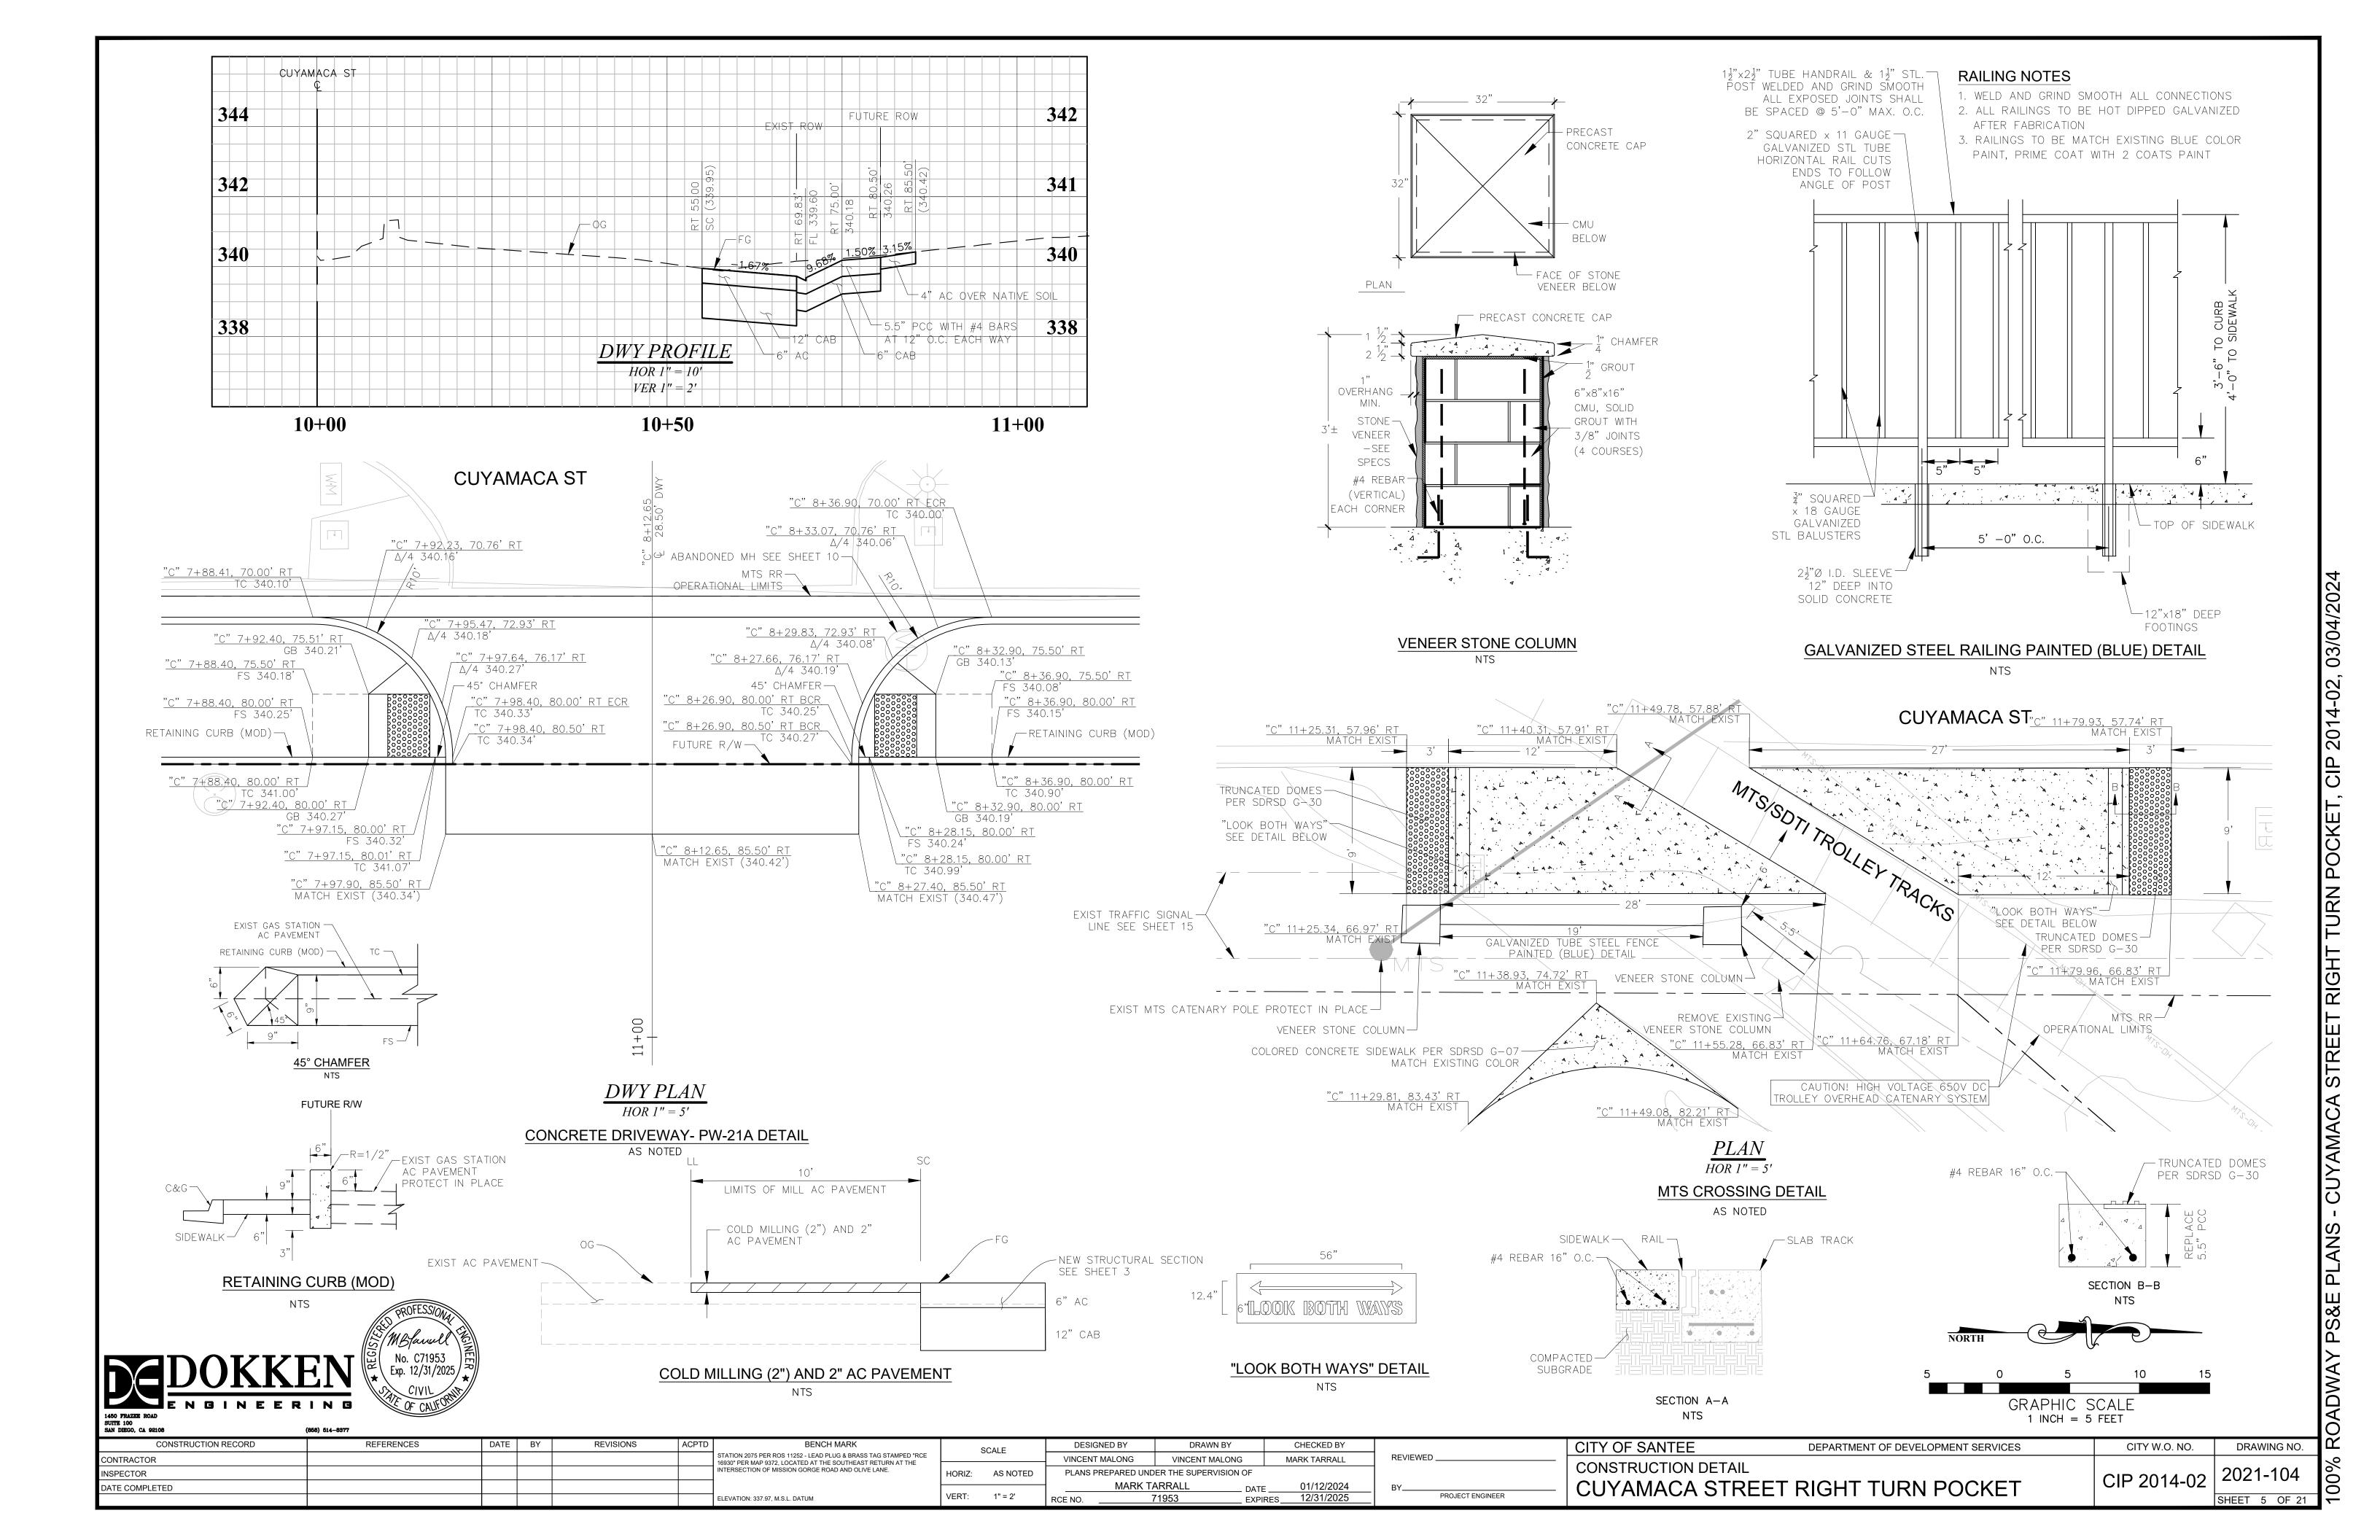

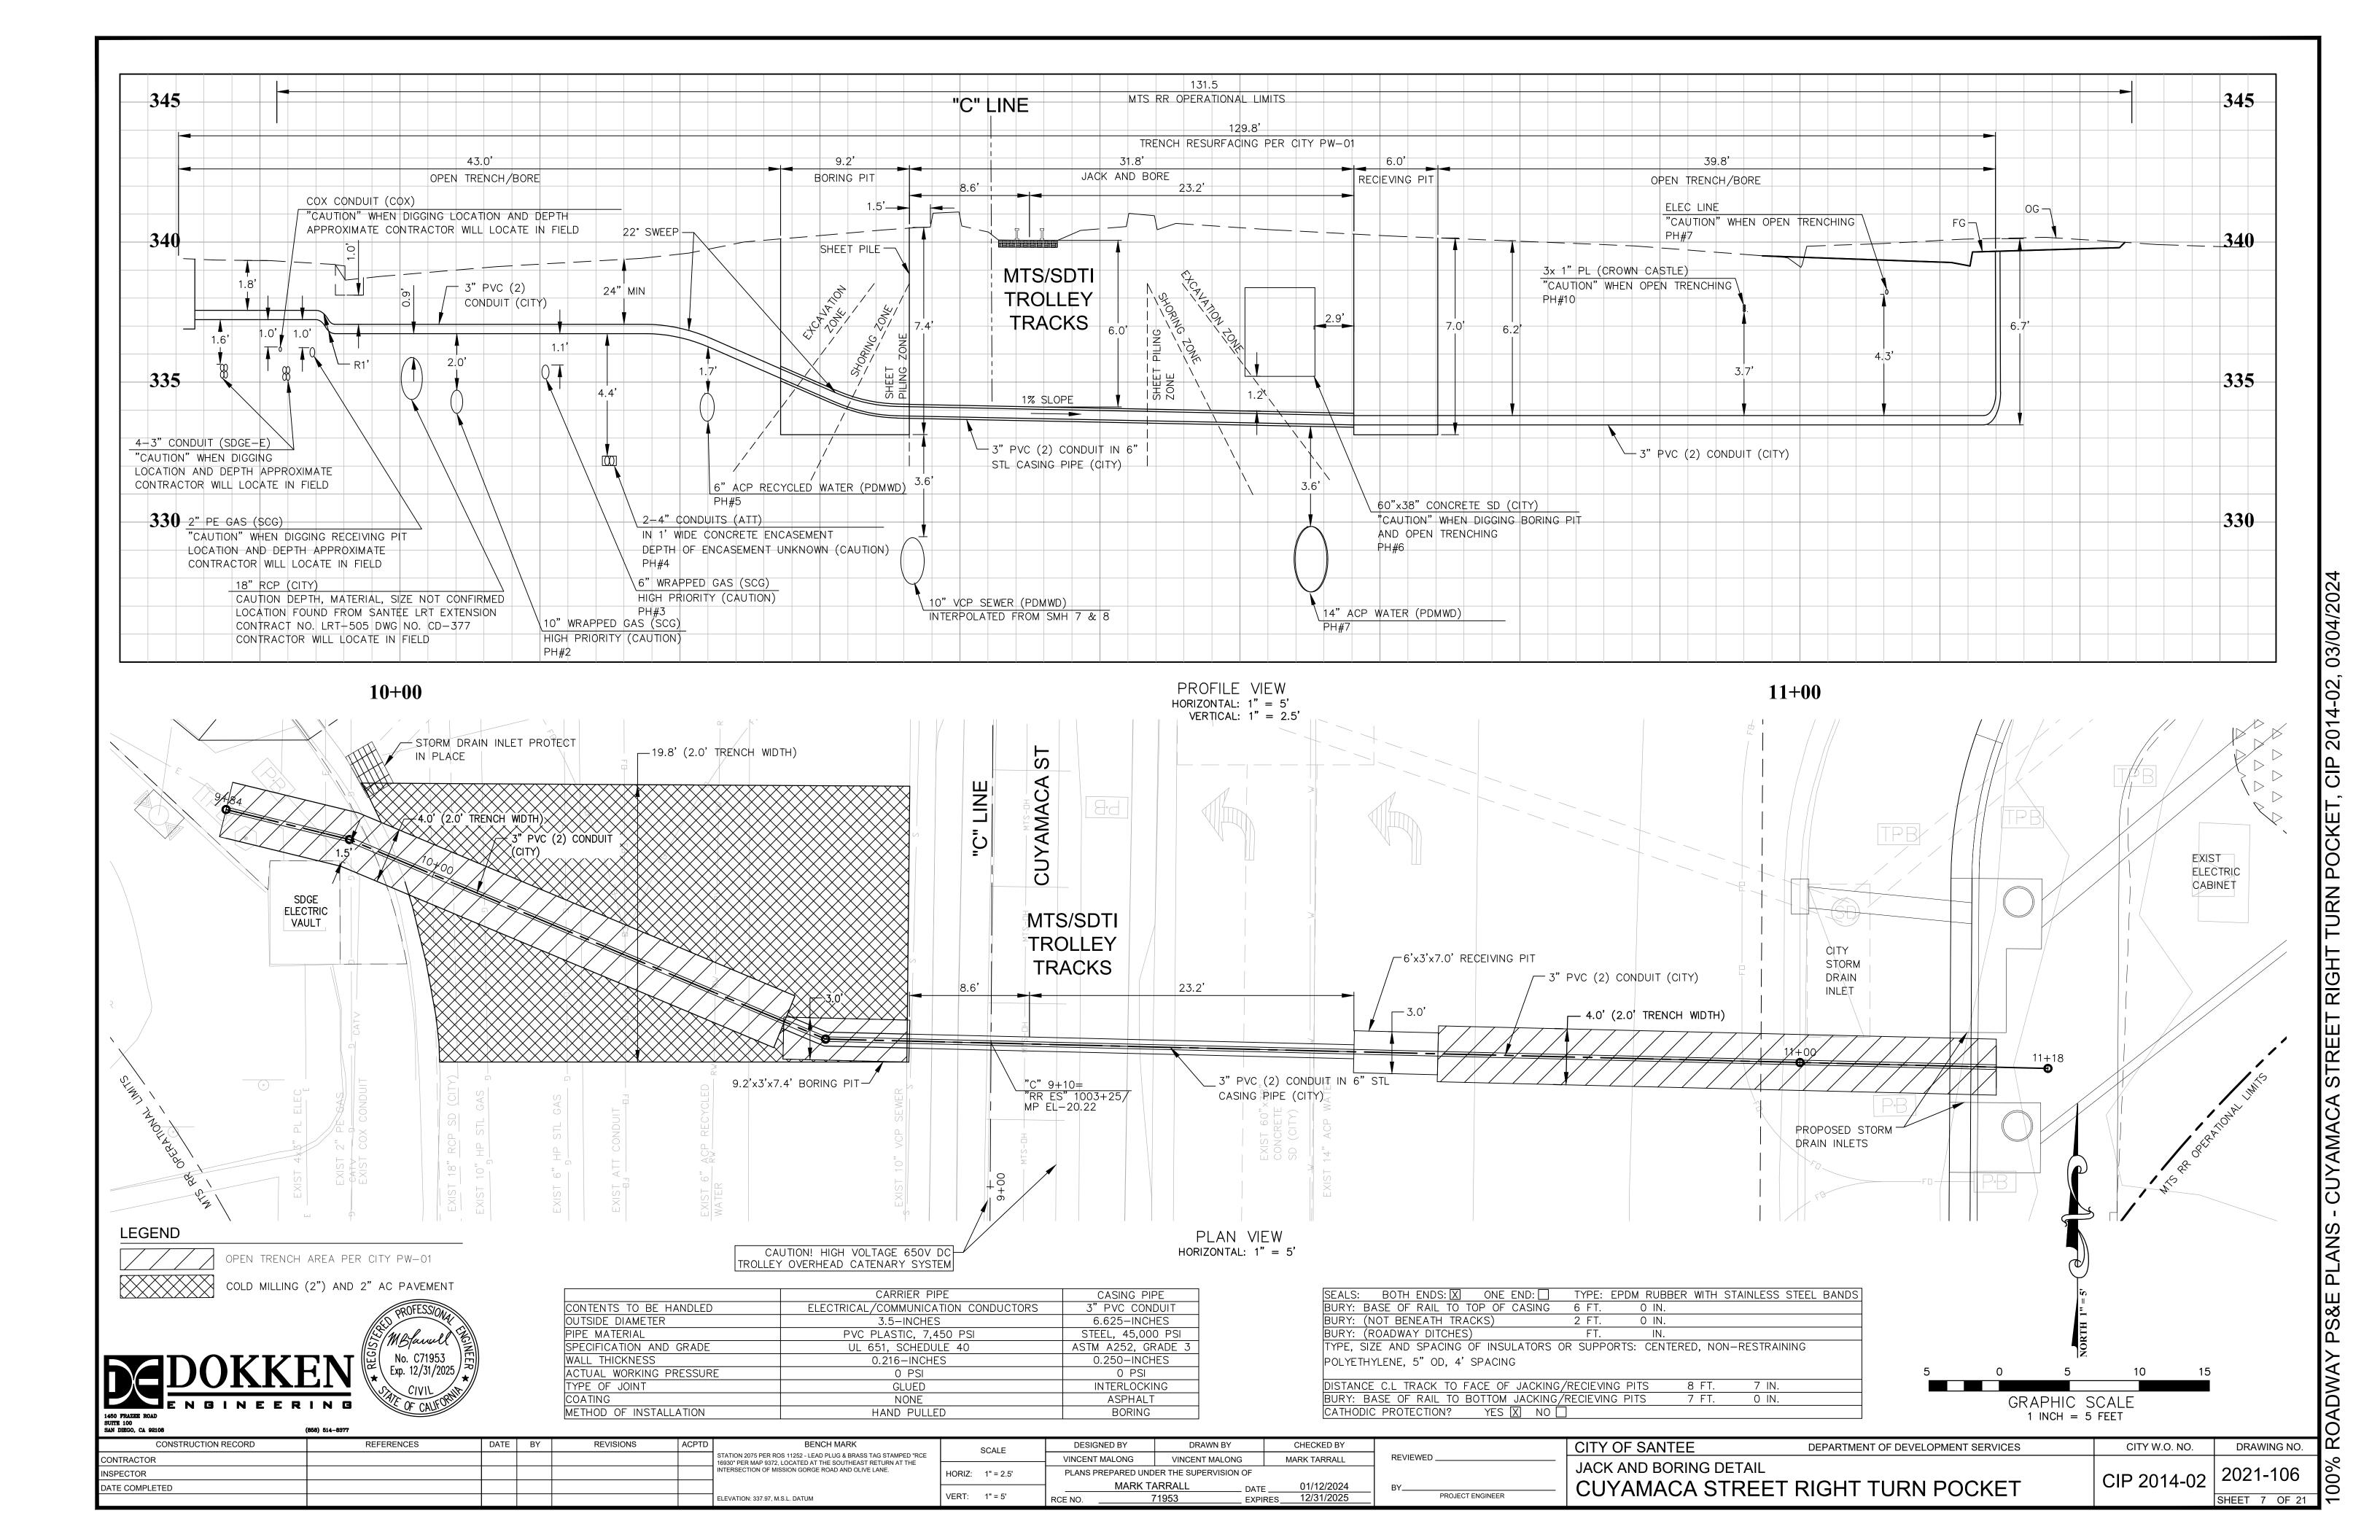

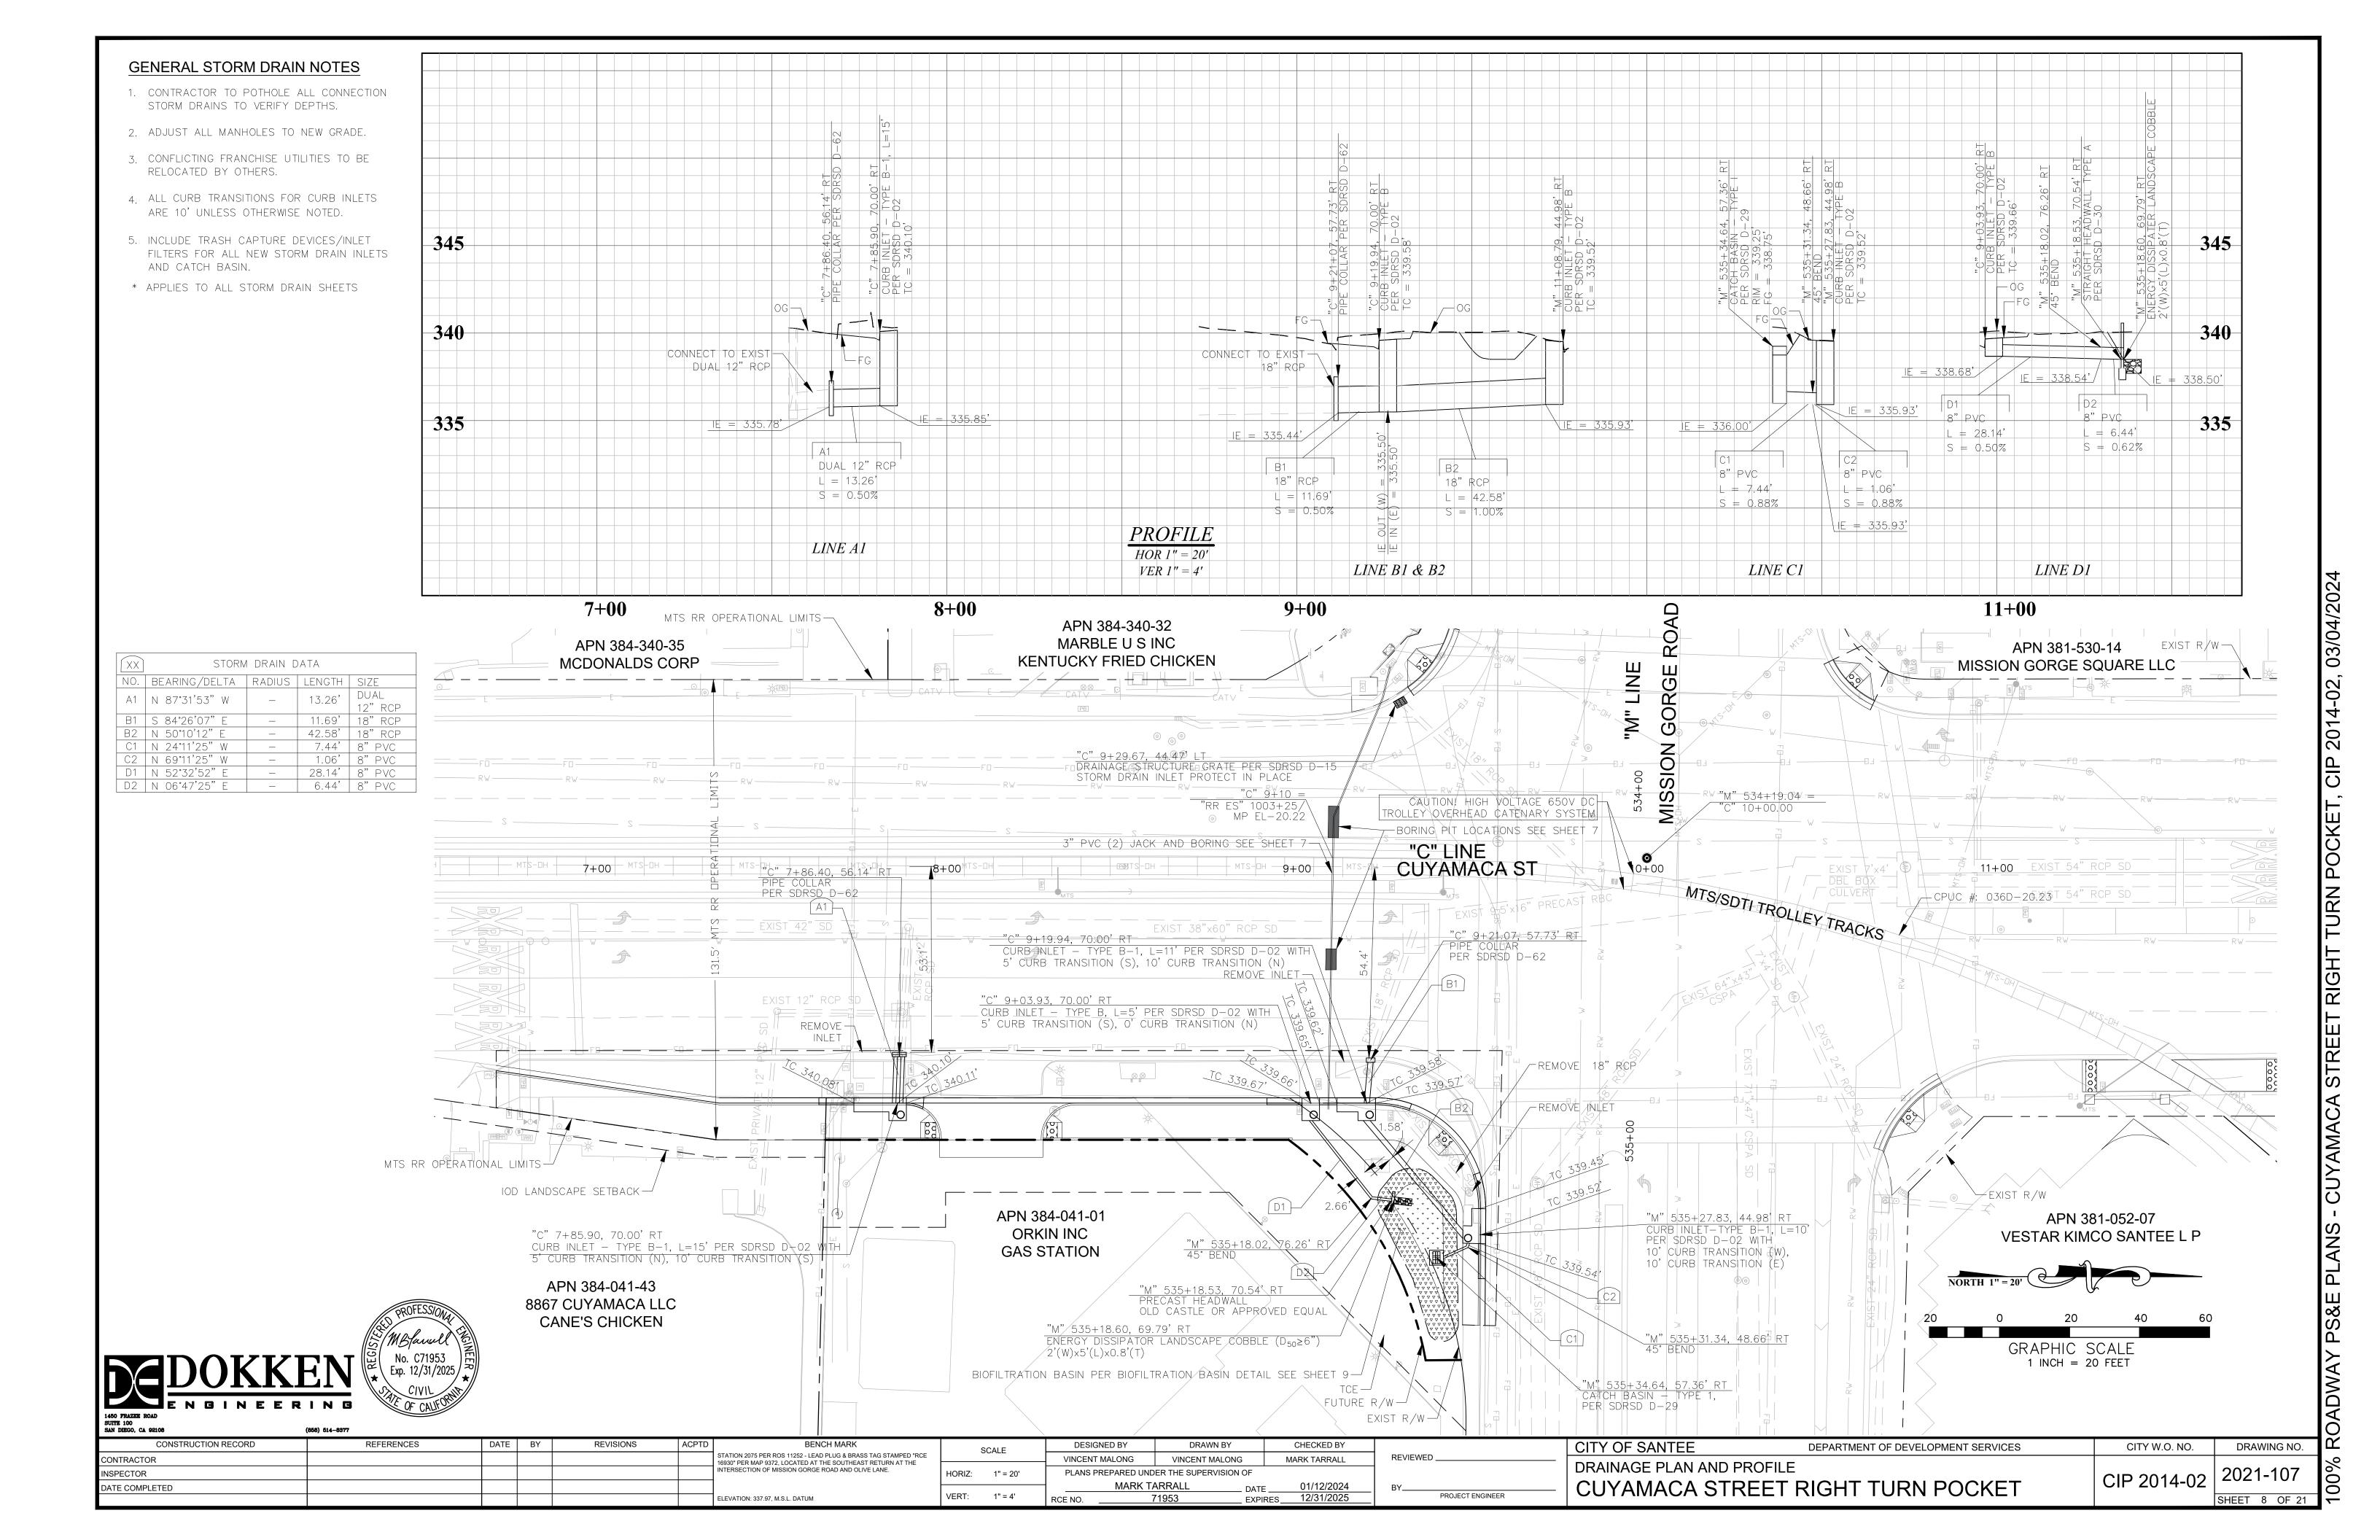



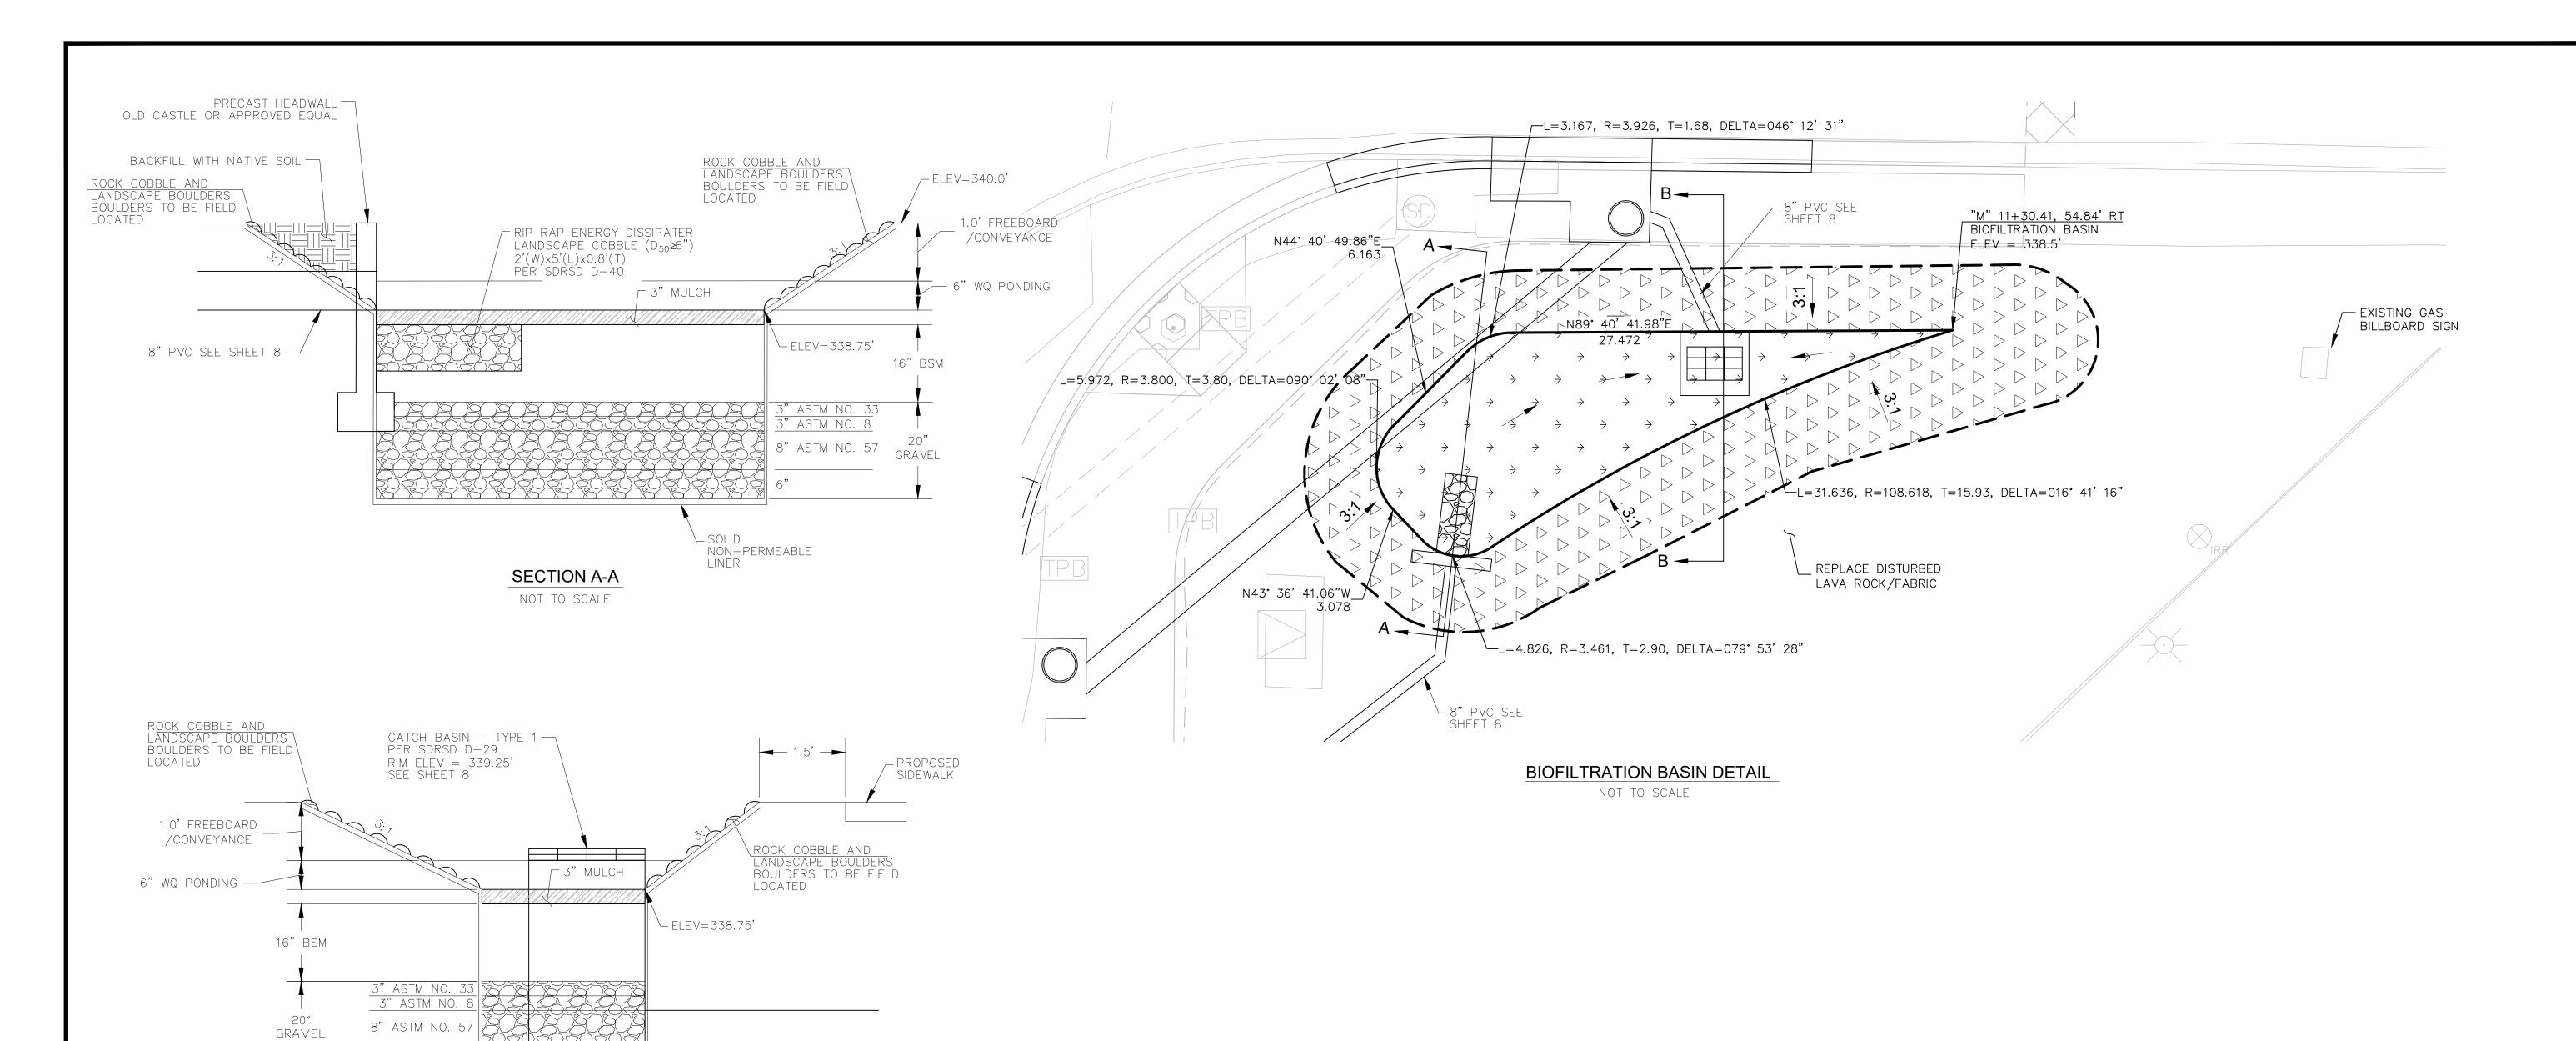

DGDOKKI LAGO FRAZER ROAD SUITE 100 SAN DIEGO, CA 92108	EN I N G (858) 514–8377	PROFESSIONAL PROFESSIONAL No. C71953 Exp. 12/31/2025 CIVIL STATE OF CALFORNIA	


ELEV=336.0'


SECTION B-B


NOT TO SCALE


-8" PVC SEE SHEET 8

CONSTRUCTION RECORD	REFERENCES	DATE BY	REVISIONS	ACPTD	BENCH MARK	SCALE	DESIGNED BY	DRAWN BY	CHECKED BY		CITY OF SANTEE	DEPARTMENT OF DEVELOPMENT SERVICES	CITY W.O. NO.	DRAWING NO.
CONTRACTOR				STATION 16930" PE	2075 PER ROS 11252 - LEAD PLUG & BRASS TAG STAMPED "RCE ER MAP 9372, LOCATED AT THE SOUTHEAST RETURN AT THE		VINCENT MALONG	VINCENT MALONG	MARK TARRALL	REVIEWED				
INSPECTOR				INTERSE	CTION OF MISSION GORGE ROAD AND OLIVE LANE.	HORIZ: N/A		ER THE SUPERVISION OF			DRAINAGE DETAIL		CIP 2014-02	2021-108
DATE COMPLETED							MARK T		TE 01/12/2024	BY	□ CUYAMACA STI	REET RIGHT TURN POCKET	CIP 2014-02	
				ELEVATION	DN: 337.97, M.S.L. DATUM	VERT: N/A	RCE NO.	7 <u>1953 </u>	PIRES 12/31/2025	PROJECT ENGINEER				SHEET 9 OF 21

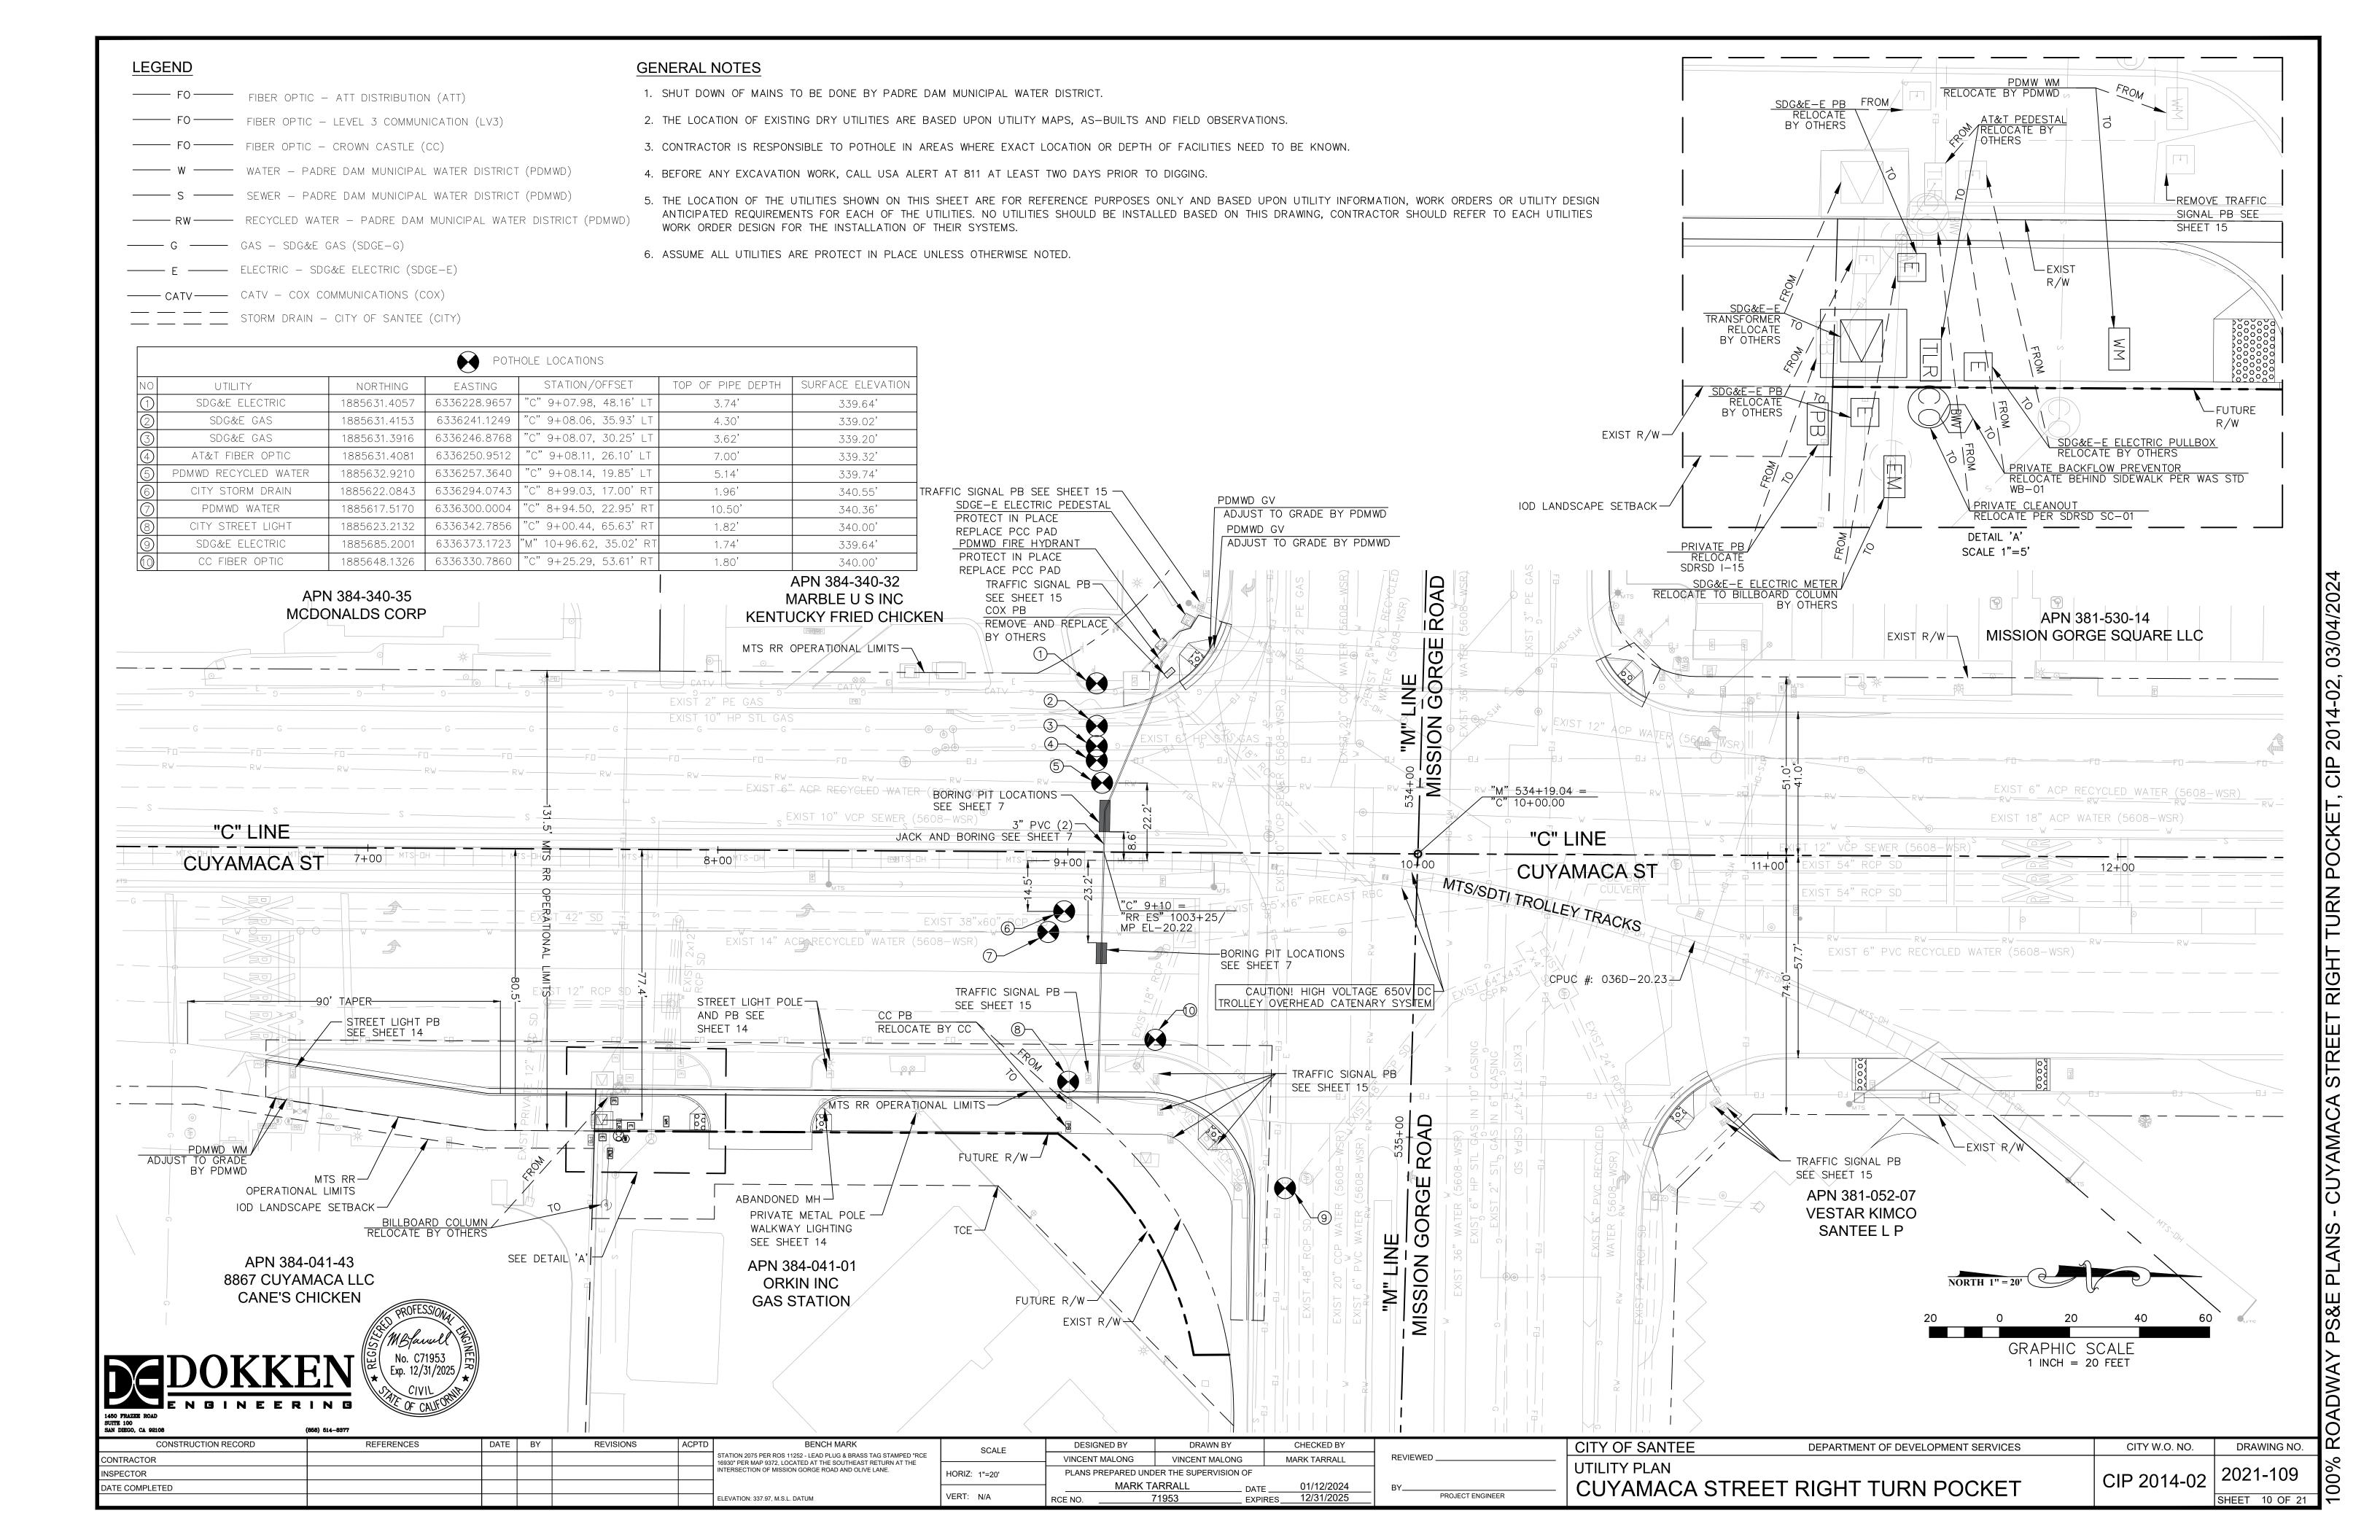

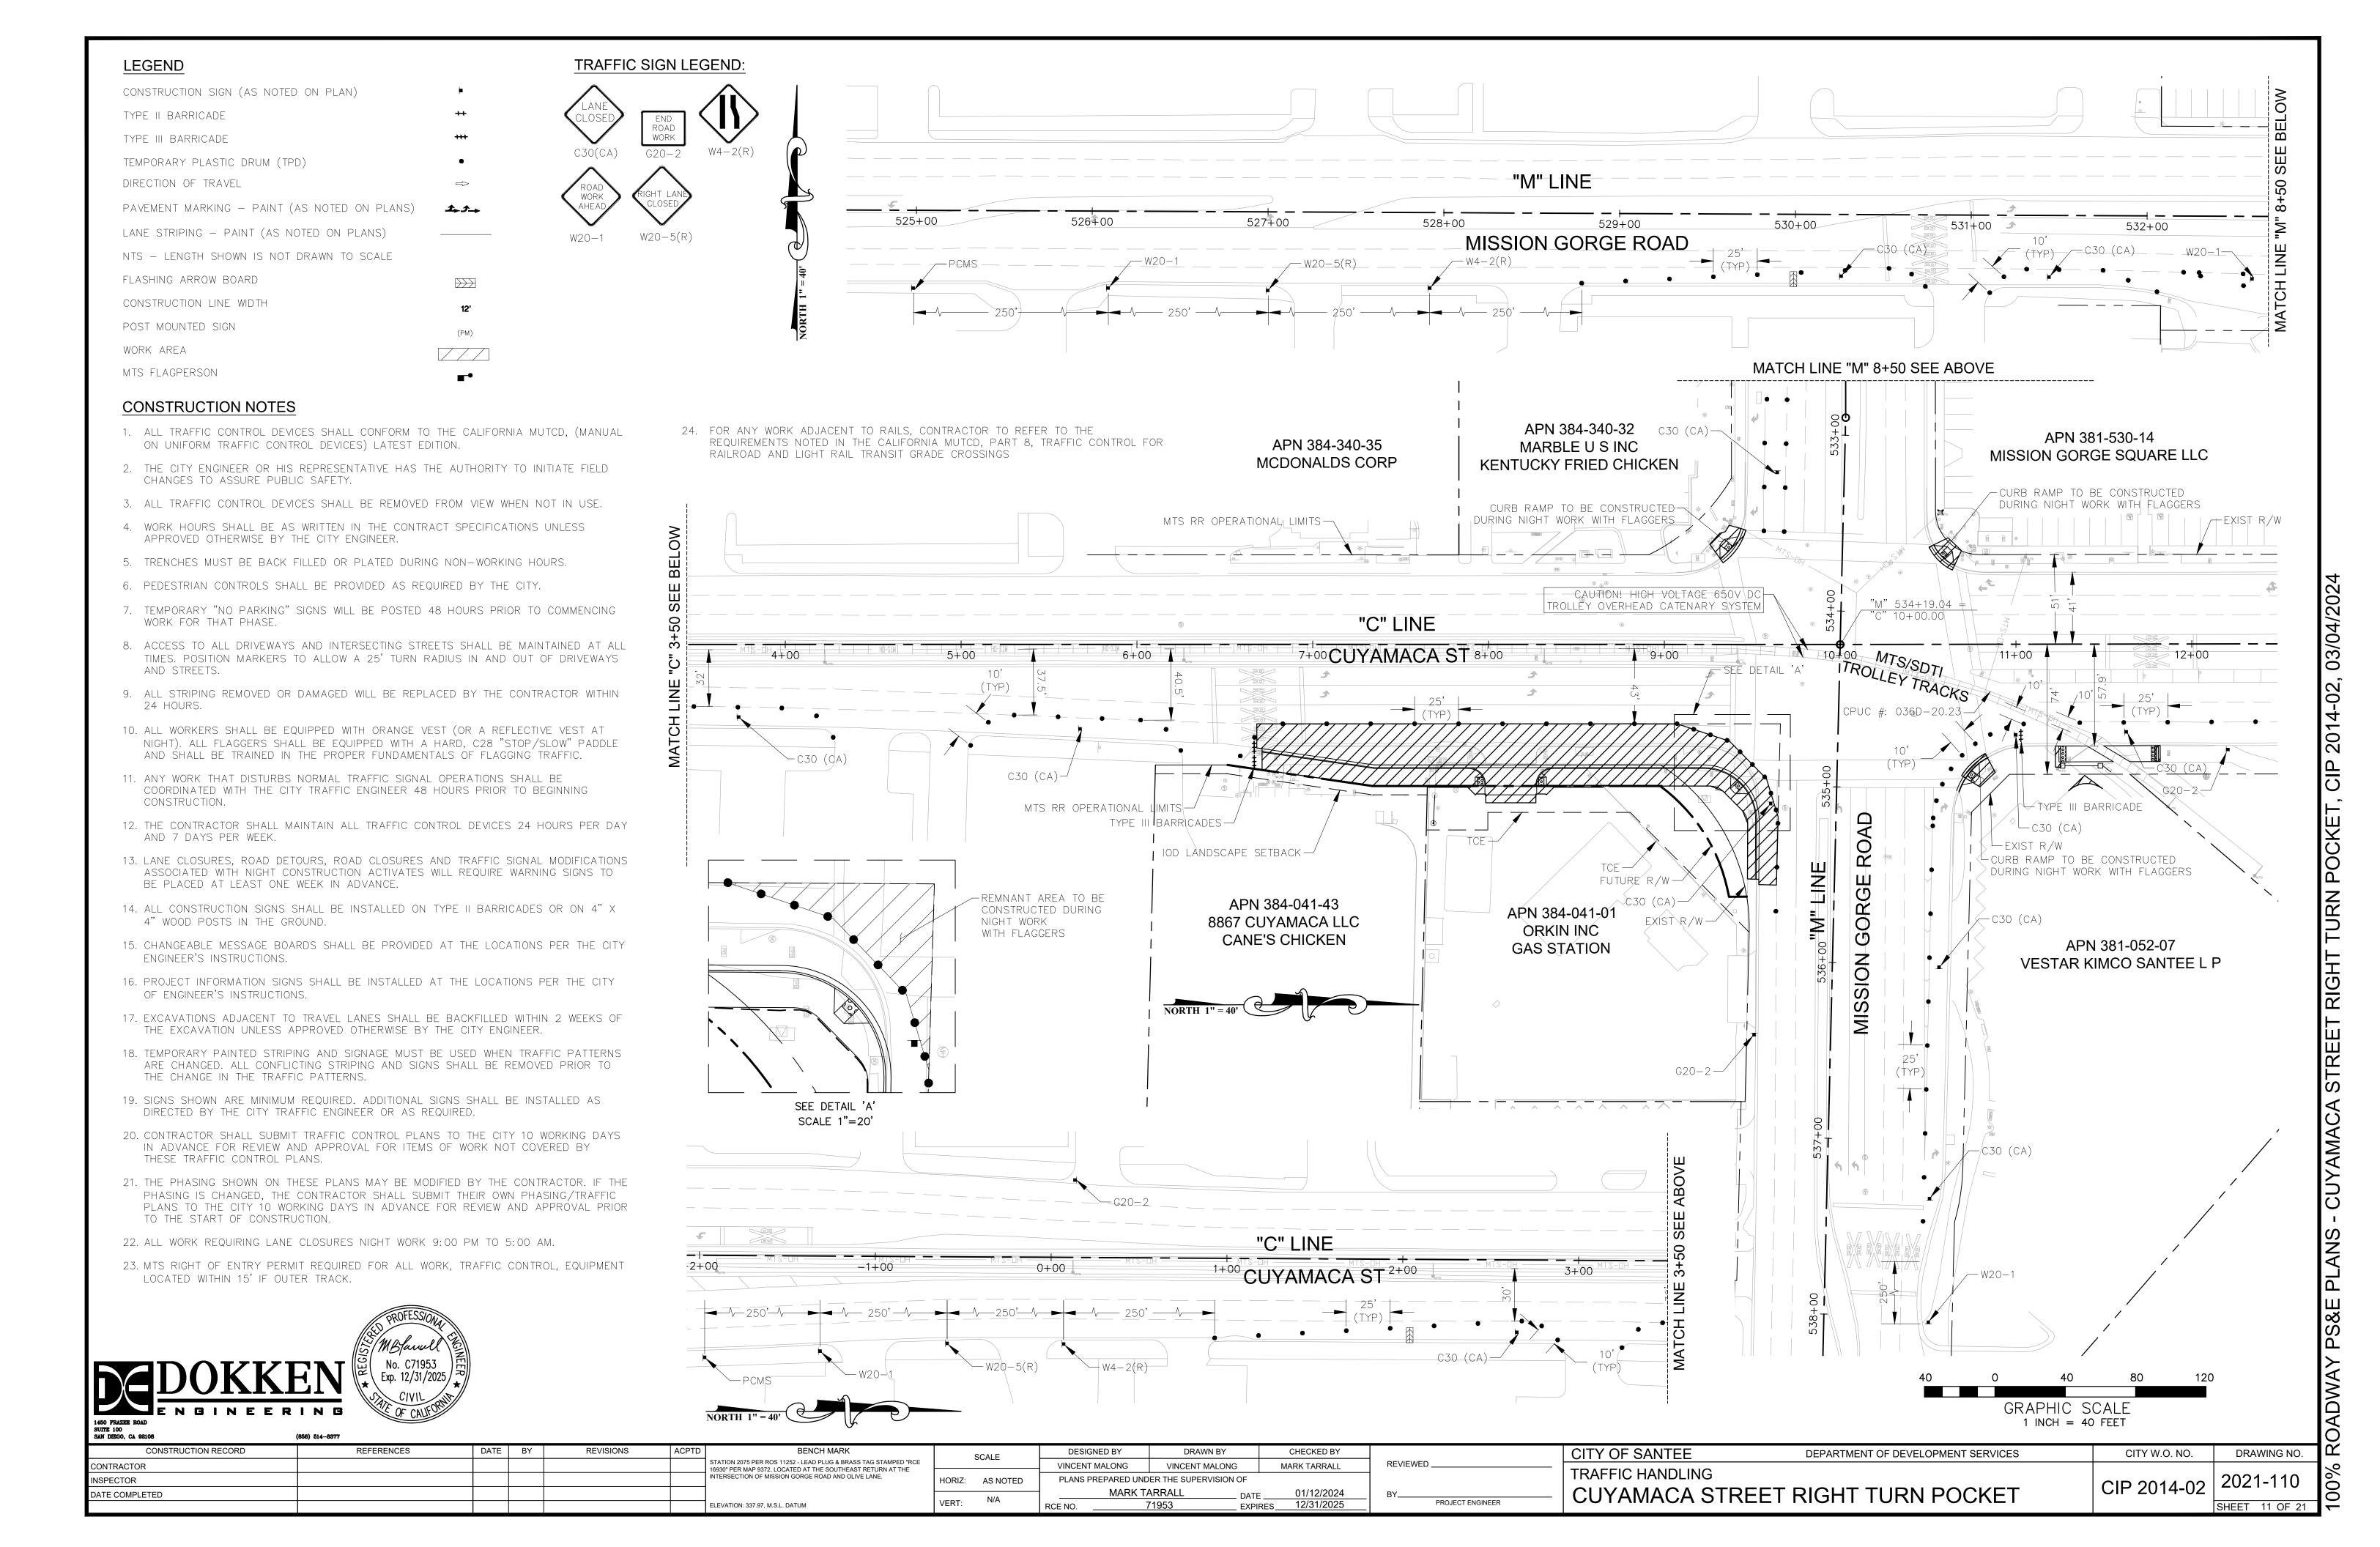

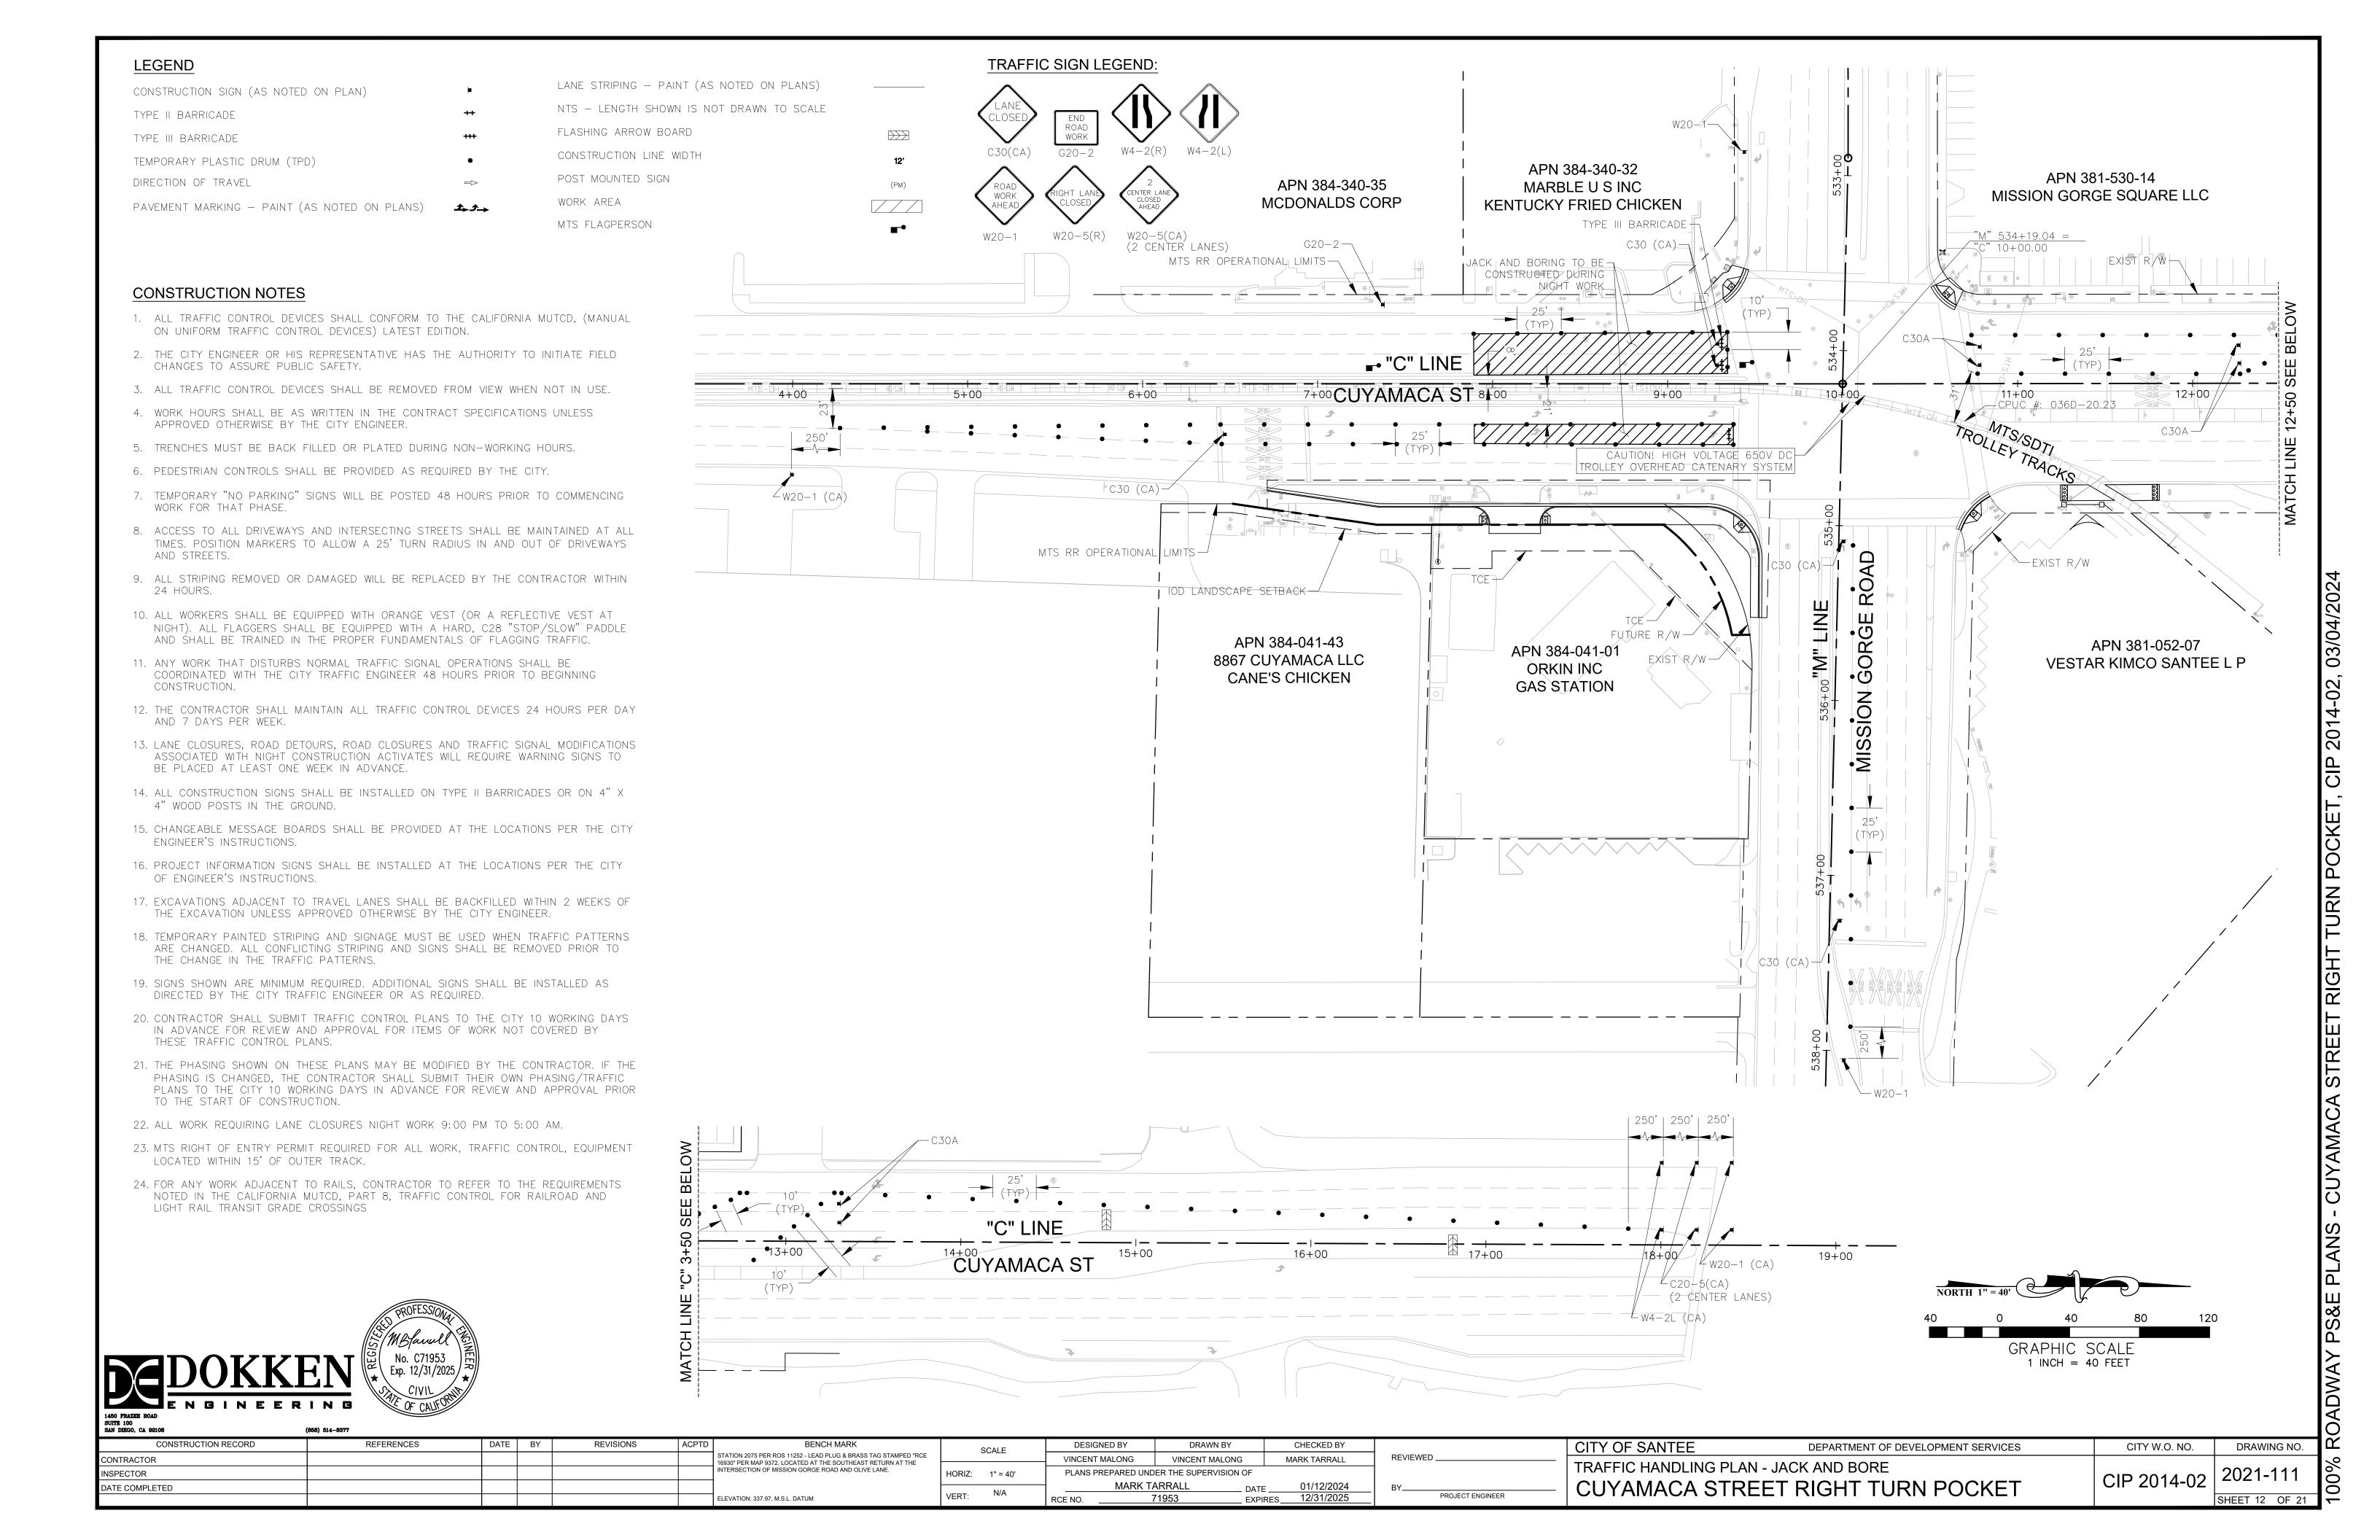

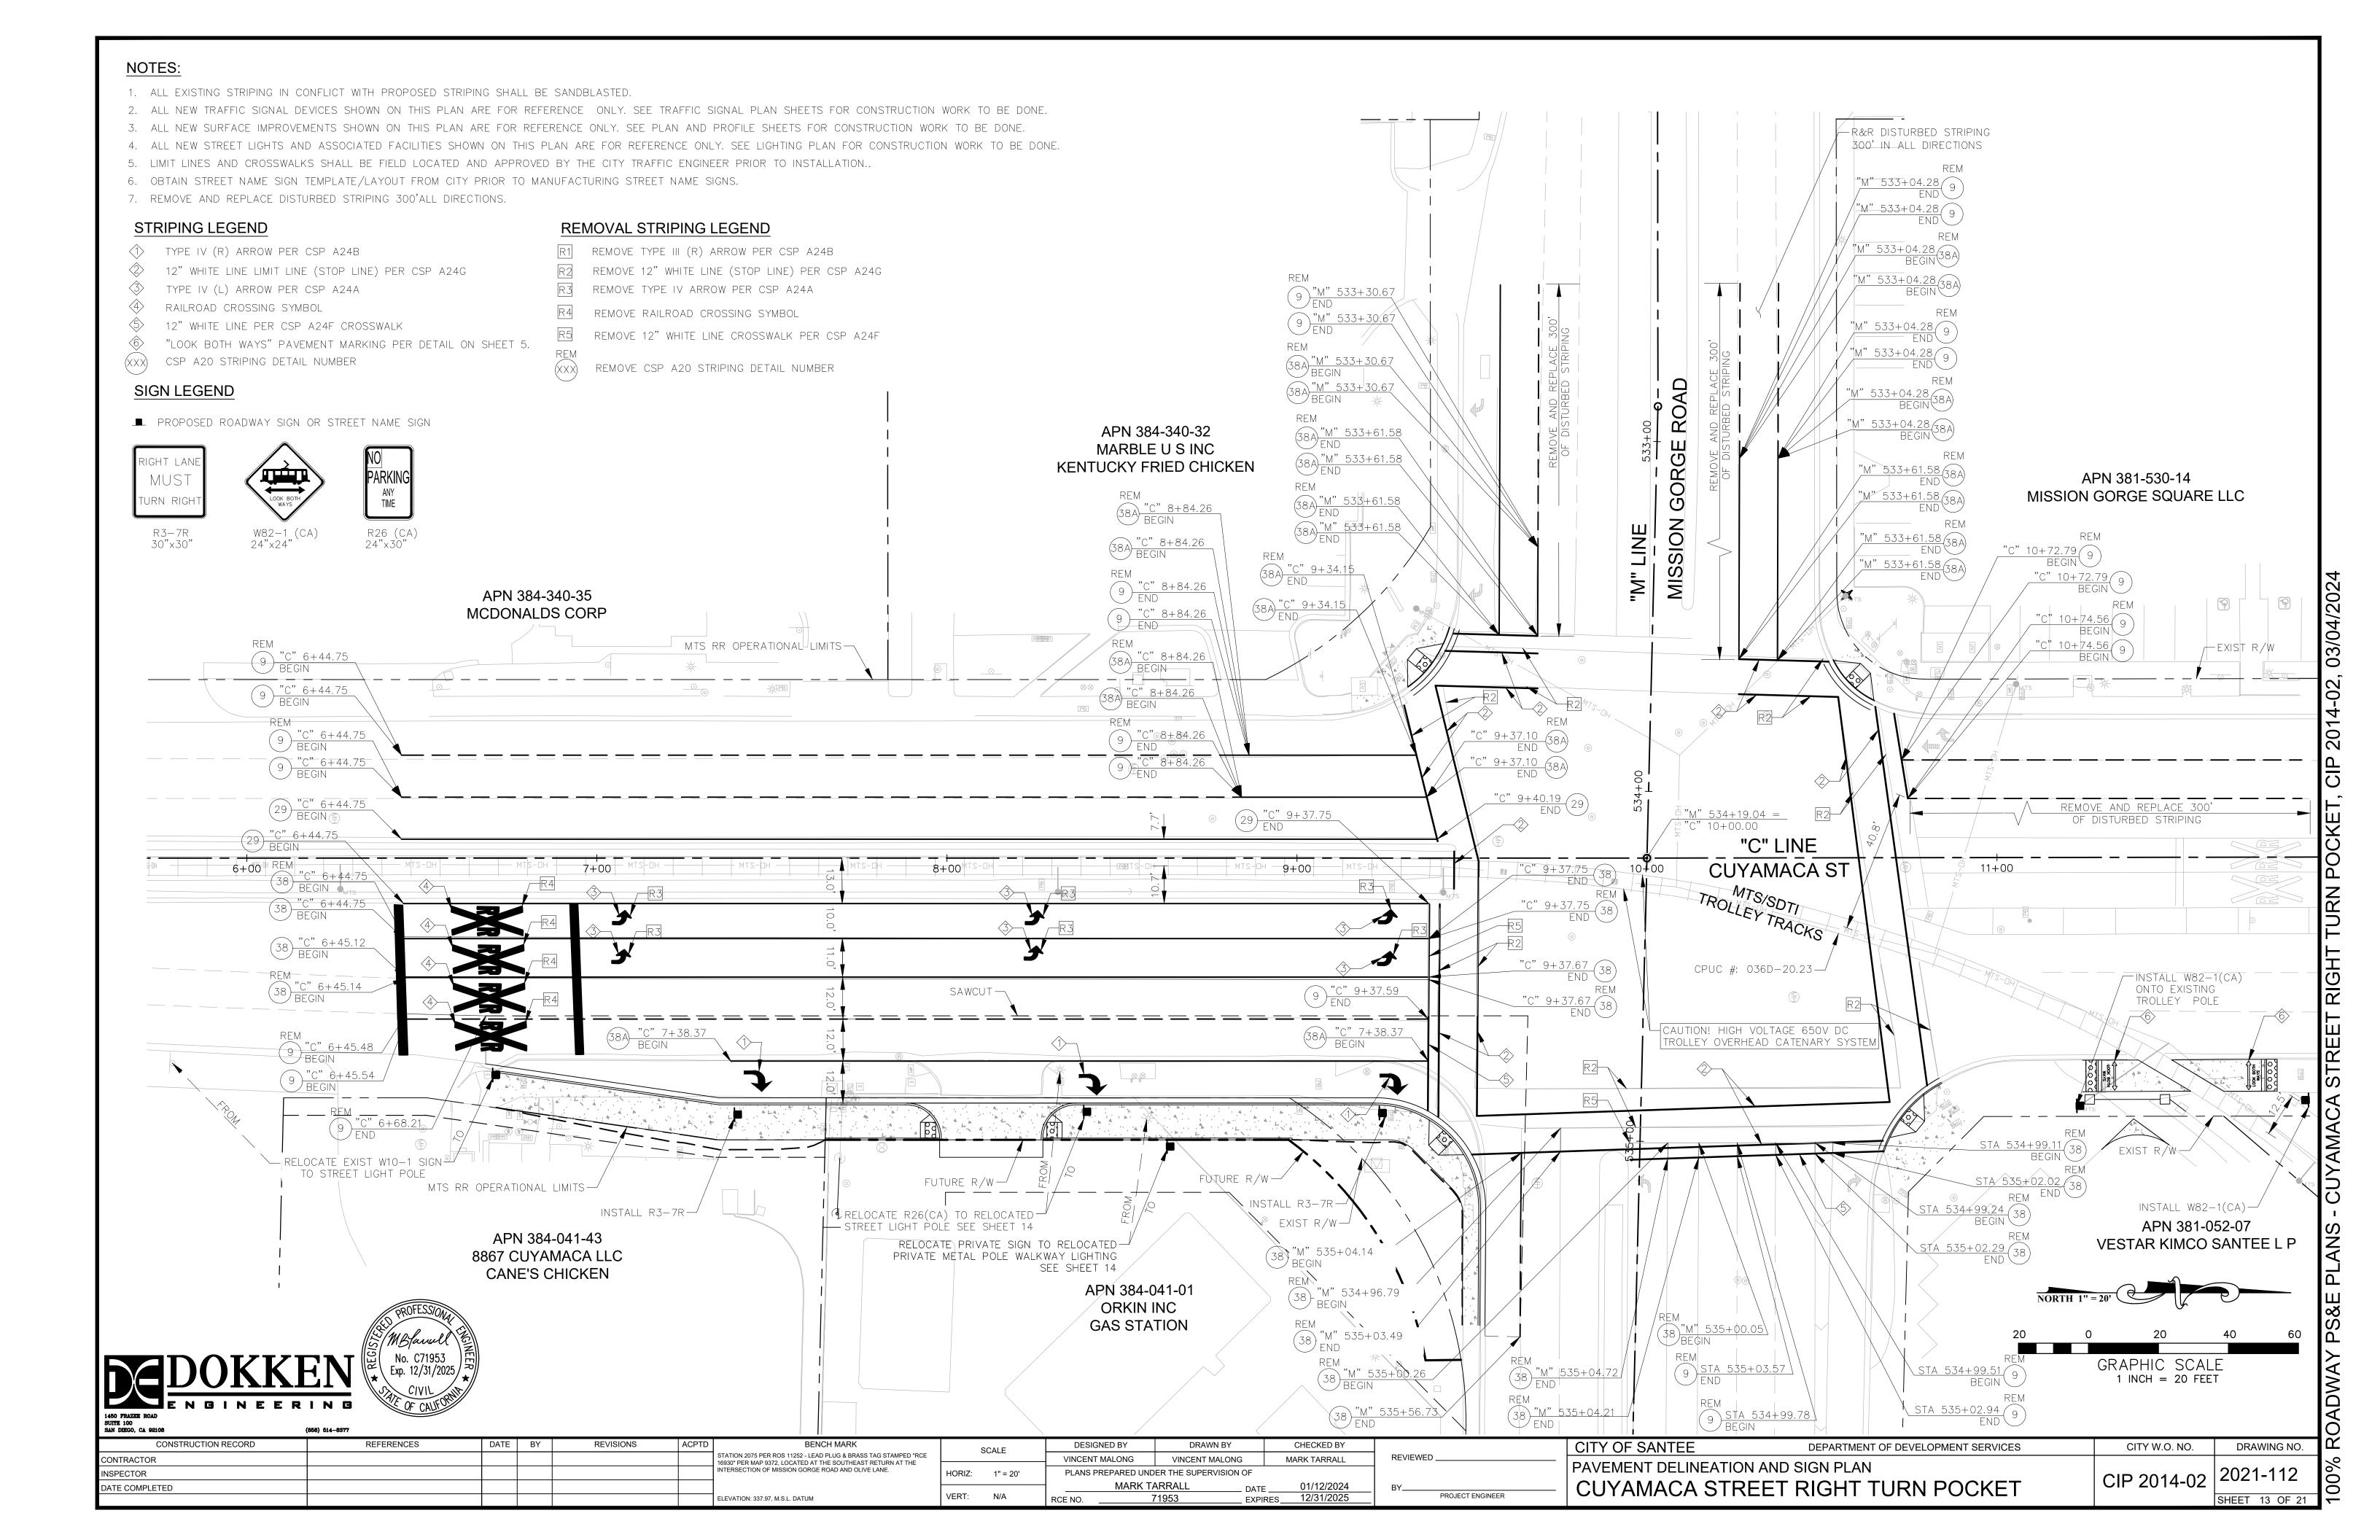

GRAPHIC SCALE
1 INCH = 20 FEET

CONSTRUCTION NOTES

- 1 RELOCATED STREET LIGHT PER SANTEE PW-20.
- 2 RELOCATED WALKWAY LIGHT PER SANTEE PW-17.
- 3 SPLICE EXISTING WALKWAY LIGHTING CONDUCTORS INTO NEW WALKWAY LIGHT LOCATION.

- RL RELOCATE EQUIPMENT.
- SC SPLICE NEW TO EXISTING CONDUTORS


(CB) INSTALL CONDUIT INTO EXISTING PULL BOX

CC CONNECT NEW AND EXISTING CONDUIT. REMOVE EXISTING CONDUCTORS AND INSTALL CONDUCTORS AS INDICATED

RC EQUIPMENT OR MATERIAL TO BE REMOVED SHALL BE REMOVED AND DISPOSED BY THE CONTRACTOR


PB PULL BOX


<u>LEGEND</u>

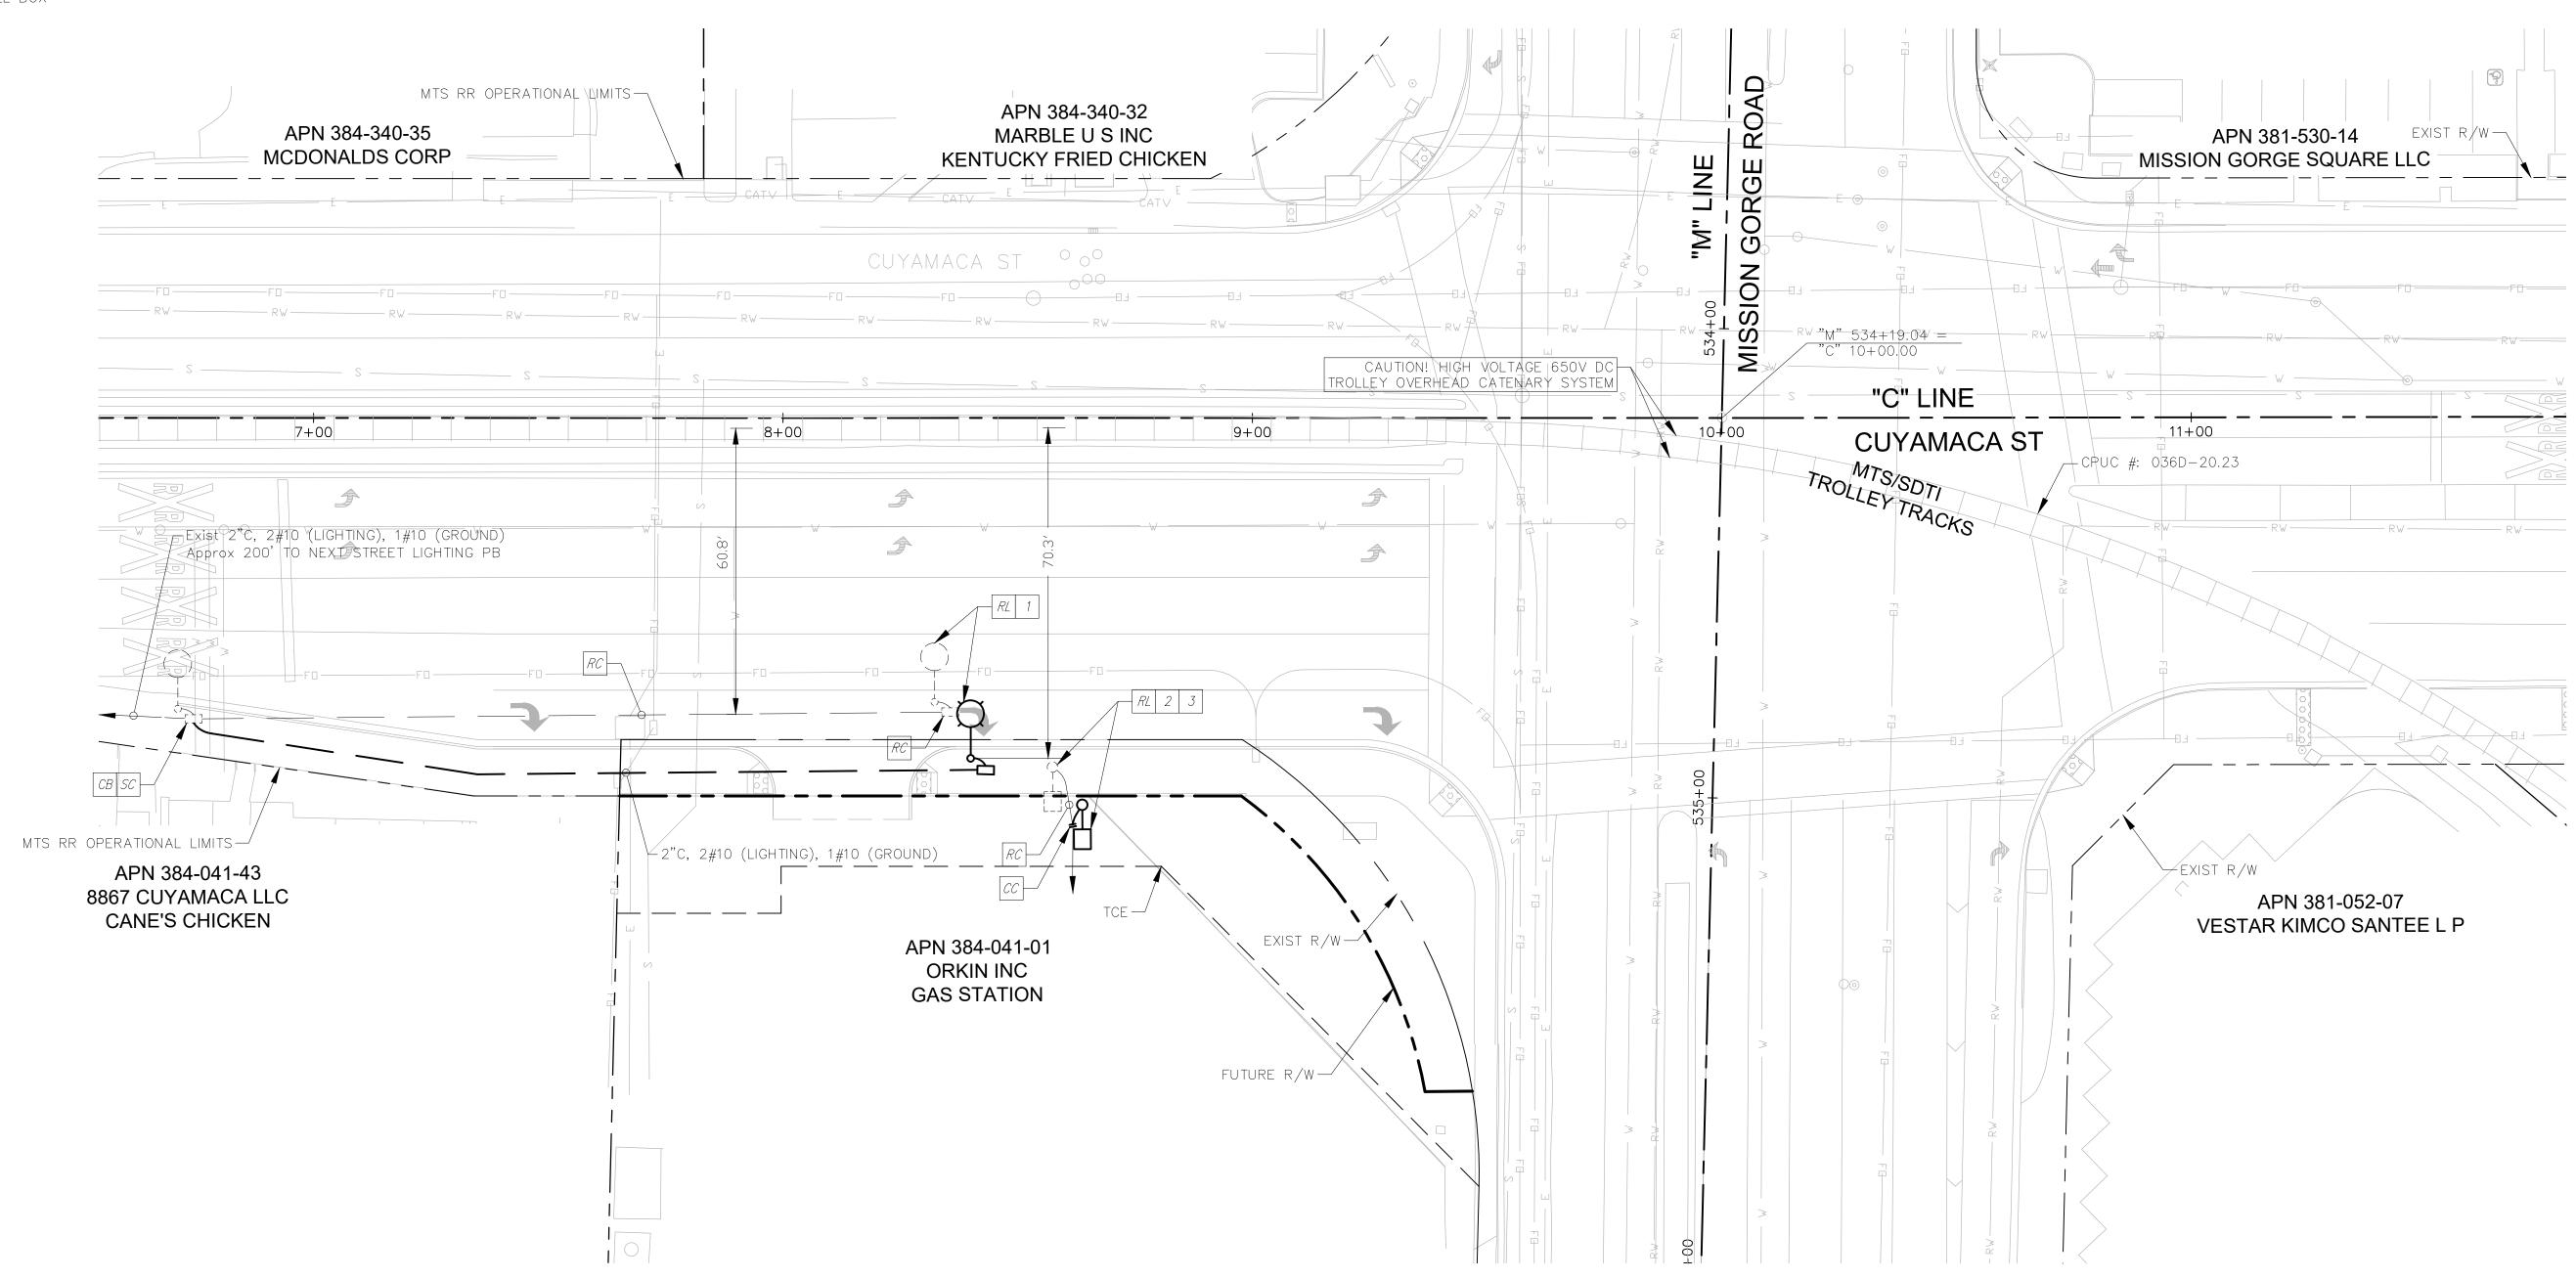



CONSTRUCTION RECORD REFERENCES DATE BY REVISIONS ACPTD	BENCH MARK SCALE SCALE	DESIGNED BY DRAWN BY CHECKED BY		CITY OF SANTEE DEPARTMENT OF DEVELOPMENT SERVICES	CITY W.O. NO. DRAWING NO.
CONTRACTOR	16930" PER MAP 9372, LOCATED AT THE SOUTHEAST RESTAMPED ROE 16930" PER MAP 9372, LOCATED AT THE SOUTHEAST RESTAMPED ROE 16930" PER MAP 9372, LOCATED AT THE SOUTHEAST RESTAMPED ROE 16930" PER MAP 9372, LOCATED AT THE SOUTHEAST RESTAMPED ROE 16930" PER MAP 9372, LOCATED AT THE SOUTHEAST RESTAMPED ROE 16930" PER MAP 9372, LOCATED AT THE SOUTHEAST RESTAMPED ROE 16930" PER MAP 9372, LOCATED AT THE SOUTHEAST RESTAMPED ROE 16930" PER MAP 9372, LOCATED AT THE SOUTHEAST RESTAMPED ROE 16930" PER MAP 9372, LOCATED AT THE SOUTHEAST RESTAMPED ROE 16930" PER MAP 9372, LOCATED AT THE SOUTHEAST RESTAMPED ROE 16930" PER MAP 9372, LOCATED AT THE SOUTHEAST RESTAMPED ROE 16930" PER MAP 9372, LOCATED AT THE SOUTHEAST RESTAMPED ROE 16930" PER MAP 9372, LOCATED AT THE SOUTHEAST RESTAMPED ROE 16930" PER MAP 9372, LOCATED AT THE SOUTHEAST RESTAMPED ROE 16930" PER MAP 9372, LOCATED AT THE SOUTHEAST RESTAMPED ROE 16930" PER MAP 9372, LOCATED ROE 16930" PE	JOSE OSTDIEK JENNIFER KOBRYA JOSE OSTDIEK	REVIEWED	LIGHTING PLAN	0004.440
INSPECTOR "	HORIZ: 1" = 20'	PLANS PREPARED UNDER THE SUPERVISION OF			CIP 2014-02 2021-113
DATE COMPLETED F	FLEVATION: 337 97 M.S.I. DATUM VERT: N/A		BYPROJECT ENGINEER	CUYAMACA STREET RIGHT TURN POCKET	SHEET 14 OF 21
	ELEVITION. SOT.ST, IN.S.E. DATOM	RGE NO EXPIRES			SHEET 14 OF 21

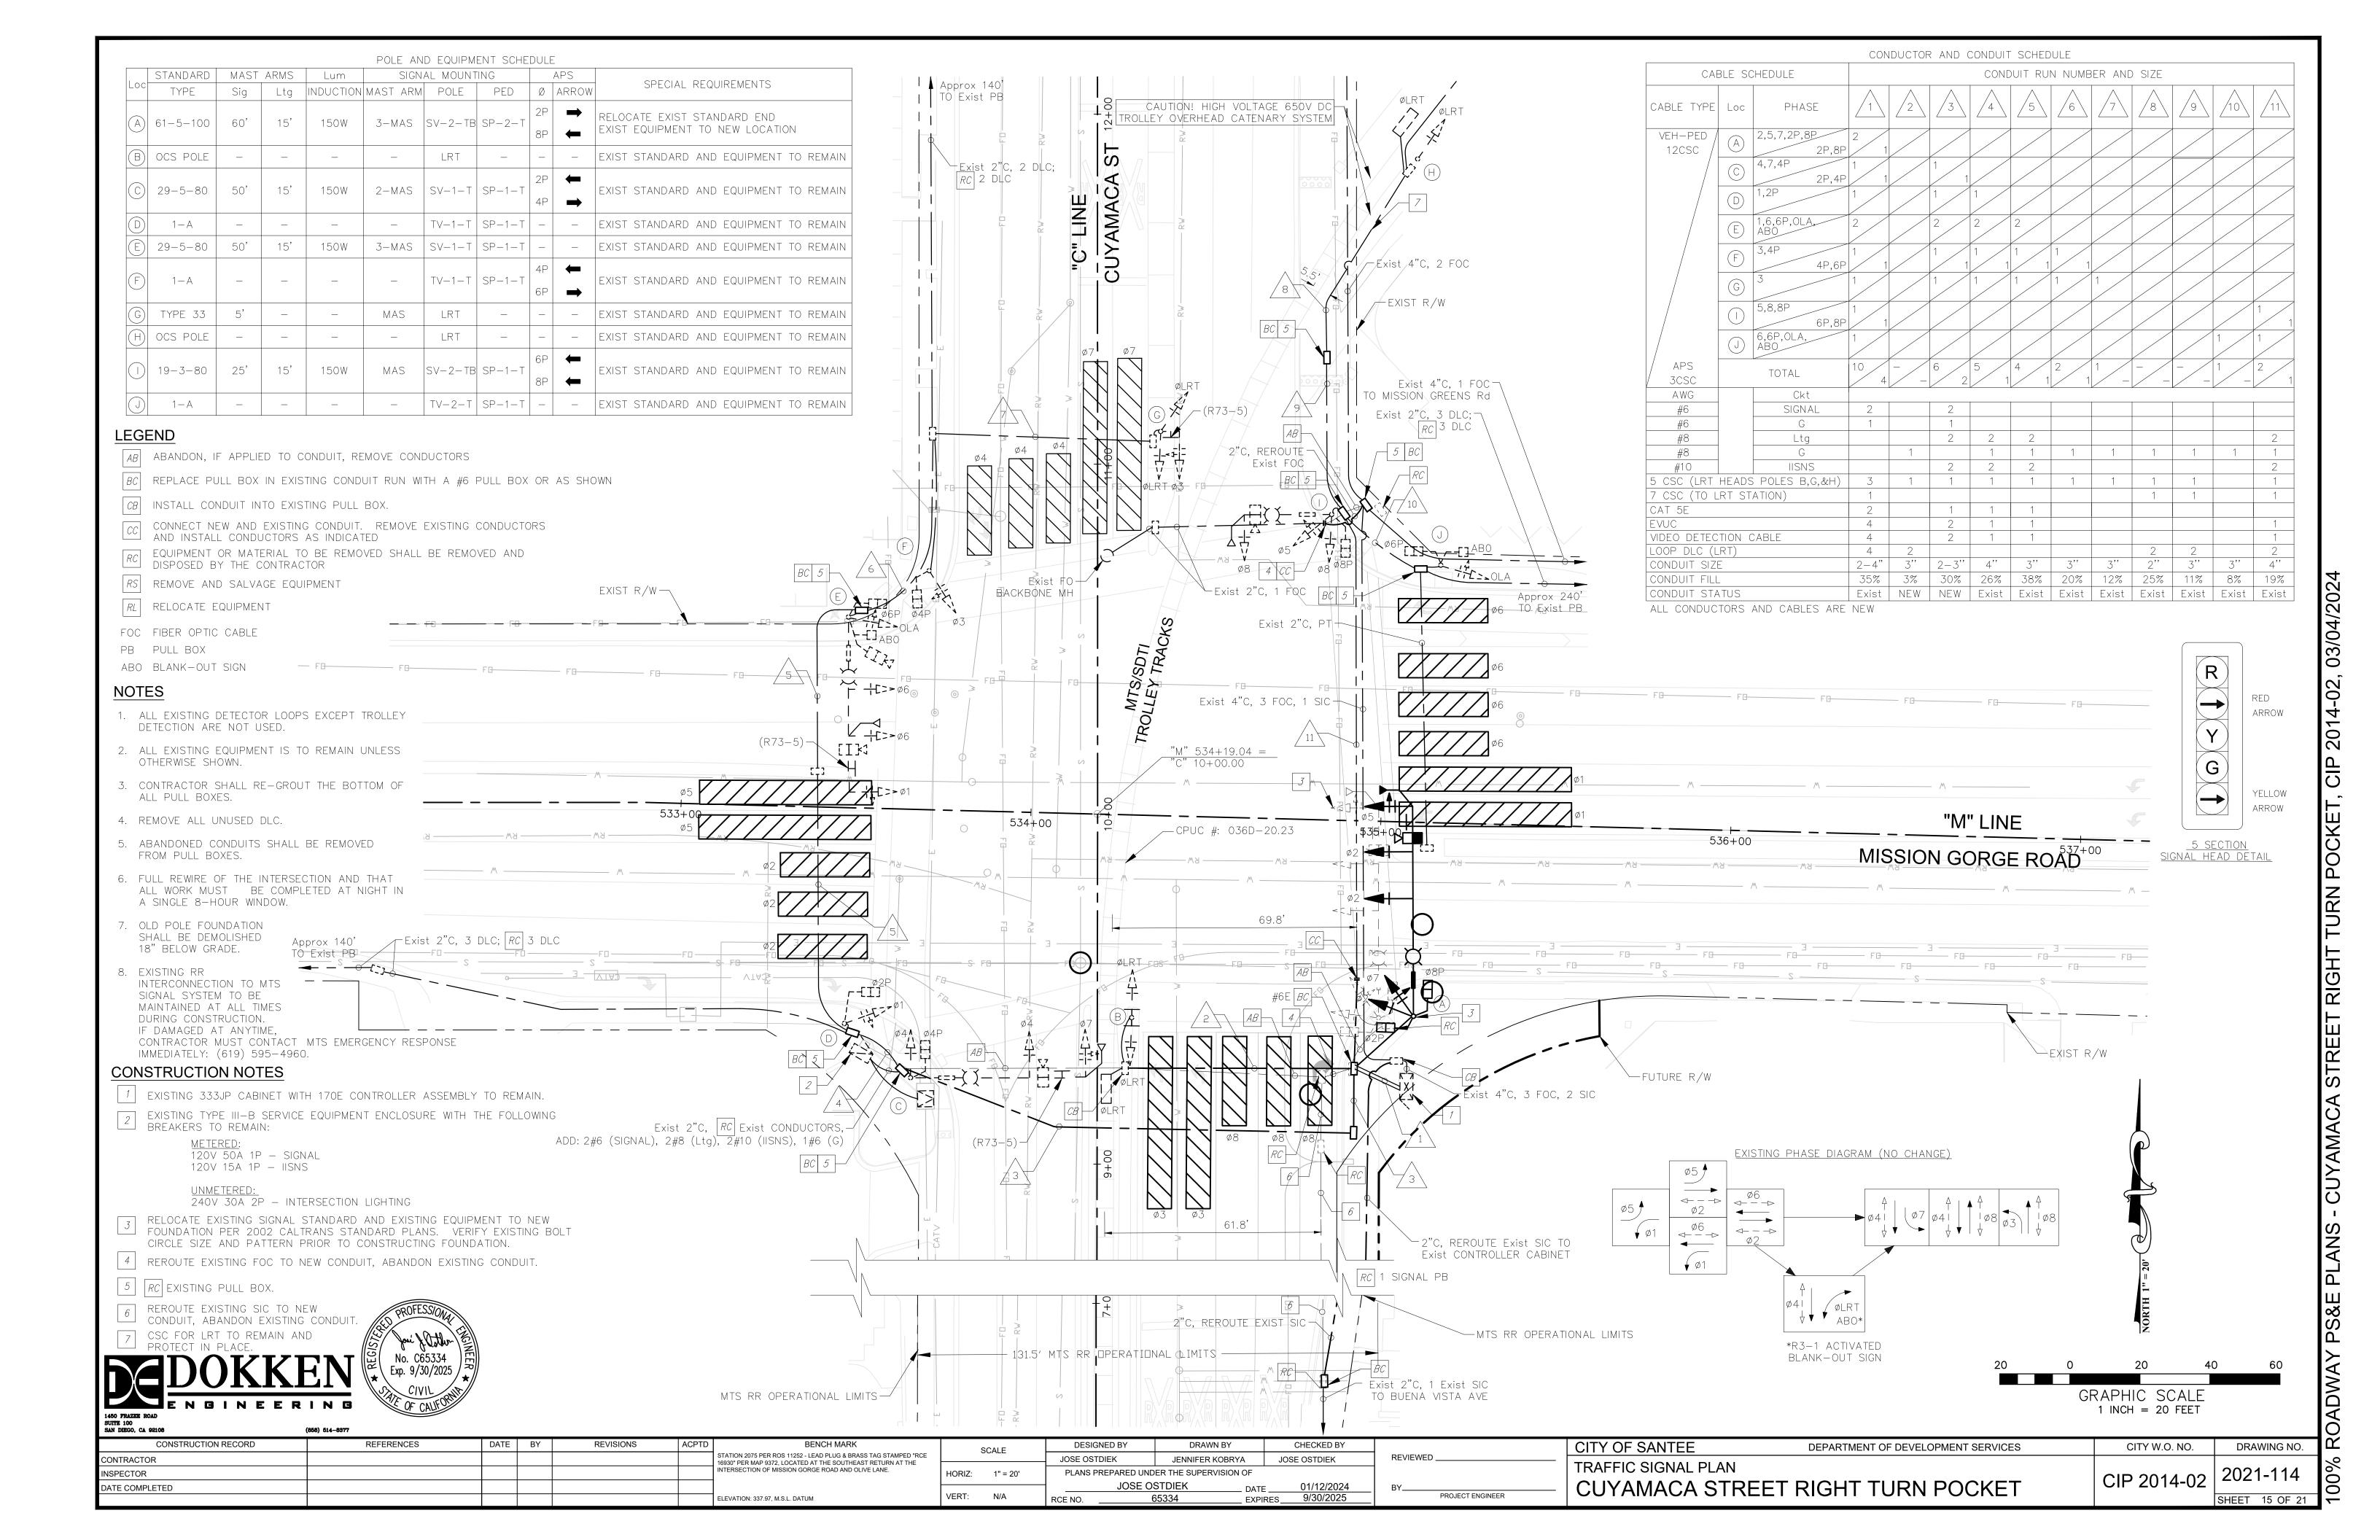

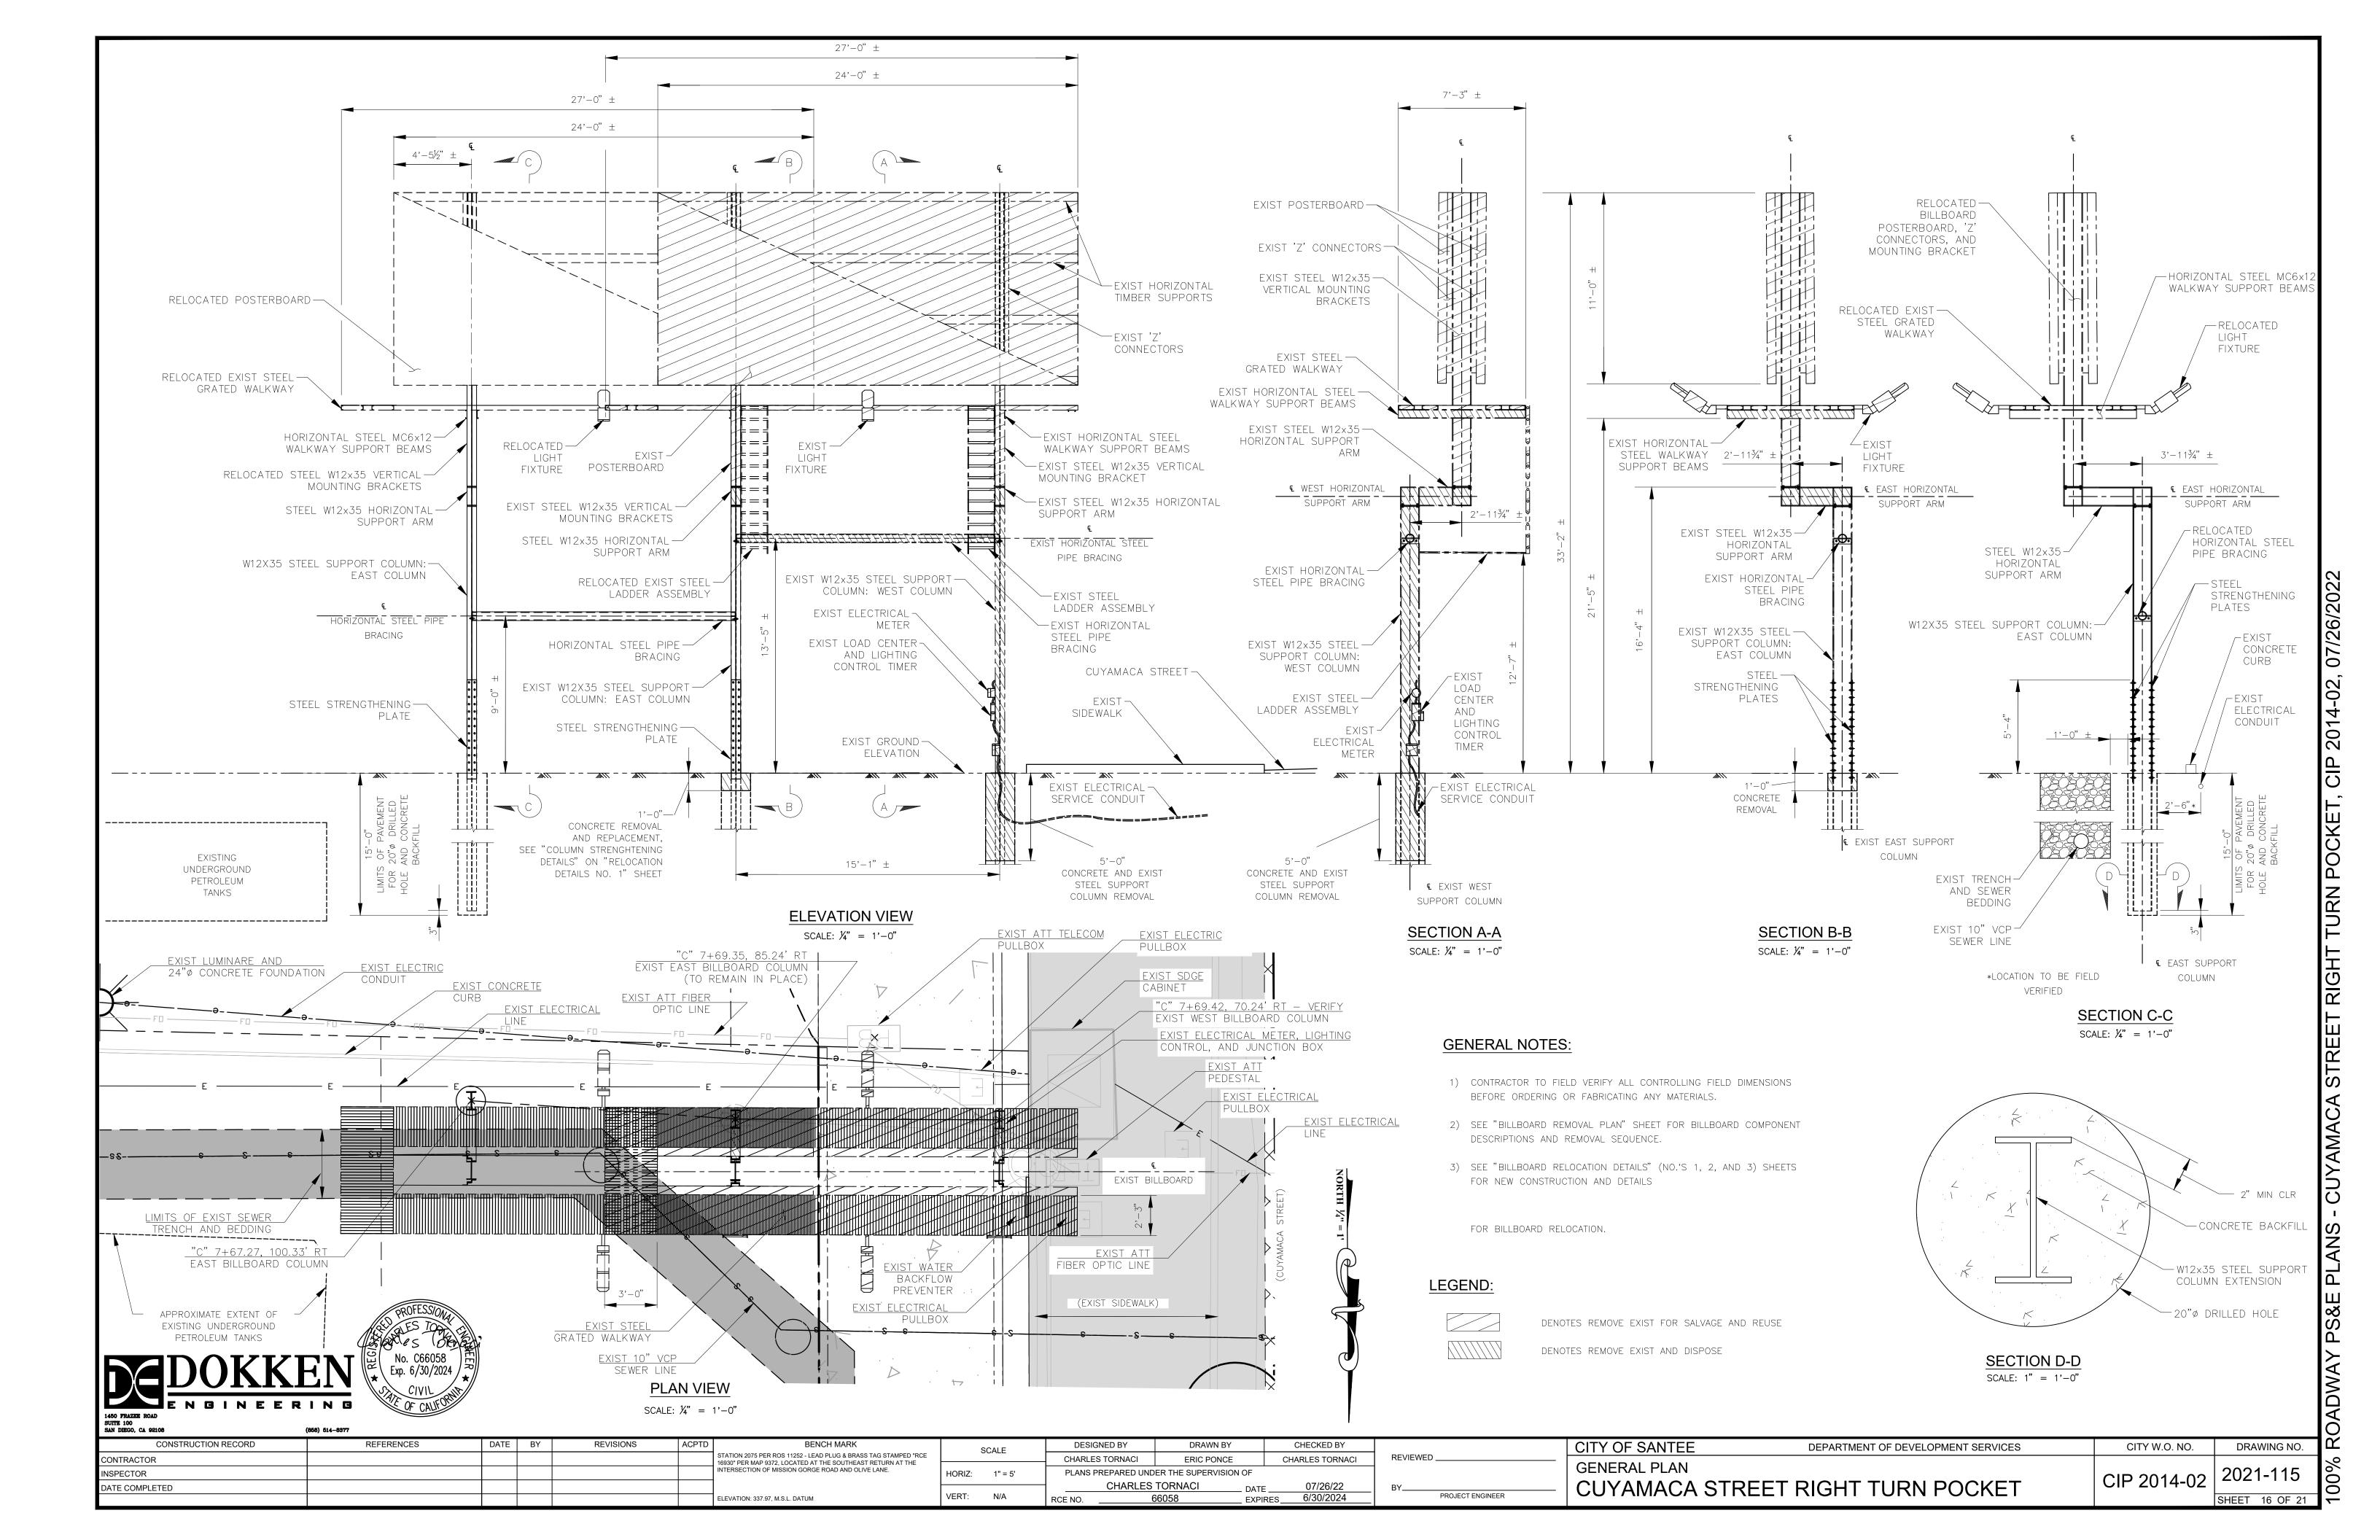

STRUCTURE NOTES:

SUBMITTALS

- 1. PRIOR TO REMOVING ANY PORTION OF THE EXISTING BILLBOARD OR SUPPORT STRUCTURE, THE CONTRACTOR SHALL SUBMIT A DEMOLITION PLAN IN CONFORMANCE WITH SECTION 2-5.3, "SUBMITTALS," OF THE STANDARD SPECIFICATIONS. THE DEMOLITION PLAN SHALL INCLUDE DETAILS FOR THE FOLLOWING:
 - a. REMOVAL SEQUENCE, INCLUDING STAGING OF REMOVAL ACTIVITIES AND EQUIPMENT
 - b. TEMPORARY SUPPORT SHORING OR BRACING
 - c. LOCATIONS WHERE WORK IS PERFORMED NEAR TRAFFIC OR UTILITIES
 - d. PROTECTION OF PEOPLE, PROPERTY, UTILITIES, AND IMPROVEMENTS
 - e. METHODS FOR PREVENTING MATERIAL, EQUIPMENT, AND DEBRIS FROM FALLING ONTO
- 2. PRIOR TO PROCUREMENT OR FABRICATION OF ANY STRUCTURAL STEEL, THE CONTRACTOR SHALL SUBMIT SHOP DRAWINGS IN CONFORMANCE WITH SECTION 304-1.1.1, "SHOP DRAWINGS," OF THE STANDARD SPECIFICATIONS.
- 3. PRIOR TO ERECTION OF STRUCTURAL STEEL OR RECONSTRUCTION OF ANY PORTION OF THE BILLBOARD OR SUPPORT STRUCTURE, THE CONTRACTOR SHALL SUBMIT AN ERECTION PLAN IN CONFORMANCE WITH SECTIONS 2-5.3, "SUBMITTALS," AND 304-1.1.2, "FALSEWORK PLANS," OF THE STANDARD SPECIFICATIONS. THE ERECTION PLAN SHALL INCLUDE DETAILS FOR THE FOLLOWING:
 - a. METHODS AND EQUIPMENT IN ACCORDANCE WITH SECTION 304-1.2, "METHODS AND EQUIPMENT," OF THE STANDARD SPECIFICATIONS
 - b. ERECTION SEQUENCE, INCLUDING STAGING OF MATERIALS AND EQUIPMENT LOCATIONS
 - c. TEMPORARY SUPPORT SHORING OR BRACING, IF REQUIRED
 - d. LOCATIONS WHERE WORK IS PERFORMED NEAR TRAFFIC OR UTILITIES e. PROTECTION OF PEOPLE, PROPERTY, UTILITIES, AND IMPROVEMENTS
 - e. PROTECTION OF PEOPLE, PROPERTY, UTILITIES, AND IMPROVEMENTS
 - f. METHODS FOR PREVENTING MATERIAL, EQUIPMENT, AND DEBRIS FROM FALLING ONTO TRAFFIC.

CONSTRUCTION NOTES:

- 1. ALL MATERIALS SHOWN ON THE PLANS TO BE REMOVED AND DISPOSED OF SHALL BE DISPOSED OFF SITE IN ACCORDANCE WITH SECTION 300-1.3, "REMOVAL AND DISPOSAL OF MATERIALS," OF THE STANDARD SPECIFICATIONS.
- 2. PRIOR TO DRILLING HOLES FOR BILLBOARD FOUNDATIONS, LOCATE ALL UTILITIES WITHIN 10 FEET OF THE PROPOSED HOLE.
- 3. DRILLED HOLES FOR BILLBOARD COLUMN FOUNDATIONS SHALL CONFORM WITH SECTIONS 205-3, "CONCRETE PILES," 205-3.3.2, 'PILES CAST IN DRILLED HOLES," AND 305-1.3.2, "DRILLED HOLES FOR CAST-IN-PLACE PILES," OF THE STANDARD SPECIFICATIONS.
- 4. REINFORCING STEEL FOR DRILL AND GROUT DOWELS SHALL BE GRADE 60 AND SHALL CONFORM WITH SECTION 201-2, "REINFORCEMENT FOR CONCRETE," OF THE STANDARD SPECIFICATIONS.
- 5. CONCRETE FOR BILLBOARD FOUNDATIONS SHALL BE CONSIDERED SPECIFIED BY CLASS, AS DEFINED IN SECTION 201-1.1.2, "CONCRETE SPECIFIED BY CLASS AND ALTERNATE CLASS," OF THE STANDARD SPECIFICATIONS, AND SHALL CONCRETE AS SPECIFIED FOR "CAST-IN-PLACE PILES" IN TABLE 201-1.1.2 OF THE STANDARD SPECIFICATIONS.
- 6. AT CONSTRUCTION JOINT BETWEEN EXISTING AND NEW CONCRETE IN EXISTING EAST COLUMN FOUNDATION, ROUGHEN SURFACE TO AN AMPLITUDE OF 1/4-INCH. PREPARE CONSTRUCTION JOINT IN ACCORDANCE WITH SECTION 303-1.8.6, "JOINTS," OF THE STANDARD SPECIFICATIONS.
- 7. ALL NEW STEEL FOR RECONSTRUCTION OF THE BILLBOARD SHALL BE CONSIDERED "STRUCTURAL STEEL" IN ACCORDANCE WITH SECTIONS 206-1, "STRUCTURAL STEEL, RIVETS, BOLTS, PINS AND ANCHOR BOLTS," AND 304-1, "STRUCTURAL STEEL," OF THE STANDARD SPECIFICATIONS AND SHALL CONFORM TO ALL REQUIREMENTS THEREIN.
- 8. STRUCTURAL STEEL PLATES AND ROLLED SHAPES SHALL CONFORM TO ASTM A709 GR 50. ROUND HOLLOW STRUCTURAL SECTIONS SHALL CONFORM TO ASTM A500, GRADE B OR C.
- 9. ALL NEW STRUCTURAL STEEL FOR RECONSTRUCTION OF THE BILLBOARD SHALL BE HOT-DIP GALVANIZED AFTER FABRICATION IN ACCORDANCE WITH SECTION 210-3, "GALVANIZING," OF THE STANDARD SPECIFICATIONS. REPAIR OF DAMAGED AREAS OF GALVANIZING, AND GALVANIZING OF EXISTING STEEL SURFACES WHERE SHOWN ON THE PLANS, SHALL CONFORM TO SECTION 210-3.5, "REPAIR OF DAMAGED ZINC COATINGS," OF THE STANDARD SPECIFICATIONS.
- 10. DRILL AND GROUT DOWELS SHALL CONFORM TO SECTIONS 51-1.02G, "GROUT," AND 51-1.03E(4), "DRILL AND GROUT DOWELS," OF THE STATE OF CALIFORNIA STANDARD SPECIFICATIONS, 2018. CURE GROUT USING CURING COMPOUND OR WATER CURING METHOD IN ACCORDANCE WITH SECTION 303-1.10, "CURING," OF THE STANDARD SPECIFICATIONS.
- 11. NEW ELECTRICAL CONDUIT SHALL BE CONFORM WITH SECTION 700-3.5.2, "RIGID METALLIC CONDUIT," OF THE STANDARD SPECIFICATIONS.

GENERAL NOTES:

- 1. CONTRACTOR TO FIELD VERIFY ALL CONTROLLING FIELD DIMENSIONS BEFORE ORDERING OR FABRICATING ANY MATERIALS.
- 2. SEE "BILLBOARD REMOVAL PLAN" SHEET FOR BILLBOARD COMPONENT DESCRIPTIONS AND REMOVAL SEQUENCE
- 3.SEE"BILLBOARD RELOCATION DETAILS" (NO.'S 1,2 AND 3) SHEETS FOR NEW CONSTRUCTION AND DETAILS FOR BILLBOARD RELOCATION.

GENERAL NOTES LOAD AND RESISTANCE FACTOR DESIGN

DESIGN:

AASHTO LFRD LTS (SPECIFICATIONS FOR STRUCTURAL SUPPORTS FOR HIGHWAY SIGNS, LUMINIARES, AND TRAFFIC SIGNALS), 1ST EDITION DATED 2015 WITH 2017, 2018, 2019, AND 2020 INTERIM REVISIONS

DEAD LOAD:

SELF-WIRGHT OF STRUCTURAL STEEL AND ATTACHED APPURTENANCES

WIND LOAD:

AASHTO LFRD LTS (SPECIFICATIONS FOR STRUCTURAL SUPPORTS FOR HIGHWAY SIGNS, LUMINIARES, AND TRAFFIC SIGNALS), 1ST EDITION

VEXTREME = 110 MPH

VSERVICE = 72 MPH

LIVE LOAD:

WALKWAY LIVE LOADING OF 500LBS POINT LOAD

CONCRETE BACKFILL:

F'C = 3.6 KSI

FY = 60 KSI

N = 8 STRUCTURAL STEEL:

STM A709 GRADE 50 FY = 50 KSI

FU = 65 KSI

WELDS:

AWS D1.5

HIGH STRENGTH BOLTS:

ASTM A325 HIGH STRENGTH BOLTS:


FY = 58 KSI

FU = 81 KSI



SAN DIEGO, CA 92108	(858) 514-8377														
CONSTRUCTION RECORD	REFERENCES	DATE	BY	REVISIONS	ACPTD	BENCH MARK	SCALE	DESIGNED BY	DRAWN BY	CHECKED BY		CITY OF SANTEE	DEPARTMENT OF DEVELOPMENT SERVICES	CITY W.O. NO.	DRAWING NO.
CONTRACTOR						STATION 2075 PER ROS 11252 - LEAD PLUG & BRASS TAG STAMPED "RCE 16930" PER MAP 9372, LOCATED AT THE SOUTHEAST RETURN AT THE	SCALE	CHARLES TORNACI	ERIC PONCE	CHARLES TORNACI	REVIEWED		TONG		,
INSPECTOR						INTERSECTION OF MISSION GORGE ROAD AND OLIVE LANE.	HORIZ: 1" = 5'		ER THE SUPERVISION	N OF		STRUCTURE SPECIFICAT		CIP 2014-02	2021-116
DATE COMPLETED								CHARLES		DATE07/26/22	BY	⊥CUYAMACA STRE	EET RIGHT TURN POCKET	CIP 2014-02	
						ELEVATION: 337.97, M.S.L. DATUM	VERT: N/A	RCE NO	66058	EXPIRES6/30/2024	PROJECT ENGINEER				SHEET 17 OF 21



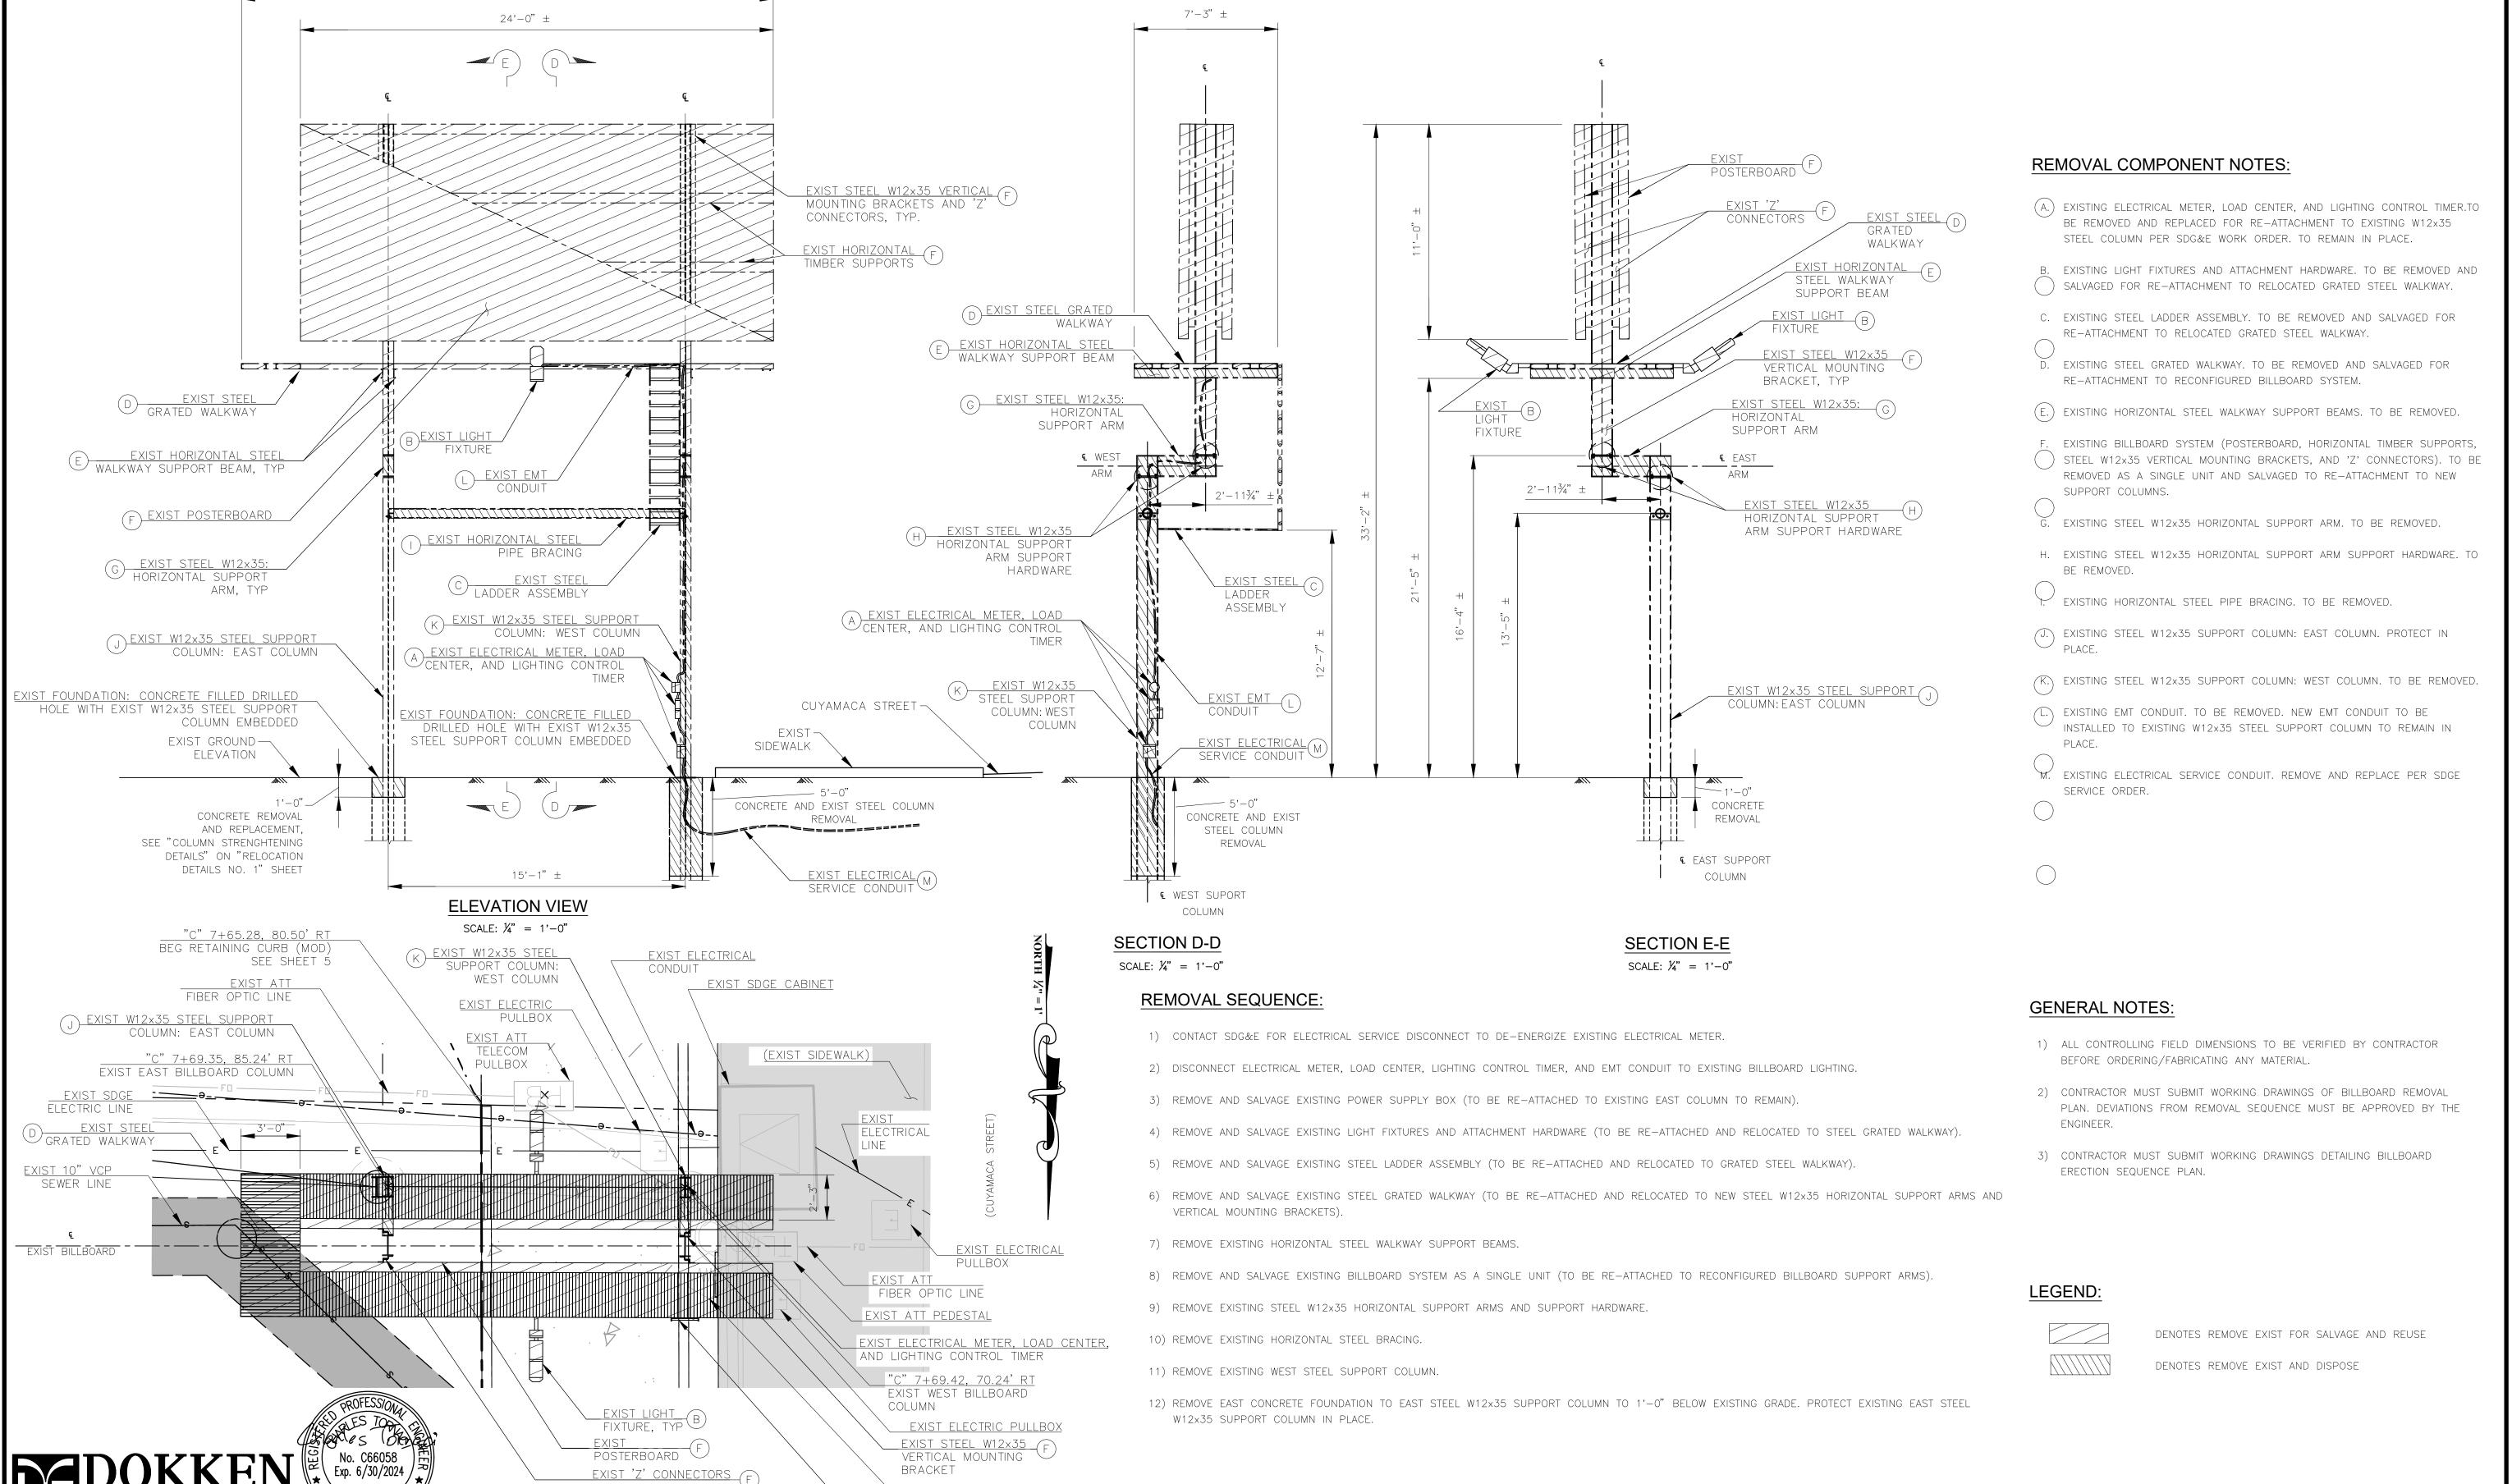

13) REMOVE WEST CONCRETE FOUNDATION TO WEST STEEL W12x35 SUPPORT COLUMN TO 3'-0" BELOW EXISTING GRADE.

REVIEWED ___

CITY OF SANTEE

BILLBOARD REMOVAL PLAN

DEPARTMENT OF DEVELOPMENT SERVICES

CUYAMACA STREET RIGHT TURN POCKET

CITY W.O. NO.

CIP 2014-02

CHECKED BY

CHARLES TORNACI

__ EXPIRES______6/30/2024_

EXIST WATER BACKFLOW

SCALE

HORIZ: 1" = 5'

DESIGNED BY

CHARLES TORNACI

DRAWN BY

ERIC PONCE

PLANS PREPARED UNDER THE SUPERVISION OF

PREVENTER

LADDER ASSEMBLY C

EXIST STEEL

TATION 2075 PER ROS 11252 - LEAD PLUG & BRASS TAG STAMPED "RCE

930" PER MAP 9372, LOCATED AT THE SOUTHEAST RETURN AT THE

LEVATION: 337.97, M.S.L. DATUM

 $27'-0" \pm$

PLAN VIEW

SCALE: $\frac{1}{4}$ " = 1'-0"

REVISIONS

ACPTD

DATE BY

SUITE 100 SAN DIEGO, CA 92108

CONTRACTOR


DATE COMPLETED

NSPECTOR


CONSTRUCTION RECORD


(858) 514-8377

REFERENCES

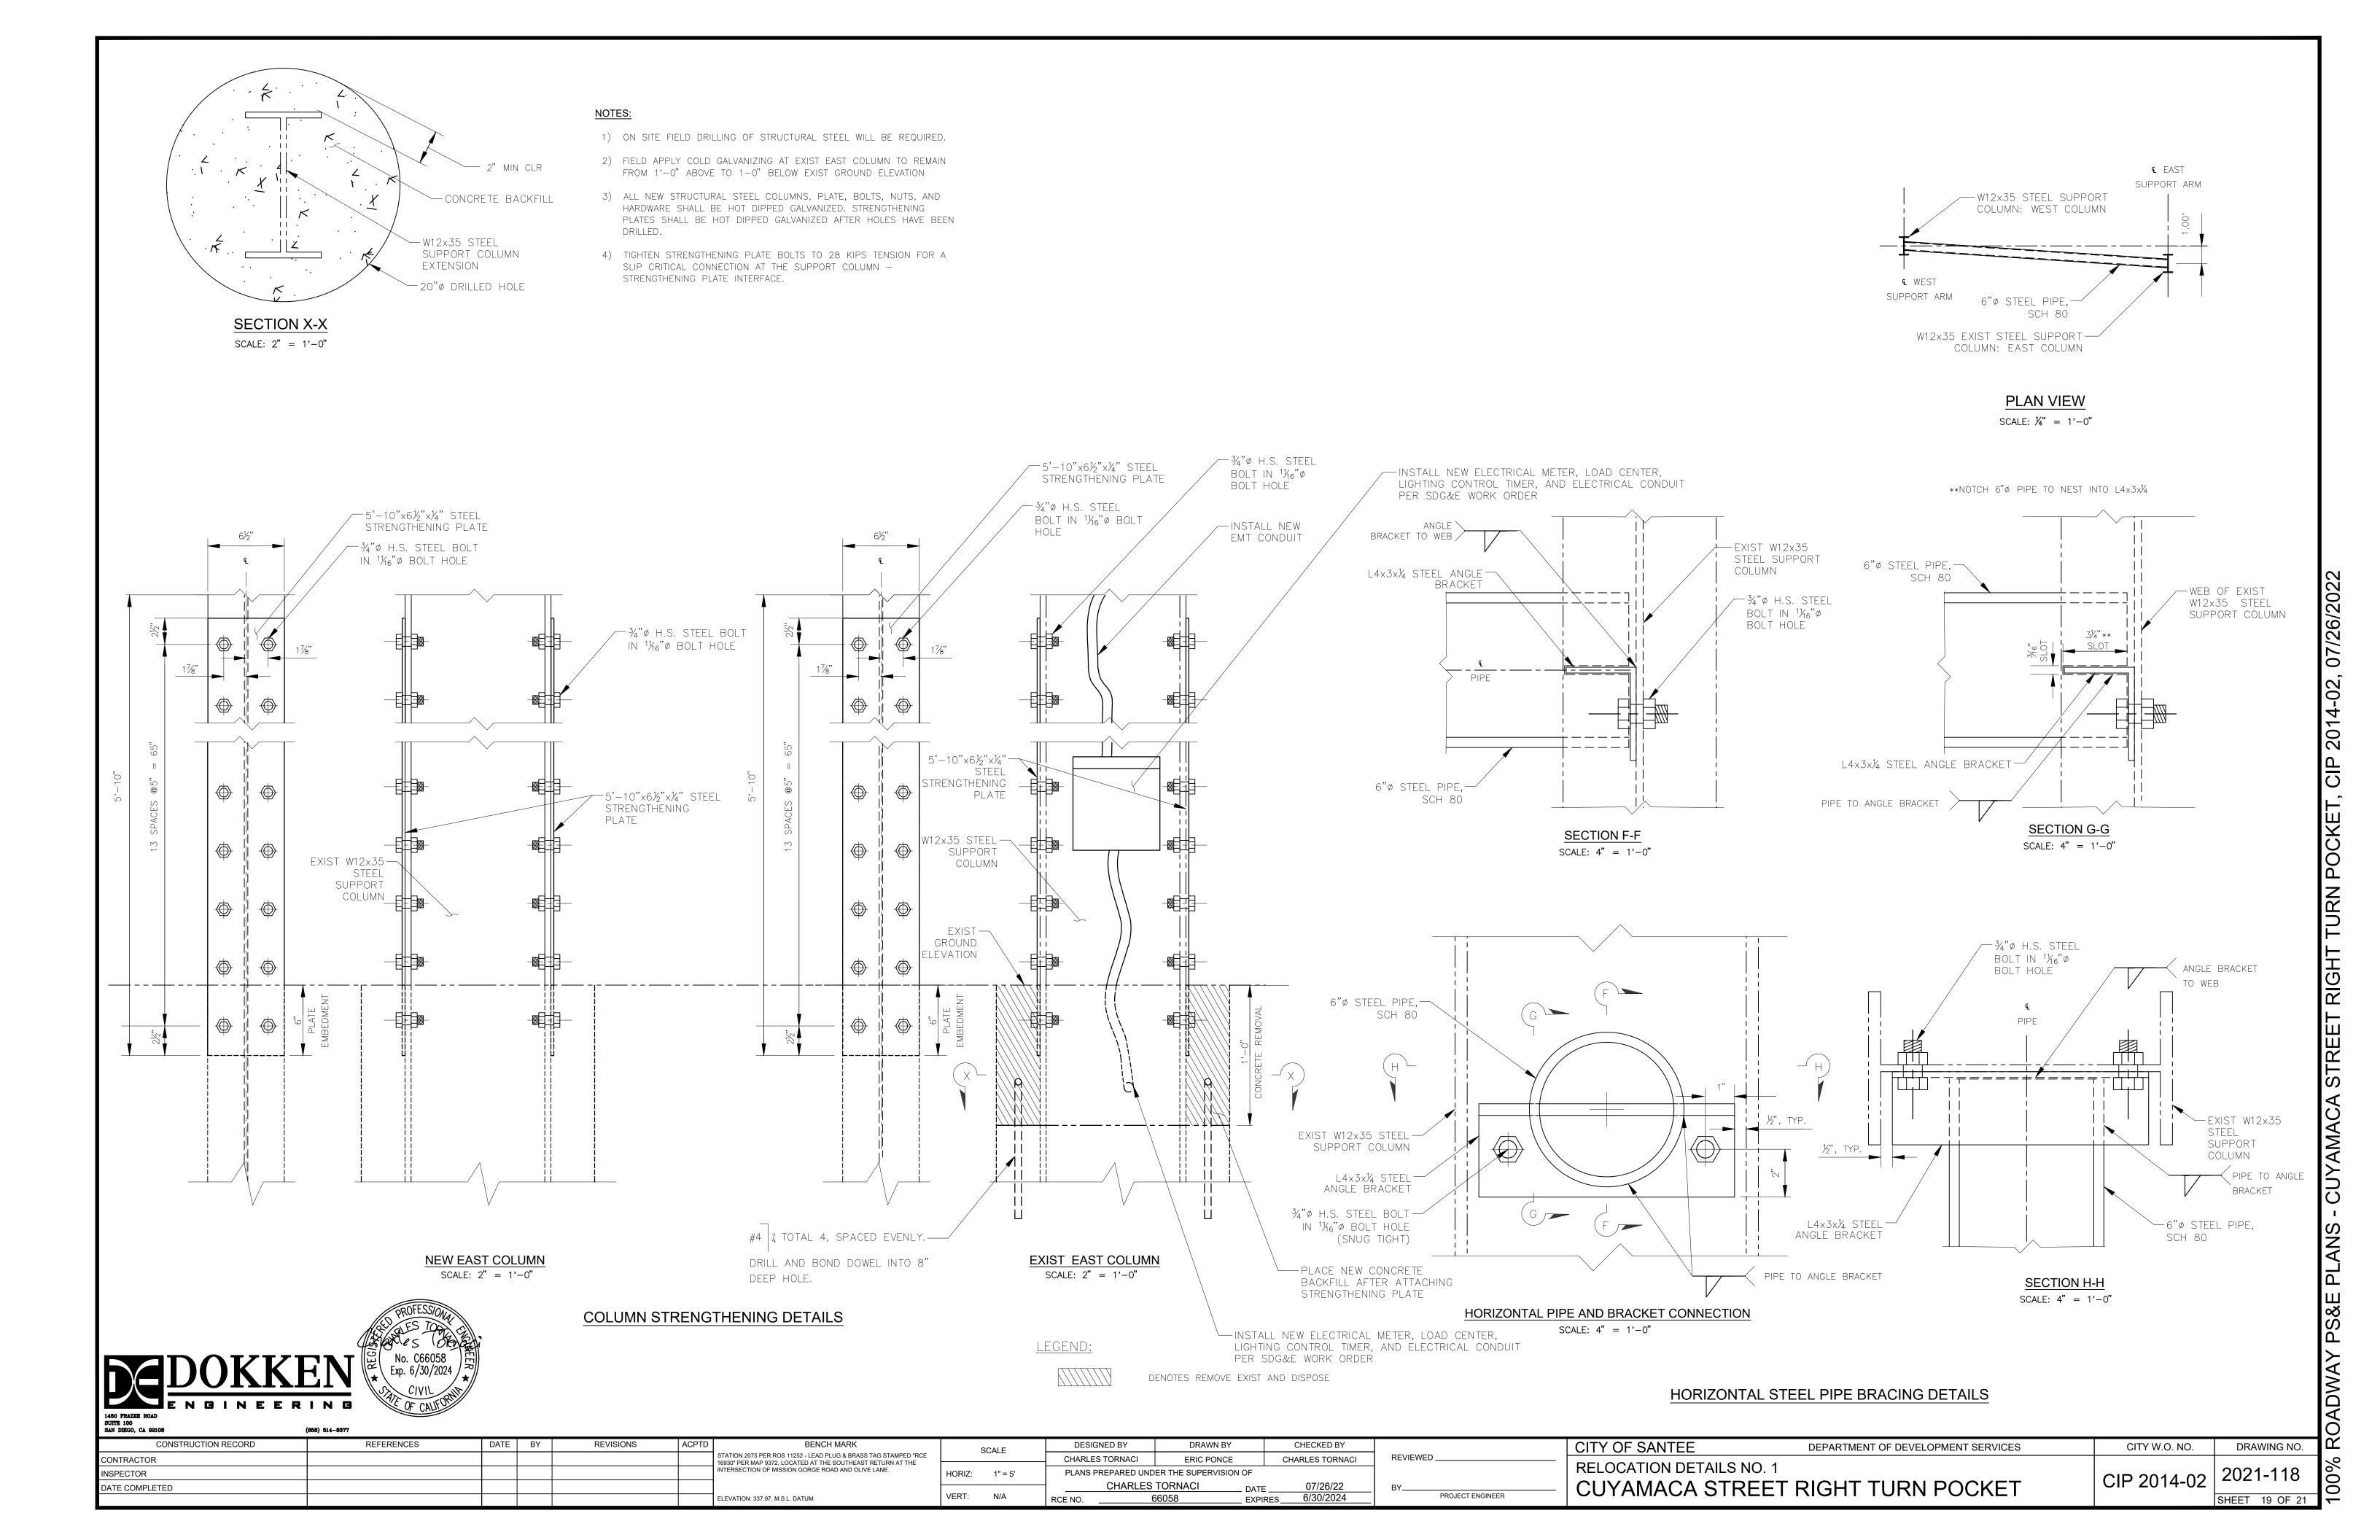



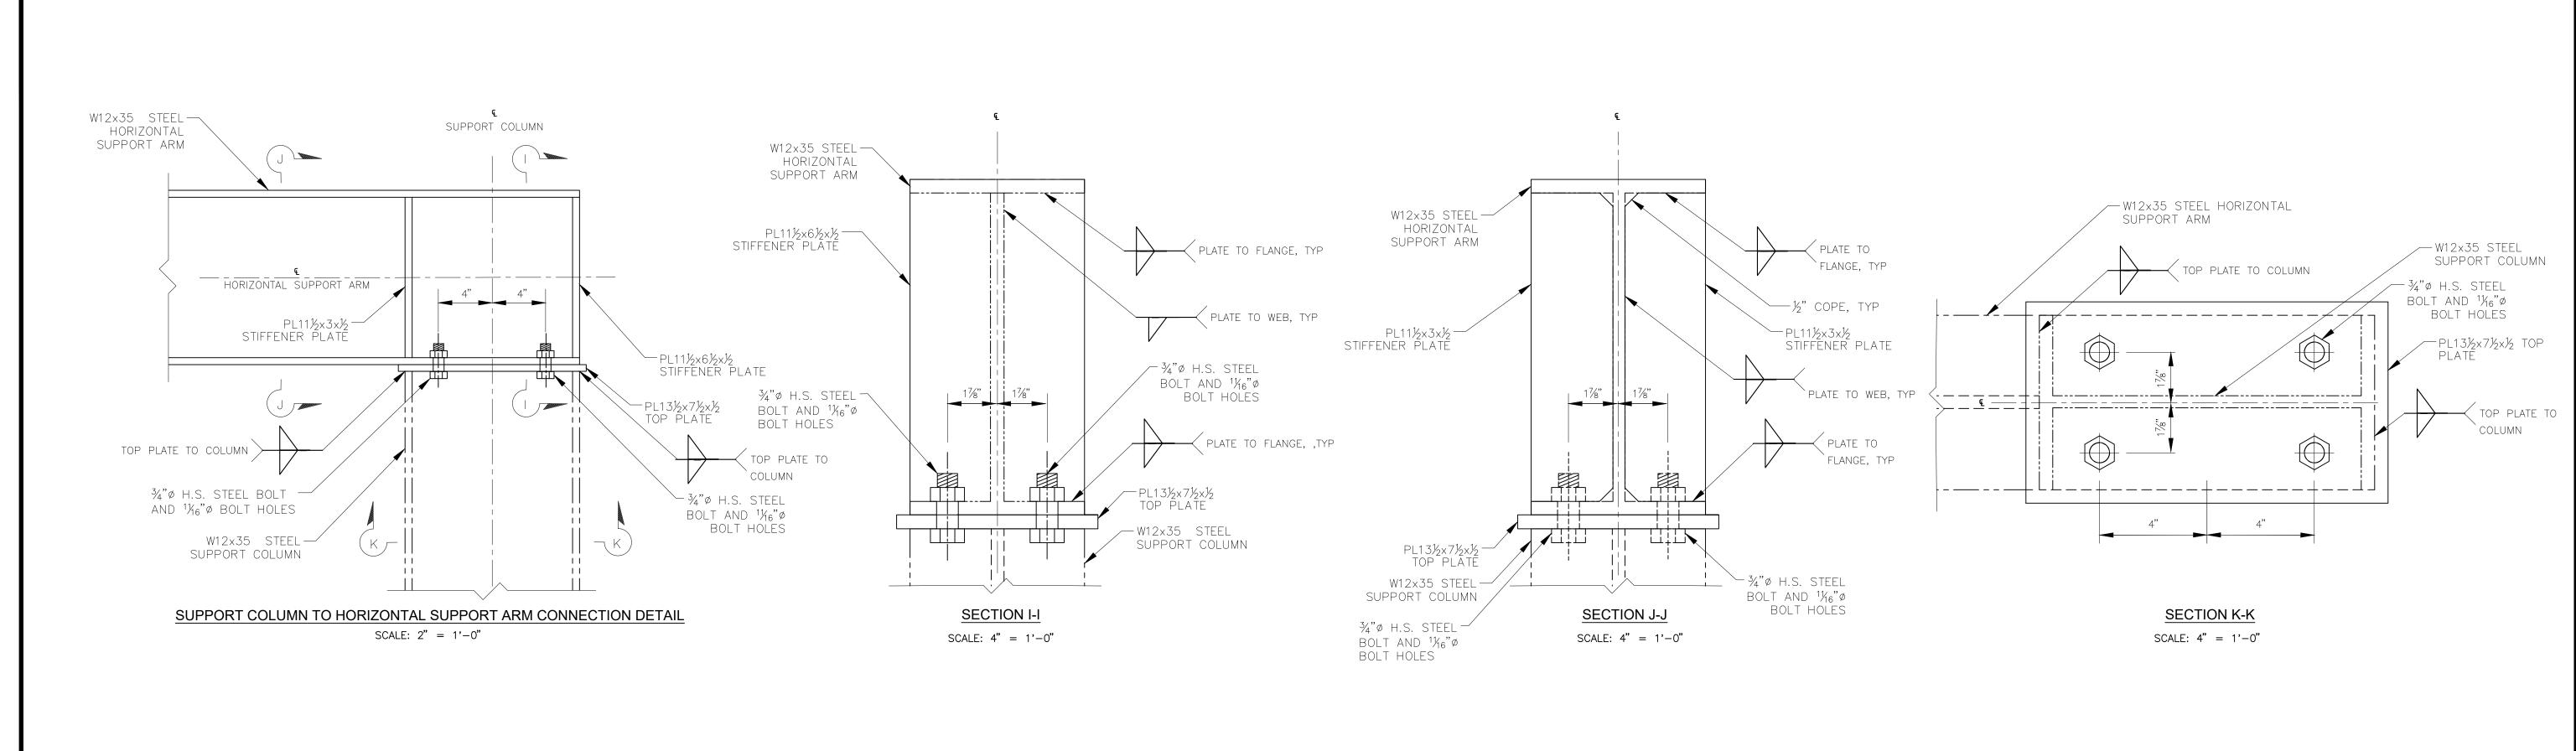

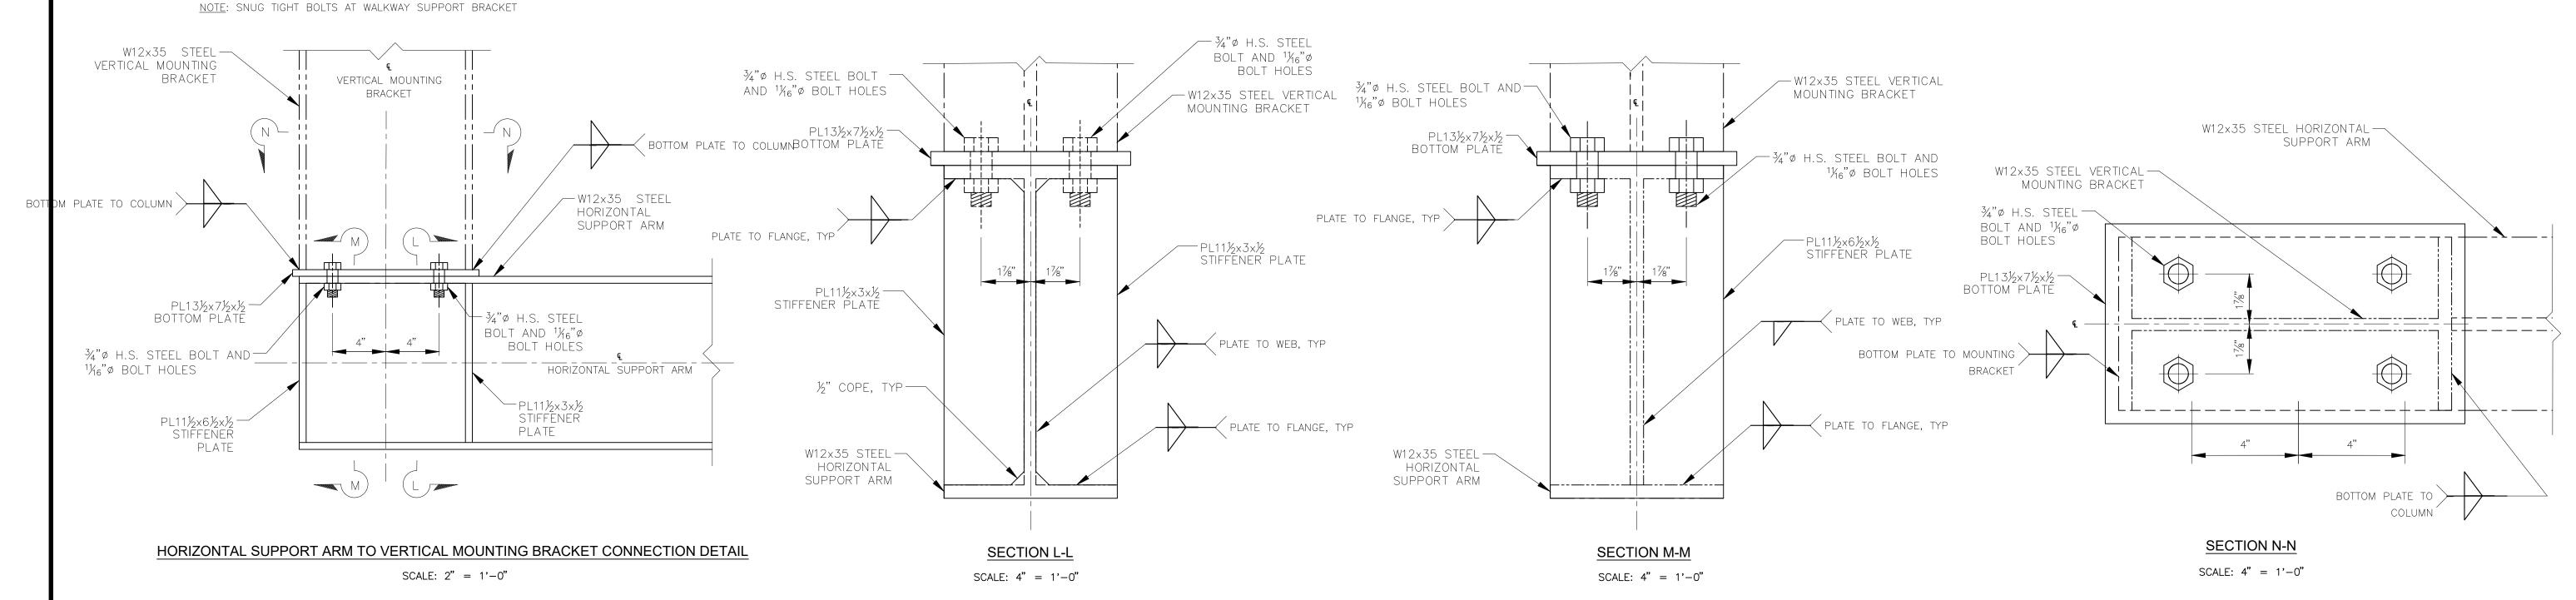

TYPICAL COLUMN JOINT CONNECTION DETAILS

NOTE:

EXIST EAST COLUMN SHOWN NEW EAST COLUMN SIMILAR

SAN DIEGO, CA 92108	(858) 514-8377													
CONSTRUCTION RECORD	REFERENCES	DATE BY	REVISIONS	ACPTD	BENCH MARK	SCALE	DESIGNED BY	DRAWN BY	CHECKED BY		CITY OF SANTEE	DEPARTMENT OF DEVELOPMENT SERVICES	CITY W.O. NO.	DRAWING NO.
CONTRACTOR				ST 16	TATION 2075 PER ROS 11252 - LEAD PLUG & BRASS TAG STAMPED "RCE 6930" PER MAP 9372, LOCATED AT THE SOUTHEAST RETURN AT THE		CHARLES TORNACI	ERIC PONCE	CHARLES TORNACI	REVIEWED	DELOCATION DETAILS NO. 2			
INSPECTOR				IN'	ITERSECTION OF MISSION GORGE ROAD AND OLIVE LANE.	HORIZ: 1" = 5'	PLANS PREPARED UND	ER THE SUPERVISION OF			RELOCATION DETAILS NO. 2		CID 2014 02	2021-119
DATE COMPLETED							CHARLES		ATE07/26/22	BY	- CUYAMACA STREET	RIGHT TURN POCKET	CIP 2014-02	
				EL	LEVATION: 337.97, M.S.L. DATUM	VERT: N/A	RCE NO.	6058 E	KPIRES 6/30/2024	PROJECT ENGINEER		TAIGHT TOTALL		SHEET 20 OF 21

