ENGINEER OF WORK'S DESIGN CERTIFICATION

MOKSUDUR RAHMAN, HEREBY DECLARE THAT I AM THE ENGINEER OF WORK FOR THIS PROJECT, THAT I HAVE EXERCISED RESPONSIBLE CHARGE, AS DEFINED IN SECTION 6703 OF THE BUSINESS AND PROFESSIONS CODE, OVER THE ENGINEERING DESIGN OF THIS PROJECT AND THAT THE DESIGN IS CONSISTENT WITH CURRENT STANDARDS

I, UNDERSTAND THAT THE CHECK OF PROJECT DRAWINGS AND SPECIFICATIONS BY THE CITY OF SANTEE IS CONFINED TO A REVIEW ONLY AND DOES NOT RELIEVE ME AS THE ENGINEER OF WORK OF MY RESPONSIBILITIES FOR PROJECT DESIGN.

I FURTHER UNDERSTAND THAT UPON APPROVAL OF THESE PLANS BY THE CITY ENGINEER. THE PLANS BECOME THE PROPERTY OF THE CITY OF SANTEE IN ACCORDANCE WITH THE CITY PUBLIC WORKS STANDARDS. AS SUCH, I HEREBY RELINQUISH RIGHT OF OWNERSHIP TO THE CITY TO USE THESE PLANS AS THEY MAY DEEM NECESSARY.

03/27/2024 REGISTRATION NO. C69263, MY REGISTRATION EXPIRES ON 6/30/24 RAHMAN ENGINEERING SERVICES, INC 13611 12TH ST., UNIT B CHINO, CA. 91710 (213) 400-8078 , <u>C69263</u> TELEPHONE: Exp. 6-30-24

ENGINEER OF WORK'S RECORD DRAWING CERTIFICATION

, MOKSUDUR RAHMAN, A REGISTERED CIVIL ENGINEER IN THE STATE OF CALIFORNIA, HEREBY DECLARE THAT I HAVE EXERCISED RESPONSIBLE CHARGE, AS DEFINED IN SECTION 6703 OF THE BUSINESS AND PROFESSIONS CODE, OVER THE PREPARATION OF THE ENGINEERING PORTION OF THE RECORD DRAWINGS AND THAT THE INFORMATION SHOWN IS BASED ON AN TO THE BEST OF MY KNOWLEDGE AND EXPERIENCE THE INFORMATION SHOWN ON THESE PLANS PROVIDE AN ACCURATE AND CORRECT REPRESENTATION

OF THE AS-BUILT CONDITIONS. 03/27/2024 REGISTRATION NO. C69263, MY REGISTRATION EXPIRES ON 6/30/24

RAHMAN ENGINEERING SERVICES, INC 13611 12TH ST., UNIT B

CHINO, CA. 91710

(213) 400-8078



CIVIL

TRAFFIC ENGINEER DESIGN CERTIFICATION

MOHAMMAD YUNUS RAHI, HEREBY DECLARE THAT I AM THE TRAFFIC ENGINEER FOR THIS PROJECT, THAT I HAVE EXERCISED RESPONSIBLE CHARGE, AS DEFINED IN SECTION 6703 OF THE BUSINESS AND PROFESSIONS CODE, OVER THE ENGINEERING DESIGN OF THIS PROJECT AND THAT THE DESIGN IS CONSISTENT WITH CURRENT STANDARDS


I, UNDERSTAND THAT THE CHECK OF PROJECT DRAWINGS AND SPECIFICATIONS BY THE CITY OF SANTEE IS CONFINED TO A REVIEW ONLY AND DOES NOT RELIEVE ME AS THE ENGINEER OF WORK OF MY RESPONSIBILITIES FOR PROJECT DESIGN.

I FURTHER UNDERSTAND THAT UPON APPROVAL OF THESE PLANS BY THE CITY ENGINEER, THE PLANS BECOME THE PROPERTY OF THE CITY OF SANTEE IN ACCORDANCE WITH THE CITY PUBLIC WORKS STANDARDS. AS SUCH, I HEREBY RELINQUISH RIGHT OF OWNERSHIP TO THE CITY TO USE THESE PLANS AS THEY MAY DEEM NECESSARY.

SIGNED: my all REGISTRATION NO. TR1726, MY REGISTRATION EXPIRES ON 06/30/25

TRAFFIC DESIGN. INC ADDRESS: 862 CANTERBURY LN

SAN DIMAS, CA. 91773 TELEPHONE: 626-826-7560

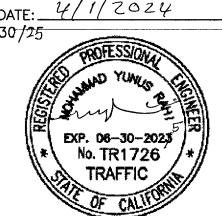

TRAFFIC ENGINEER RECORD DRAWING CERTIFICATION


, MOHAMMAD YUNUS RAHI, A REGISTERED CIVIL ENGINEER IN THE STATE OF CALIFORNIA, HEREBY DECLARE THAT I HAVE EXERCISED RESPONSIBLE CHARGE. AS DEFINED IN SECTION 6703 OF THE BUSINESS AND PROFESSIONS CODE, OVER THE PREPARATION OF THE ENGINEERING PORTION OF THE RECORD DRAWINGS AND THAT THE INFORMATION SHOWN IS BASED ON AN INVESTIGATION AND SURVEY OF THE IMPROVEMENTS BETWEEN THE DATES OF TO THE BEST OF MY KNOWLEDGE AND EXPERIENCE THE INFORMATION SHOWN ON THESE PLANS PROVIDE AN ACCURATE AND CORRECT REPRESENTATION OF THE AS-BUILT CONDITIONS.

4/1/2024


REGISTRATION NO. TR 1726, MY REGISTRATION EXPIRES ON 06/30/25 TRAFFIC DESIGN. INC

862 CANTERBURY LN SAN DIMAS, CA. 91773

TELEPHONE: _ 626-826-7560

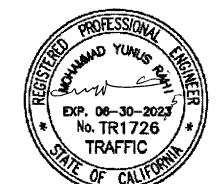

POPEYES FAST FOOD RESTAURANT STREET IMPROVEMENT PLAN

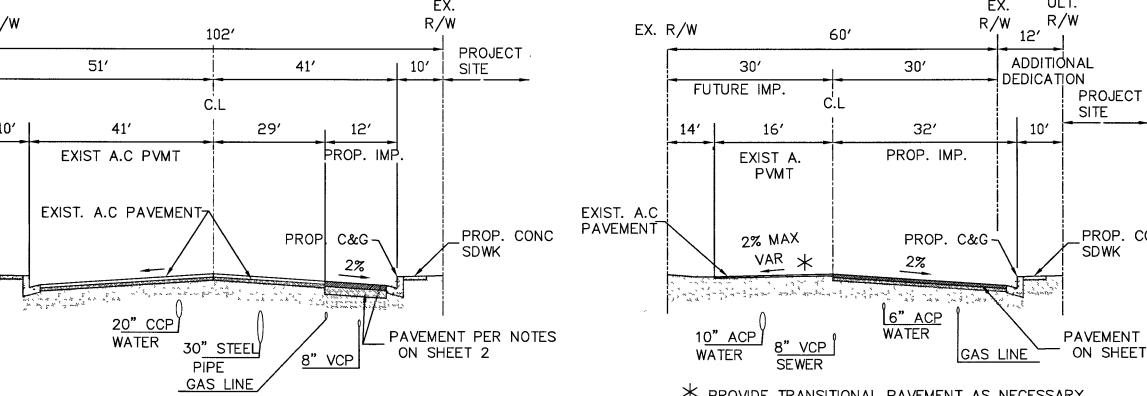

MISSION GORGE RD

HEREON ACKNOWLEDGE THESE PLANS HAVE BEEN PREPARED AT MY DIRECTION AND WITH MY

STANDARDS AND BE COMPLETED IN ACCORDANCE WITH THESE PLANS. ANY CHANGES TO THE

POLICY. I AGREE TO REMOVE AND RECONSTRUCT AT MY COST ANY WORK NOT COMPLETED IN

STRICT ACCORDANCE WITH THESE PLANS OR ANY CONSTRUCTION CHANGES APPROVED INCIDENTAL

I, A. WAHAB NOORI, A REGISTERED CIVIL ENGINEER IN THE STATE OF CALIFORNIA. PRINCIPALLY DOING

OF THE SOIL CONDITIONS PREVALENT WITHIN THIS SITE WAS MADE BY ME OR UNDER MY DIRECTION

BETWEEN THE DATES 1-5-21 AND 2-19-24. THREE COMPLETE COPIES OF THE SOILS REPORT

I HAVE REVIEWED THE PROJECT DESIGN AND THE GRADING SHOWN HEREON IS CONSISTENT WITH THE RECOMMENDATIONS CONTAINED IN THE APPROVED SOILS AND GEOTECHNICAL REPORTS FOR

BUSINESS IN THE FIELD OF APPLIED SOIL MECHANICS, HEREBY CERTIFY THAT A SAMPLING AND STUDY

COMPLIED FROM WITH MY RECOMMENDATIONS, HAS BEEN SUBMITTED TO THE OFFICE OF THE DIRECTOR

I FURTHER UNDERSTAND THAT UPON APPROVAL OF THESE PLANS BY THE CITY ENGINEER, THE PLANS

MY REGISTRATION EXPIRES ON 3/31/2024

SOILS ENGINEER RECORD DRAWING CERTIFICATION

REGISTRATION NO. C81696, MY REGISTRATION EXPIRES ON 3/31/2024

I, A. WAHAB NOORI, A REGISTERED CIVIL ENGINEER IN THE STATE OF CALIFORNIA. HEREBY DECLARE

BEST OF MY KNOWLEDGE AND EXPERIENCE THE GRADING CONFORMS WITH THE RECOMMENDATIONS

THAT I HAVE EXERCISED RESPONSIBLE CHARGE, AS DEFINED IN SECTION 6703 OF THE BUSINESS AND

CONTAINED IN THE SOILS REPORTS AND PLANS WITH THE EXCEPTION THAT ANY CHANGES OR DEVIATIONS

DATE:

PROFESSIONS CODE, OVER THE GEOTECHNICAL ASPECTS OF THE GRADING OF THIS PROJECT. TO THE

FROM THE PLANS DUE TO UNFORESEEN FIELD CONDITIONS HAVE BEEN IDENTIFIED IN THE FINAL SOILS

STANDARDS. AS SUCH, I HEREBY RELINQUISH RIGHT OF OWNERSHIP TO THE CITY TO USE THESE PLANS

BECOME THE PROPERTY OF THE CITY OF SANTEE IN ACCORDANCE WITH THE CITY PUBLIC WORKS

FULL CONSENT. I UNDERSTAND ALL CONSTRUCTION MUST CONFORM TO CURRENT CITY

OWNER'S ACCEPTANCE

ADDRESS: 41760 IVY ST., SUITE 201

TELEPHONE: 951-322-4066

OF DEVELOPMENT SERVICES.

AS THEY MAY DEEM NECESSARY.

FIRM: GEODYNE ENGINEERING, INC

IRVINE, CALIFORNIA 92618

REGISTRATION NO. C81696,

ADDRESS: #45 POST

TELEPHONE: (949) 636-8316

REPORT FOR THE PROJECT.

ADDRESS: #45 POST

FIRM: GEODYNE ENGINEERING, INC.


TELEPHONE: 1849, 636-8316 92618

MURRIETA, CA 92562

THERETO.

I, DAVID BESHAY, AS OWNER OF THE PROPERTY DESCRIBED

SOILS ENGINEER CERTIFICATION

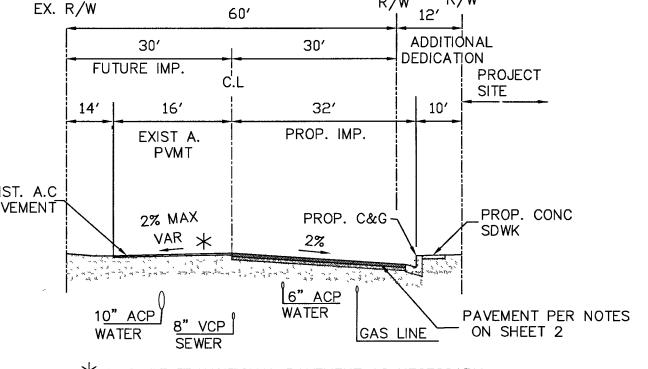

* PROVIDE TRANSITIONAL PAVEMENT AS NECESSARY TO ESTABLIHED NEW CENTERLINE CROWN. COTTONWOOD AVENUE

TYPICAL STREET CROSS SECTIONS

EX. R/W (N) 20' EX. R/W (S) SITE PAVEMENT PER NOTES 1% MIN ON SHEET 2

3RD STREE

N.T.S.

RIVERVIEW OFFICE PARK 0308 Mission Gorge RCP Block & Brick Sunset T

VICINITY MAP

SHEET INDEX

DESCRIPTION 1 OF 6 TITLE SHEET 2 OF 6 GENERAL NOTES 3 OF 6 STREET IMPROVEMENT PLAN 4 OF 6 STREET IMPROVEMENT PLAN

5 OF 6 TRAFFIC SIGNALPLAN SIGNING AND STRIPING PLAN 6 OF 6

ADDRESS

10308 MISSION GORGE RD SANTEE, CA 92071

ENGINEER OF WORK'S DESIGN CERTIFICATION

MOKSUDUR RAHMAN, HEREBY DECLARE THAT I AM THE ENGINEER OF WORK FOR THIS PROJECT, THAT I HAVE EXERCISED RESPONSIBLE CHARGE, AS DEFINED IN SECTION 6703 OF THE BUSINESS AND PROFESSIONS CODE, OVER THE ENGINEERING DESIGN OF THIS PROJECT AND THAT THE DESIGN IS CONSISTENT WITH CURRENT STANDARDS

II ACKNOWLEDGE THAT PADRE DAM IS NOT LIABLE FOR THE DESIGN OF THIS PROJECT IN ANY WAY. PADRE DAM MWD'S REVIEW OF THE APPLICABLE PROJECT DRAWINGS AND SPECIFICATIONS IS CONFINED TO A REVIW FOR CONFORMANCE WITH THE RELEVANT STANDARDS ONLY. PADRE DAM MWD'S REVIEW DOES NOT IN ANY WAY RELIEVE ME OF FULL RESPONSIBILITY FOR PROJECT DESIGN, INCLUDING CONSIDERATIONS REGARDING THE OPERATIONS AND MAINTENANCE OF THE FACILITIES.

BASIS OF BEARING

THE BASIS OF BEARING IS THE CENTERLINE OF MISSION GORGE ROAD BEING N88'16'48"W.

FIRE FLOW REQUIREMENTS

2,448 GPM PER FIRE FLOW TEST DATED 10/30/2023

ASSESSOR PARCEL NUMBERS Waln 03/27/2024 REGISTRATION NO. C69263, MY REGISTRATION EXPIRES ON 6/30/24

LEGEND

RAHMAN ENGINEERING SERVICES, INC 13611 12TH ST., UNIT B CHINO, CA. 91710 (213) 400-8078 TELEPHONE:

APPROVED BY

RCE NO

PDMWD PROJECT/FILE NAME

No. <u>C69263</u> Exp. 6-30-24 CIVIL

SYMBOL	DESCRIPTION	UNIT	QUANTITY
W W	EXISTING WATERLINE		
ss	EXISTING SEWER LINE		
	PAVEMENT RESTORATION	SF	275
	EXISTING WATER SERVICE ABANDONMENT	LF	30
№——E E®	FIRE SERVICE LINE	EA	1
⊗	EXISTING FIRE HYDRANT	EA	1
№———* ①	PROPOSED FIRE HYDRANT	EA	1
├ ®®	2" REDUCED PRESSURE BACKFLOW PREVENTION DEVICE	EA	1
⊢—®	EXISTING SEWER LATERAL	EA	1
├ ── ©	SEWER CLEANOUT	EA	1

LEGAL DESCRIPTION

THE LAND REFERRED TO HEREIN BELOW IS SITUATED IN THE COUNTY OF SAN DIEGO, STATE OF CALIFORNIA AND IS DESCRIBED AS FOLLOWS:

ALL OF LOTS 7 THROUGH 11, INCLUSIVE IN BLOCK 7 OF SANTEE, IN THE CITY OF SANTEE, COUNTY OF SAN DIEGO, STATE OF CALIFORNIA, ACCORDING TO MAP THEREOF NO. 1484, FILED IN THE OFFICE OF THE COUNTY RECORDER OF SAN DIEGO COUNTY, OCTOBER 14, 1912.

EXCEPTING THEREFROM THE SOUTHERLY 11.00 FEET; TOGETHER WITH THAT PORTION OF SAID LOT 7 LYING SOUTHWESTERLY OF THE ARC OF A 25.00 FOOT RADIUS CURVE, CONCAVE NORTHEASTERLY, SAID CURVE BEING TANGENT TO THE WESTERLY LINE OF SAID LOT 7 AND TANGENT TO THE NORTHERLY LINE OF THE SOUTHERLY 11.00 FEET OF SAID LOT 7.



PADRE DAM Municipal Water District 4.19/24 DIRECTOR OF ENGINEERING & PLANNING 223008 WSA

SERVICE AREA

VALID FOR ONE YEAR FROM THE DATE OF SIGNATURE SIGNATURE OF THESE PLANS IS NOT A COMMITMENT TO SERVE ACTUAL FIELD ONDITIONS MAY REQUIRE CHANGES TO THE WATER, SEWER, AND/OR RECYCLED WATEF PLANS THE DEVELOPER AND/OR ITS ENGINEER OF WORK SHALL BE RESPONSIBLE FOR MAKING ANY NECESSARY CHANGES AT NO ADDITIONAL COST TO THE DISTRICT

PDMWD JOB NO

CITY OF SANTEE FIRE DEPARTMENT 4-17-24 FIRE MARSHAL COMMUNITY SERVICES DEPARTMENT Sam who 4-11-24 PUBLIC SERVICES MANAGER PLANNING DIMISION/ PROJECT PLANNER TRAFFIC ENGINEERING DIVISION 4/11/2024 PRINCIPAL TRAFFIC ENGINEER

CONSTRUCTION RECORD REFERENCES DATE BY REVISIONS MISSION GORGE RD IMPROVEMENTS, N2003-00 DATE COMPLETED. COTTONWOOD AVE IMPROVEMENTS, WATER PLAN

THE BENCHMARK FOR THIS SURVEY IS STATION #2107 PER RECORD OF SURVEY NO. 11252, A STANDARD STREET WELL MONUMENT WITH BRASS DISC MARKED "SD CO ENGR DEPT SURV MON," LOCATED AT THE INTERSECTION OF MISSION GORGE ROAD AND COTTONWOOD AVE ELEVATION = 349.74 FFFT (NGVD 29)

DESIGNED BY DRAWN BY CHECKED BY HORIZ AS SHOWN PLANS PREPARED UNDER THE SUPERVISION OF 02/22/24 MOKSUDUR RAHMAN VERT AS SHOWN RCE NO C69263 EXPIRES 6/30/24

4/10/24 HaJsaac

Exp. 6-30-24

CIVIL

CITY OF SANTEE DEPARTMENT OF DEVELOPMENT SERVICES IMPROVEMENT PLAN FOR POPEYES FAST FOOD RESTAURANT

DRAWING NO CITY WO NO SHEET 1 OF 6

GENERAL NOTES

- AN ENCROACHMENT PERMIT SHALL BE OBTAINED FROM THE DEPARTMENT OF DEVELOPMENT SERVICES PRIOR TO THE START OF ANY CONSTRUCTION WITHIN THE LIMITS OF THE PUBLIC RIGHT-OF-WAY INCLUDING BUT NOT LIMITED TO UTILITY CONNECTIONS OR GRADING.
- ACCEPTANCE OF THESE IMPROVEMENTS AS SHOWN DOES NOT CONSTITUTE APPROVAL OF ANY CONSTRUCTION OUTSIDE THE PROJECT BOUNDARY.
- ALL UNDERGROUND UTILITIES WITHIN THE STREET RIGHT-OF-WAY SHALL BE CONSTRUCTED, TESTED AND CONNECTED PRIOR TO CONSTRUCTION OF BERMS, CURBS, CROSS-GUTTERS, SIDEWALKS OR FINAL PAVING.
- LOCATION AND ELEVATION OF IMPROVEMENTS TO BE MET BY WORK TO BE DONE SHALL BE CONFIRMED BY FIELD MEASUREMENTS PRIOR TO CONSTRUCTION OF NEW WORK. THE OWNER SHALL BE RESPONSIBLE FOR MAKING EXPLORATORY EXCAVATIONS AND LOCATING EXISTING UNDERGROUND FACILITIES SUFFICIENTLY AHEAD OF CONSTRUCTION TO ALLOW FOR REVISIONS TO PLANS OF REVISIONS ARE NECESSARY BECAUSE OF CHANGES IN LINE OR GRADE DUE TO THE ACTUAL LOCATION OF THE EXISTING FACILITIES.
- THE CONTRACTOR SHALL NOTIFY DIG ALERT 24 HOURS PRIOR TO STARTING WORK AND SHALL COORDINATE HIS WORK WITH UTILITY COMPANY REPRESENTATIVES.
- IT SHALL BE THE RESPONSIBILITY OF THE OWNER TO CONTACT THE UTILITY AGENCIES, ADVISE THEM OF THE PROPOSED IMPROVEMENTS, AND BEAR THE COST OF RELOCATIONS, IF NEEDED. NOTICE OF PROPOSED WORK SHALL BE GIVEN TO THE FOLLOWING AGENCIES:

SAN DIEGO GAS & ELECTRIC	1-800-336-7343
AT&T	1-800-422-4133
COX COMMUNICATIONS	619-263-5793
PADRE DAM MUNICIPAL WATER DISTRICT	619-258-4600

- POWER SOURCES AND RUNS SERVING STREET LIGHTS SHALL BE SHOWN ON THE AS-BUILT IMPROVEMENT DRAWINGS. ALL SOURCES SHALL BE LOCATED WITH THE DEDICATED RIGHT-OF-WAY, OR WITHIN EASEMENTS DEDICATED TO THE CITY OF SANTEE.
- FINAL PAVING SHALL NOT BE PERFORMED UNTIL EXISTING POWER POLES ARE RELOCATED OUTSIDE THE AREAS TO BE PAVED AND ALL REMEDIAL CONCRETE REPLACEMENT HAS BEEN CORRECTED.
- 9. CITY OF SANTEE INSPECTION REQUIREMENTS:
 - A. CONTRACTOR SHALL INFORM THE CITY PROJECT ENGINEER 48 HRS. IN ADVANCE OF COMMENCING WORK. PHONE (619) 258-4100.
 - B. THE CONTRACTOR SHALL GIVE A MINIMUM OF 24 HRS. NOTICE ON REQUESTS FOR INSPECTION. PHONE (619) 258-4100 x 168.
 - C. ALL WORK PERFORMED WITHOUT THE BENEFIT OF INSPECTION IS SUBJECT TO REMOVAL REPLACEMENT AT THE CONTRACTOR'S EXPENSE
- THE DEPARTMENT OF DEVELOPMENT SERVICES WILL REMOVE STREET NAME SIGNS WHEN CONDITIONS DICTATE. CONTRACTOR SHALL PROTECT AND ASSUME RESPONSIBILITY FOR ALL OTHER TRAFFIC CONTROL DEVICES. CONTRACTOR SHALL REPLACE TRAFFIC STRIPING, STREET MARKINGS, AND CURB MARKINGS REMOVED OR DAMAGED BY HIS WORK.
- 11. SIDEWALK JOINT LOCATIONS SHALL BE INSTALLED IN ACCORDANCE WITH REGIONAL STANDARD DRAWING NO. G-9. CURB OR CURB AND GUTTER JOINT LOCATIONS SHALL INCLUDE EXPANSION JOINTS AT CURB RETURNS. ADJACENT TO STRUCTURES AND AT 45 FOOT INTERVALS. WEAKENED PLANE JOINTS SHALL BE INSTALLED AT DRIVEWAY LOCATIONS AND AT 15 FOOT INTERVALS BETWEEN EXPANSION JOINTS. ALL CONCRETE JOINTS SHALL
- SIDEWALKS AND BIKEPATHS ARE DESIGNED TO HAVE CLEAR UNOBSTRUCTED ACCESS. STREET LIGHTS, FIRE HYDRANTS, METER BOXES, TRANSFORMERS, UTILITY VAULTS, PULL BOXES, BLOWOFFS, AIR VENTS OR OTHER SIMILAR AT-GRADE AND ABOVE-GRADE FACILITIES SHALL BE LOCATED A MINIMUM OF 18-INCHES FROM ALL SIDEWALKS AND BIKEPATHS.
- THE OWNER IS RESPONSIBLE FOR ENSURING ADEQUACY OF DESIGN AND CONSTRUCTION IN ACCORDANCE WITH THE SPECIFIED GENERAL STANDARDS OF CONSTRUCTION LISTED HEREON, AND TO PROTECT THE WORK AT ALL TIMES DURING THE COURSE OF CONSTRUCTION. FAILED OR DAMAGED WORK SUCH AS CRACKED SIDEWALKS, CURB AND GUTTER, CROSS GUTTERS, DRIVEWAY APRONS AND SO FORTH, SHALL BE REPLACED TO THE NEAREST JOINT OR SCORE LINE IN EACH DIRECTION PRIOR TO PLACEMENT OF THE FINAL PAVEMENT COURSE AND FINAL ACCEPTANCE OF THE WORK BY THE
- 14. ACCEPTANCE OF THESE PLANS BY THE CITY OF SANTEE IS VALID FOR ONE YEAR FROM THE DATE OF ACCEPTANCE. FAILURE TO COMMENCE CONSTRUCTION WITHIN ONE YEAR VOIDS ACCEPTANCE OF THESE PLANS.

STORMWATER POLLUTION PREVENTION NOTES

- APPROPRIATE EROSION PREVENTION AND SEDIMENT CONTROL MEASURES WILL BE IMPLEMENTED AT ALL TIMES.
- 2. THE TOPS OF ALL SLOPES SHALL HAVE A DIKE OR TRENCH TO PREVENT WATER FROM FLOWING OVER THE CRESTS OF SLOPES.
- 3. CLEAN GRAVEL ONLY WILL BE USED IN GRAVEL BAGS.

CONSTRUCTION RECORD

CONTRACTOR .

DATE COMPLETED__

NSPECTOR _

- 4. CATCH BASINS, DESILTING BASINS, GRAVEL BAGS, CHECK DAMS AND STORM DRAIN SYSTEMS SHALL BE INSTALLED TO THE SATISFACTION OF THE CITY ENGINEER. THESE FACILITIES SHALL BE CLEANED ON A REGULAR BASIS, AND KEPT FREE OF SOIL ACCUMULATION.
- 5. GRAVEL BAG CHECK DAMS SHALL BE PLACED IN UNPAVED AREAS WITH GRADIENTS IN EXCESS OF 2%, IN OTHER GRADED OR EXCAVATED AREAS AS REQUIRED BY THE DEPARTMENT OF DEVELOPMENT SERVICES, AND AT OR NEAR EVERY POINT WHERE CONCENTRATED FLOWS LEAVE THE DEVELOPMENT.
- GRAVEL BAGS SHALL BE PLACED ON THE UPSTREAM SIDE OF ALL DRAINAGE INLETS TO MINIMIZE SILT BUILDUP IN THE INLETS AND PIPES.
- 7. THE CONTRACTOR SHALL IMMEDIATELY REPAIR ANY ERODED SLOPES.
- 8. ROADWAYS AND ENTRANCES TO AND FROM THE SITE SHALL BE SWEPT ON A REGULAR BASIS TO KEEP THEM FREE OF SOIL ACCUMULATION.
- CONTRACTOR SHALL HAVE WATER TRUCKS AND EQUIPMENT ON-SITE TO MINIMIZE AIRBORNE DUST CREATED FROM GRADING AND HAULING OPERATIONS OR EXCESSIVE WIND CONDITIONS. WATERING SHALL BE PERFORMED ON A CONTINUOUS BASIS ANY TIME THESE CONDITIONS ARE PRESENT AND AT ALL OTHER TIMES AS DIRECTED BY THE CITY ENGINEER. ADDITIONAL DUST CONTROL MEASURES SHALL BE IMPLEMENTED AS NEEDED.

REFERENCES

MISSION GORGE RD IMPROVEMENTS, N2003-008

COTTONWOOD AVE IMPROVEMENTS, SEWER PLA

OTTONWOOD AVE IMPROVEMENTS, WATER PLAN

ONWOOD AVE IMPROVEMENTS, R90065-RS

DATE BY

REVISIONS

IMPROVEMENT PLAN NOTES

STORMWATER POLLUTION PREVENTION NOTES:

- 10. STOCKPILES SHALL BE COVERED AT THE END OF EACH WORKING DAY AND PRIOR TO PREDICTED RAIN EVENTS. ASPHALT SHALL BE STORED ON A LAYER OF PLASTIC SHEETING, OR EQUIVALENT.
- 11. ALL PORTABLE TOILETS SHALL HAVE A SECONDARY CONTAINMENT AND NOT BE LOCATED NEAR A STORM DRAIN (I.E. CATCH BASIN OR STREET).
- 12. INACTIVE SLOPES SHALL BE PROTECTED AND STABILIZED WITHIN 10 CALENDAR DAYS OF LAST BEING WORKED, OR ON THE DIRECTION OF THE CITY. ACTIVE SLOPES SHALL BE STABILIZED DURING RAIN.
- 13. EROSION CONTROL ON SLOPES SHALL BE MITIGATED BY INSTALLING LANDSCAPING AS PER APPROVED LANDSCAPE PLANS AS REQUIRED BY THE DEVELOPMENT REVIEW CONDITIONS, OR BY TEMPORARY EROSION CONTROL CONFORMING TO THE FOLLOWING:

NON-IRRIGATED HYDROSEED MIX

BS. PER ACRE	% PURITY PER ACRE	SEED SPECIES
20 50 8	70% PLS.	ATRIPLEX GLAUCA PLANTAGE INSULARIS ENCELIS FARINOSA
6 7	SCARIFIED 50% PLS.	LOTUS SCOPARIUS EXCHSCHOLTZIA CALII
91 IRS		

PAVING NOTES:

- A MINIMUM OF SEVEN DAYS PRIOR TO THE PLACEMENT OF ROADWAY BASE MATERIAL THE CONTRACTOR SHALL SUBMIT A CERTIFIED SOILS REPORT FROM A REGISTERED CIVIL OR GEOTECHNICAL ENGINEER CERTIFYING ALL ROADWAY AND UTILITY TRENCHING HAS BEEN COMPACTED TO THE MINIMUM REQUIREMENTS SPECIFIED IN THE STANDARD SPECIFICATIONS FOR PUBLIC WORKS CONSTRUCTION AND THE RECOMMENDATIONS CONTAINED IN THE PROJECT'S SOILS REPORT.
- A FINAL PAVEMENT STRUCTURAL SECTION DESIGN SHALL BE SUBMITTED TO THE CITY ENGINEER FOR APPROVAL A MINIMUM OF TEN DAYS PRIOR TO PLACEMENT OF BASE MATERIAL. THE DESIGN REPORT SHALL CONFORM TO CITY FORM 435 - PAVEMENT DESIGN AND R-VALUE TEST SUBMITTAL PROCEDURES. THE DESIGN SHALL ADHERE TO THE METHODOLOGY SET FORTH IN CHAPTER 600 OF THE CALTRANS HIGHWAY DESIGN MANUAL AND UTILIZE THE "R" VALUE METHOD. DESIGN SHALL BE SUBMITTED IN REPORT FORM AND MUST INCLUDE ALL SUPPORTING CALCULATIONS AND TEST RESULTS. THE "R" VALUE TESTS SHALL BE CONDUCTED IN ACCORDANCE WITH CALIFORNIA TEST NO. 301 AND SHALL BE PERFORMED BY A REGISTERED CIVIL ENGINEER WHOSE PRIMARY PROFESSIONAL ACTIVITY IS PERFORMING SUCH TESTS. THE NUMBER AND LOCATION OF R-VALUE TESTS SHALL BE COORDINATED WITH THE CITY PROJECT INSPECTOR AND BE SUBJECT TO APPROVAL OF THE CITY PROJECT ENGINEER.
- THE FOLLOWING MINIMUM STRUCTURAL THICKNESS ARE BASED ON AN R-VALUE OF 30. TRAFFIC INDEXES ARE BASED ON CITY PUBLIC WORKS STANDARDS AND SHALL BE USED FOR PAVEMENT DESIGN BASED ON ACTUAL R-VALUES OBTAINED AT TIME OF CONSTRUCTION.

STREET NAME SECTION	TRAFFIC INDEX	ANTICIPATED STRUCTURAL
A. MISSION GORGE RD B. COTTONWOOD AVE C. 3RD STREET	8.5 8.0 4. 5	4" AC / 12" AB 5" AC / 9" AB 2.5" AC / 6" AB

THE MINIMUM SECTIONS LISTED ABOVE ARE FOR ESTIMATION AND DESIGN PURPOSES ONLY AND ARE SUBJECT TO CHANGE FOLLOWING SUBMITTAL OF THE FINAL PAVEMENT DESIGN REPORT.

ASPHALT CONCRETE SHALL CONFORM TO ALL PROVISIONS OF SECTION 39 OF THE CURRENT CALTRANS STANDARD SPECIFICATIONS. SURFACE COURSE SHALL BE A MINIMUM THICKNESS IS 2 INCHES, MAXIMUM THICKNESS IS 3 INCHES. ASPHALT CONCRETE SECTIONS GREATER THAN 3 INCHES SHALL CONTAIN A BASE COURSE OF ASPHALT, A MINIMUM THICKNESS OF 2

ACCEPTED UNTREATED BASE MATERIALS INCLUDE:

PROCESSED MISCELLANEOUS BASE PER THE GREEN BOOK AND CALTRANS CLASS 2 RECYCLED BASE ARE NOT PERMITTED.

<u> ACCEPTED ASPHALT BASE COURSE MIXES INCLUDE:</u>

PER CALTRANS 39 PG 64-10 - ¾" MAXIMUM, COARSE

ACCEPTED ASPHALT SURFACE COURSE MIXES INCLUDE:

PG 64-10 - 3" MAXIMUM, COARSE PER CALTRANS 39

UTILITY COORDINATION NOTES:

THESE PLANS CONTAIN MEANDERING BIKE AND PEDESTRIAN PATHS. THE LOCATION OF ALL ABOVE GROUND AND AT GRADE UTILITIES SHALL BE COORDINATED WITH THE MEANDERING PATH. NO ABOVE GROUND FACILITY SHALL BE LOCATED WITHIN TWO FEET OF THE PATH (PREFERRED MINIMUM IS THREE FEET). ACTUAL LOCATION OF FACILITIES IS SUBJECT TO APPROVAL BY THE CITY ENGINEER PRIOR TO ISSUANCE OF A CONSTRUCTION / ENCROACHMENT PERMIT. 'ALL ABOVE GROUND FACILITIES SHALL BE PAINTED WITH AMERON AMERSHIELD RAPID RESPONSE RT1405 PAINT IN ACCORDANCE WITH THE MANUFACTURERS SPECIFICATIONS.

PADRE DAM GENERAL NOTES:

1. CONTRACTORS SHALL NOTIFY THE DISTRICT TWO WORKING DAYS PRIOR TO COMMENCING WORK, TELEPHONE (619) 258-4635. 2. ALL UNDERGROUND UTILITIES AND LATERALS TO BE INSTALLED BEFORE CONSTRUCTION OF CURBS, OR CONCRETE CROSS GUTTERS, OR SURFACING OF STREETS. 3. CONTRACTORS SHALL; VERIFY LOCATIONS AND MAINTAIN ALL EXISTING WATER AND SEWER UTILITIES DURING CONSTRUCTION; BE RESPONSIBLE FOR ANY DAMAGE TO EXISTING WATER OR SEWER MAINS ON SITE AS A RESULT OF THEIR OPERATIONS; AND HAVE ON SITE, SUFFICIENT PIPELINE MATERIALS AND EQUIPMENT TO IMMEDIATELY REPAIR ANY DAMAGE TO THE EXISTING WATER, SEWER, OR RECYCLED WATER FACILITIES.

4. CONTRACTOR SHALL UNCOVER LOCATION OF CONNECTIONS PRIOR TO BEGINNING INSTALLATION TO INSURE CONFORMANCE WITH LINES AND GRADES SHOWN ON THE PLANS. ANY DISCREPANCIES SHALL BE BROUGHT TO THE ATTENTION OF THE DIRECTOR OF ENGINEERING AND PLANNING PRIOR TO PROCEEDING.

5. THE CONTRACTOR SHALL BE RESPONSIBLE FOR RELOCATION OR ADJUSTMENT OF ANY NEW OR EXISTING SEWER, RECYCLED WATER, OR POTABLE WATER SERVICE APPURTENANCES, MANHOLES, GATE VALVE COVERS, OR METER BOXES TO NEW FINISH

6. WORK IN ROADWAY SHALL COMPLY COMPLETELY WITH THE REQUIREMENTS OF THE COUNTY OR CITY. APPROPRIATE CONTRACTOR'S LICENSE REQUIRED. 7. DEVELOPER SHALL PROVIDE, AT DEVELOPER'S EXPENSE, SUCH SOIL TESTING AND RETESTING AS DISTRICT MAY REQUIRE.

8. VALVES THAT ARE DEEPER THAN 1.5M (5') MUST HAVE VALVE STEM RISERS. 9. ALL FITTINGS ON PVC PIPE ARE TO BE MECHANICAL JOINT OR PUSH-ON TYPE. 10. EXISTING VALVES (INCLUDING WET-TAP VALVES) ARE TO BE OPERATED BY DISTRICT

11. THE GENERAL CONTRACTOR SHALL KEEP AND MAINTAIN A SIGNED SET OF IMPROVEMENT PLANS ON-SITE AT ALL TIMES FOR REVIEW BY THE DIRECTOR OF ENGINEERING AND PLANNING OR HIS REPRESENTATIVES. THE GENERAL CONTRACTOR'S SUPERINTENDENT IS REQUIRED TO UPDATE SAID PLANS WITH AS-BUILT INFORMATION ON A DAILY BASIS AS WORK IS

12. ALL WATER MAINS SHALL BE CONSTRUCTED AS SHOWN ON PLANS. POTABLE WATER MAINS SHALL HAVE A MINIMUM COVER OF 0.9M

(36"). RECYCLED WATER MAINS SHALL HAVE A MINIMUM COVER OF 1.4M (54") 13. WHERE A POTABLE WATER MAIN CROSSES UNDER A RECYCLED WATER OR SEWER, THE POTABLE WATER MAIN SHALL HAVE NO JOINTS WITHIN 10' OF THE CROSSING.

14. WARNING TAPE AND TRACER WIRE MUST BE INSTALLED OVER ALL POTABLE WATER MAINS, RECYCLED WATER MAINS, WATER SERVICES, B.O.'S, AND AIR VALVES, PER DRAWINGS WP-01 AND WP-02.

PAGE 2 OF 2 REVISED: 03/02/2020 15. ALL POTABLE WATER LINE VALVE LIDS ARE TO BE PAINTED YELLOW. ALL FIRE HYDRANT VALVE LIDS ARE TO BE PAINTED WHITE. ALL RECYCLED WATER LINE VALVE LIDS ARE TO BE PAINTED PURPLE. ALL NORMALLY CLOSED

VALVE LIDS ARE TO BE PAINTED RED. 16. EACH LOT SHALL RECEIVE A 25MM (1") MINIMUM SIZE COPPER POTABLE WATER AND/OR RECYCLED WATER SERVICE. THE LOCATION SHALL BE AS SHOWN ON THESE PLANS AND SHALL BE CONSTRUCTED PERPENDICULAR TO THE CENTERLINE OF THE STREET. "AS CONSTRUCTED" LOCATIONS WITH STATIONS SHALL BE SHOWN ON THESE PLANS BY THE ENGINEER OF WORK PRIOR TO NOTICE OF COMPLETION. 17. WATER METERS SHALL NOT BE PLACED IN DRIVEWAYS OR SIDEWALK. THE LETTER "W" SHALL BE STAMPED IN THE CURB AT ALL WATER LATERAL LOCATIONS. THE LETTER "W" SHALL BE STAMPED IN THE GUTTER WHEN THERE IS NO TYPE AG CURB.

18. BACKFLOW PREVENTION A) A DISTRICT APPROVED REDUCED PRESSURE BACKFLOW PREVENTION DEVICE MUST BE INSTALLED ON THE CUSTOMER'S SIDE OF ALL IRRIGATION METERS SERVED WITH POTABLE WATER, RESIDENTIAL, ALL COMMERCIAL & INDUSTRIAL, MULTI-FAMILY DWELLINGS, PROPERTIES SERVED WITH A SECOND WATER SOURCE SUCH AS WELLS OR RECYCLED WATER, AND ANY OTHER LOCATIONS REQUIRING CROSS-CONNECTION PROTECTION AS OUTLINED IN "TITLE 17" (ISSUED BY THE STATE DEPARTMENT OF PUBLIC HEALTH) AND THE DISTRICT'S CURRENT RULES AND REGULATIONS SECTION 5.4.

B) ALL NEW BACKFLOW PREVENTION ASSEMBLIES SHALL BE INSTALLED ACCORDING TO THE WATER AGENCY STANDARDS (WAS) INSTALLATION DRAWING #WR-01 OR IN ACCORDANCE TO THE ENGINEERING PLANS. AFTER THE BACKFLOW IS INSTALLED, CONTACT THE COMPLIANCE DEPARTMENT TO HAVE THE INSTALLATION INSPECTED. DO NOT COMPLETE ANY BACKFILLING OF THE PIPE OR BACKFLOW PRIOR TO INSPECTION. IF THE ASSEMBLY HAS BEEN BACKFILLED YOU WILL BE REQUIRED TO UNCOVER THE PIPING FROM THE METER BOX TO THE ASSEMBLY.

WORK TO BE DONE:

- STREET IMPROVEMENTS ALONG MISSION GORGE RD AND COTTONWOOD AVE.
- REMOVE AND RELOCATE EXISTING WATER METER REMOVE AND RELOCATE EXISTING BACKFLOW PREVENTER
- 4. REMOVE AND RELOCATE EXISTING FIRE HYDRANT

GENERAL STANDARDS OF CONSTRUCTION

UNLESS OTHERWISE NOTED ON THE PLANS, ALL WORK SHALL CONFORM WITH THE FOLLOWING STANDARD SPECIFICATIONS AND DRAWINGS:

STANDARD SPECIFICATIONS:

- 1. STANDARD SPECIFICATIONS FOR PUBLIC WORKS CONSTRUCTION, LATEST EDITION.
- 2. STANDARD SPECIAL PROVISIONS.
- 3. CITY OF SANTEE PUBLIC WORKS STANDARDS, SEPTEMBER 1982.
- 4. STANDARD SPECIFICATIONS OF THE PADRE DAM MUNICIPAL WATER DISTRICT, WATER AGENCY STANDARDS, W.A.S.
- 5. CALIFORNIA STORMWATER QUALITY ASSOCIATION (CASQA). STORMWATER BEST MANAGEMENT PRACTICE HANDBOOK CONSTRUCTION, LATEST EDITION.
- 6. CALIFORNIA MANUAL OF UNIFORM TRAFFIC CONTROL DEVICES (MUTCD), LATEST

STANDARD DRAWINGS:

- 1. CITY OF SANTEE STANDARD DRAWINGS.
- 2. SAN DIEGO REGIONAL STANDARD DRAWINGS (S.D.R.S.D.) AS RECOMMENDED BY THE REGIONAL STANDARDS COMMITTEE, MAINTAINED AND PUBLISHED BY THE SAN DIEGO COUNTY DEPARTMENT OF PUBLIC WORKS, LATEST EDITION.
- 3. STANDARD DRAWINGS OF THE PADRE DAM MUNICIPAL WATER DISTRICT, WATER AGENCY STANDARDS, W.A.S.

PADRE DAM GENERAL NOTES (CONT'D):

C) ONCE THE ASSEMBLY PASSES INSPECTION YOU WILL NEED TO CALL A CERTIFIED BACKFLOW ASSEMBLY TESTER TO TEST THE DEVICE. A PARTIAL LIST CAN BE FOUND ON THE WEBSITE. COORDINATE THE TEST WITH THE COMPLIANCE DEPARTMENT SO THE METER CAN BE UNLOCKED AT THE SAME TIME AS THE TEST. THE METER WILL NOT BE UNLOCKED BEFORE A PASSING INSPECTION AND A PASSING TEST HAS BEEN


D) PLEASE ENSURE ALL TEST AND OR DEWATERING WATER IS CAPTURED AND CONTAINED ONSITE AS DISCHARGING NON-STORM (WATER NOT SOURCED FROM RAIN) WATER TO THE STORM DRAIN SYSTEM IS AN ILLEGAL DISCHARGE. FOR MORE INFORMATION PLEASE CONSULT YOUR LOCAL GOVERNING AGENCY.

FOR ADDITIONAL INFORMATION, PLEASE CONTACT THE DISTRICT'S COMPLIANCE SPECIALIST AT (619) 258-4731 OR VISIT HTTPS://WWW.PADREDAM.ORG/288/BACKFLOW-TESTING.

19. THE SEWER LATERAL CONNECTION AT PROPERTY LINE IS TO BE INSPECTED AND APPROVED BY THE DISTRICT.

20. EACH LOT WILL BE SERVED BY A 100MM (4") DIAMETER MINIMUM SIZE PVC SEWER LATERAL, LOCATION OF SEWER LATERAL SHALL BE AS SHOWN ON THESE PLANS. "AS CONSTRUCTED" LOCATIONS WITH STATIONS SHALL BE SHOWN ON THESE PLANS BY ENGINEER OF WORK PRIOR TO NOTICE OF COMPLETION BY THE DISTRICT 21. THE LETTER "S" SHALL BE STAMPED IN THE CURB AT ALL SEWER LATERAL LOCATIONS. THE LETTER "S" SHALL BE STAMPED IN THE GUTTER WHEN THERE IS NO TYPE AG CURB.

- 1. VIBRATORY ROLLERS AND LARGE BULLDOZERS WILL NOT BE UTILIZED WITHIN 25 FEET OF THE RESIDENTIAL STRUCTURES TO THE NORTH. SMALL BULLDOZERS WILL BE UTILIZED WITHIN THIS AREA TO MAKE IMPROVEMENTS TO THE EXISTING ALLEY AND TO THE
- 2. PERSON SHALL ENGAGE IN CONSTRUCTION OR DEMOLITION ACTIVITIES IN A MANNER THAT DISCHARGES VISIBLE DUST EMISSIONS INTO THE ATMOSPHERE BEYOND THE PROPERTY LINE FOR A PERIOD OR PERIODS AGGREGATING MORE THAN 3 MINUTES IN ANY 60 MINUTE PERIOD.

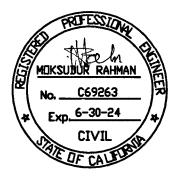


NOTE: RESOLUTION 140-2022


PROJECT SITE IN GENERAL.



LEGEND

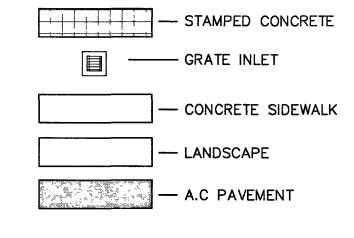

DESIGNED BY REVIEWED 5/10/24 CITY OF SANTEE DEPARTMENT OF DEVELOPMENT SERVICES CITY WO NO DRAWING NO HE BENCHMARK FOR THIS SURVEY IS STATION #2107 PER RECORD **MR F SURVEY NO. 11252. A STANDARD STREET WELL MONUMENT WITH 2023-190 BRASS DISC MARKED "SD CO ENGR DEPT SURV MON," LOCATED AT THE INTERSECTION OF MISSION GORGE ROAD AND COTTONWOOD AVE, Rhitsaal PLANS PREPARED UNDER THE SUPERVISION OF 03/27/2014 POPEYES FAST FOOD RESTAURANT MOKSUDUR RAHMAN EXPIRES 6/30/24 ELEVATION = 349.74 FEET (NGVD 29) SHEET 2 OF 6

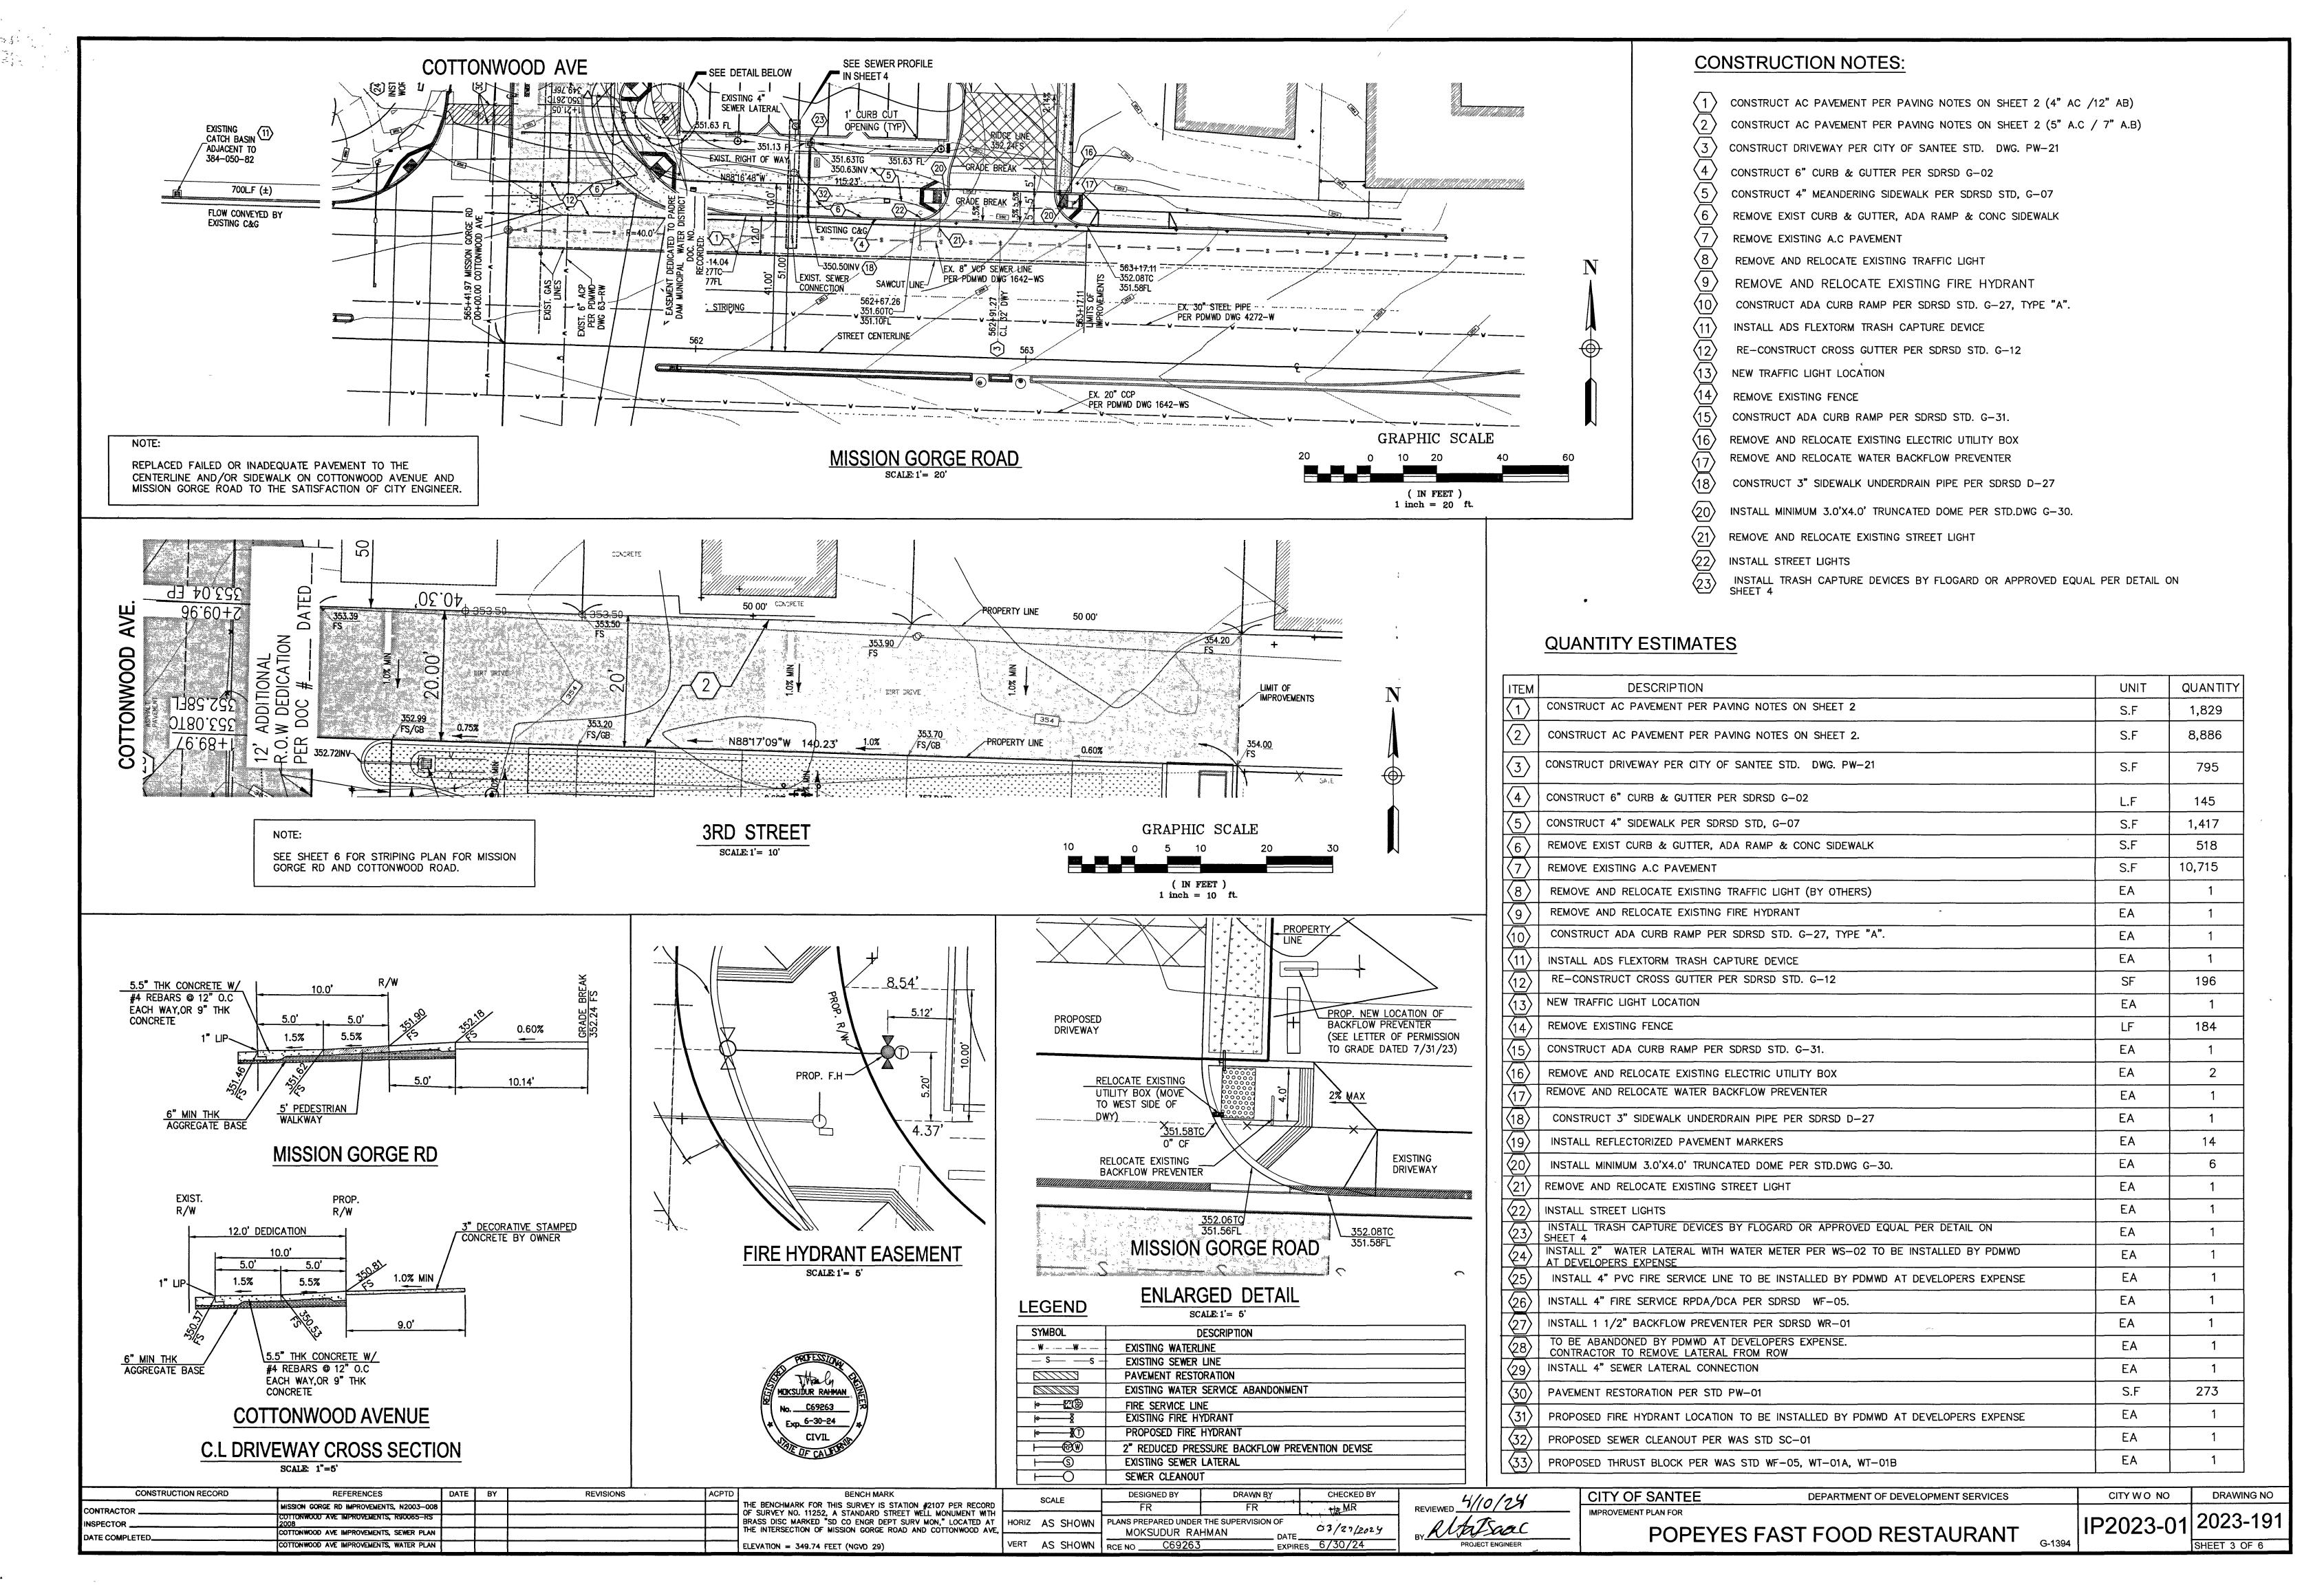

1.

ADDITIONAL FUTURE IMP. 1+00.00 COT 561+4197 M (350.52 CL) EXIST. FIN SURFACE O ST. C.L -8:<u>\$</u>-8: TO PROP. NEW FIN. SURFACE WATER LOCATION OF Ø ST. C.L 1.0% 3.46% 2,0% EXIST FIN. SURFACE FIRE HYDRANT PROFIL 3.5' HIGH SCREEN WALL ADDITIONAL PROP. MEANDERING FUTURE IMP DEDICATION PROJECT SHE `\EXIST. CURB & EXIST SEWER LATERAL WITHIN 1.0' MIN CLEARANCE ROW TO BE ABANDONED AND REMOVED BY PDMWD AT EXIST. SEWER TO BE PROP. 4" SEWER DEVELOPER'S EXPENSE. PROP. C&G ¬ LATERAL @ 2% MIN PROP SEWER CLEANOUT PER WAS / STD. SC-01, TYPE B SLOPE PDMWD TO INSTALL NEW 4" SEWER LATERAL PER WAS SS-01 FROM THE CONNECT TO NEW POWWD NOTE: CONTRACTOR TO POTHOLE 4 348.85IE X. 6" ACP MAIN TO THE ROW. SEWER LATERAL INV TO ACCURATELY CONFIRM FIRE LINE @ 1% HDRIZ 1"=20'LOCATION OF EXISTING SEWER SEWER MIN. SLOPE WATER 4" SEWER PROFILE CHIMNEY & LATERAL VERT 1"=20' SCALE: 1" + 5' SEWER MAIN **CONSTRUCTION NOTES:** × PROVIDE TRANSITIONAL PAVEMENT AS NECESSARY 24 1+41.39 PER PDMWD DWG 1791 TO ESTABLIHED NEW CENTERLINE CROWN. CONSTRUCT AC PAVEMENT PER PAVING MOTES ON SHEET 2 (4" AC /12" AB) INSTALL 2" COPPER WATER SERVICE. WORK TO BE COMPLETED BY PDWMD CONSTRUCT AC PAVEMENT PER PAVING NOTES ON SHEET 2 (5" A.C / 9" A.B) EXIST. R.O.W O DEVELOPERS EXPENSE DEVELOPERS EXPENSE


25) 1+37.59 PER PDMWD DWG 1791

INSTALL 4" FIRE SERVICE. WORK

TO BE COMPLETED BY PDWMD 6

DEVELOPERS EXPENSE CONSTRUCT DRIVEWAY PER CITY OF SANTEE STD. DWG. PW-21 9 CONSTRUCT 6" CURB & GUTTER PER SDRSD G-02 DEVELOPERS EXPENSE _565+41.97 MISSION GORGE RD CONSTRUCT 4" SIDEWALK PER SDRSD STD, G-07 00+00.00 COTTONWOOD AVE PER PDMWD REMOVE EXIST CURB & GUTTER, ADA RAMP & CONC SIDEWALK 1+00 SAWCUT LINE-XST. CENTERLINE— 🗶 REMOVE EXISTING A.C PAVEMENT 3+00 REMOVE AND RELOCATE EXISTING TRAFFIC LIGHT 9 REMOVE AND RELOCATE EXISTING FIRE HYDRANT CONSTRUCT ADA CURB RAMP PER SDRSD STD. G-27, TYPE "A". PER PDMWD-EXIST. EDGE OF DWG 63-RW R.O.W DEDICATION REMOVE AND RELOCATE EXISTING UTILITY BOXES A,C PAVEMENT PER DOC #____ DATED_ RE-CONSTRUCT CROSS GUTTER PER SDRSD STD. G-12 GRAPHIC SCALE 50' PVMT. TRANSITION NEW TRAFFIC LIGHT LOCATION EASEMENT DEDICATED TO PADRE REMOVE EXISTING FENCE DAM MUNICIPAL WATER DISTRICT CONSTRUCT ADA CURB RAMP PER SDRSD STD. G-31 RECORDED: (IN FEET) 1 inch = 20 ft.REMOVE AND RELOCATE EXISTING WATER METER 3RD STREET COTTONWOOD AVENUE REMOVE AND RELOCATE WATER BACKFLOW PREVENTER - OPTIONAL FOSSIL ROCK f FILTER FRAME -INSTALL REFLECTORIZED PAVEMENT MARKERS ABSORBANT POUCHES. INSTALL MINIMUM 3.0'X4.0' TRUNCATED DOME PER STD.DWG G-30. SPECIFIER CHART REMOVE AND RELOCATE EXISTING STREET LIGHT STANDARD & SHALLOW STANDARD DEPTH SHALLOW DEPTH RUBBER GASKET DEPTH -12 Inches-INSTALL STREET LIGHT BY OTHERS MODEL NO. MODEL NO (Data in these columes is the same for STANDARD = 20 INCHboth STANDARD & SHALLOW versions) REMOVABLE-INSTALL TRASH CAPTURE DEVICES BY FLOGARD OR APPROVED EQUAL PER DETAIL HEREON SHALLOW = 12 INCHES GRATE FRAME STANDARD LINER SOLIDS | FILTERED SOLIDS FILTERED TOTAL INLET ID GRATE OD DEPTH DEPTH STORAGE | FLOW STORAGE FLOW inside_ BYPASS INSTALL 2" WATER LATERAL WITH WATER METER PER WS-02 TO BE INSTALLED BY PDMWD Outside CAPACITY CAPACITY Dimension CAPACITY Dimension AT DEVELOPERS EXPENSE SUPPORT (inch x inch) | (inch x inch) | (cu ft / sec) (cu ft) (cu ft) (cu ft/sec BASKET INSTALL 4" PVC FIRE SERVICE LINE TO BE INSTALLED BY PDMWD AT DEVELOPERS EXPENSE FGP-18F 0 7 | FGP-18F8 PAVEMENT SURFACE -18 X 18 | 18 X 20 47 0 8 45 4 INSTALL 4" FIRE SERVICE RPDA/DCA PER WF-05. **LEGEND** INSTALL 1 1/2" BACKFLOW PREVENTER PER WR-01 OUTFLOW TO BE ABANDONED BY PDMWD AT DEVELOPERS EXPENSE. SYMBOL DESCRIPTION CONTRACTOR TO REMOVE LATERAL FROM ROW CONCRETE DROP INLET.-**EXISTING WATERLINE** -M- -- M- --PAVEMENT RESTORATION PER STD PW-01 EXISTING SEWER LINE PROPOSED FIRE HYDRANT PER WF-01 AND WF-04 TO BE PAVEMENT RESTORATION 4. MAY . 4 MUKSUDUR RAHHAN INSTALLED BY PDMWD AT DEVELOPERS EXPENSE EXISTING WATER SERVICE ABANDONMENT CONSTRUCT THRUST BLOCK PER WAS STD WF-05, WT-01A, WT-01B FIRE SERVICE LINE **GRATE INLET W/ TRASH** No. <u>C69263</u> EXISTING FIRE HYDRANT Exp. 6-30-24 REPLACED FAILED OR INADEQUATE PAVEMENT TO THE **CAPTURE INSERT DETAIL** PROPOSED FIRE HYDRANT CENTERLINE AND/OR SIDEWALK ON COTTONWOOD AVENUE AND CIVIL **├**₩ 2" REDUCED PRESSURE BACKFLOW PREVENTION DEVISE MISSION GORGE ROAD TO THE SATISFACTION OF CITY ENGINEER. ├-----S EXISTING SEWER LATERAL **CONSTRUCTION RECORD** REFERENCES REVISIONS CITY WO NO DRAWING NO DESIGNED BY DRAWN BY CHECKED BY REVIEWED 4/10/24 CITY OF SANTEE DEPARTMENT OF DEVELOPMENT SERVICES THE BENCHMARK FOR THIS SURVEY IS STATION #2107 PER RECORD OF SURVEY NO. 11252, A STANDARD STREET WELL MONUMENT WITH MISSION GORGE RD IMPROVEMENTS, N2003-008 IP2023-01 2023-192 BRASS DISC MARKED "SD CO ENGR DEPT SURV MON," LOCATED AT HORIZ 1" = 20" OTTONWOOD AVE IMPROVEMENTS, R90065-RS PLANS PREPARED UNDER THE SUPERVISION OF Rhatsaac NSPECTOR . 03/27/2024 HE INTERSECTION OF MISSION GORGE ROAD AND COTTONWOOD AVE, POPEYES FAST FOOD RESTAURANT MOKSUDUR RAHMAN COTTONWOOD AVE IMPROVEMENTS, SEWER PLAN DATE COMPLETED. EXPIRES 6/30/24 VERT 1" = 20'COTTONWOOD AVE IMPROVEMENTS, WATER PLAN ELEVATION = 349.74 FEET (NGVD 29) SHEET 4 OF 6

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TRAFFIC SIGNAL GENERAL NOTES:

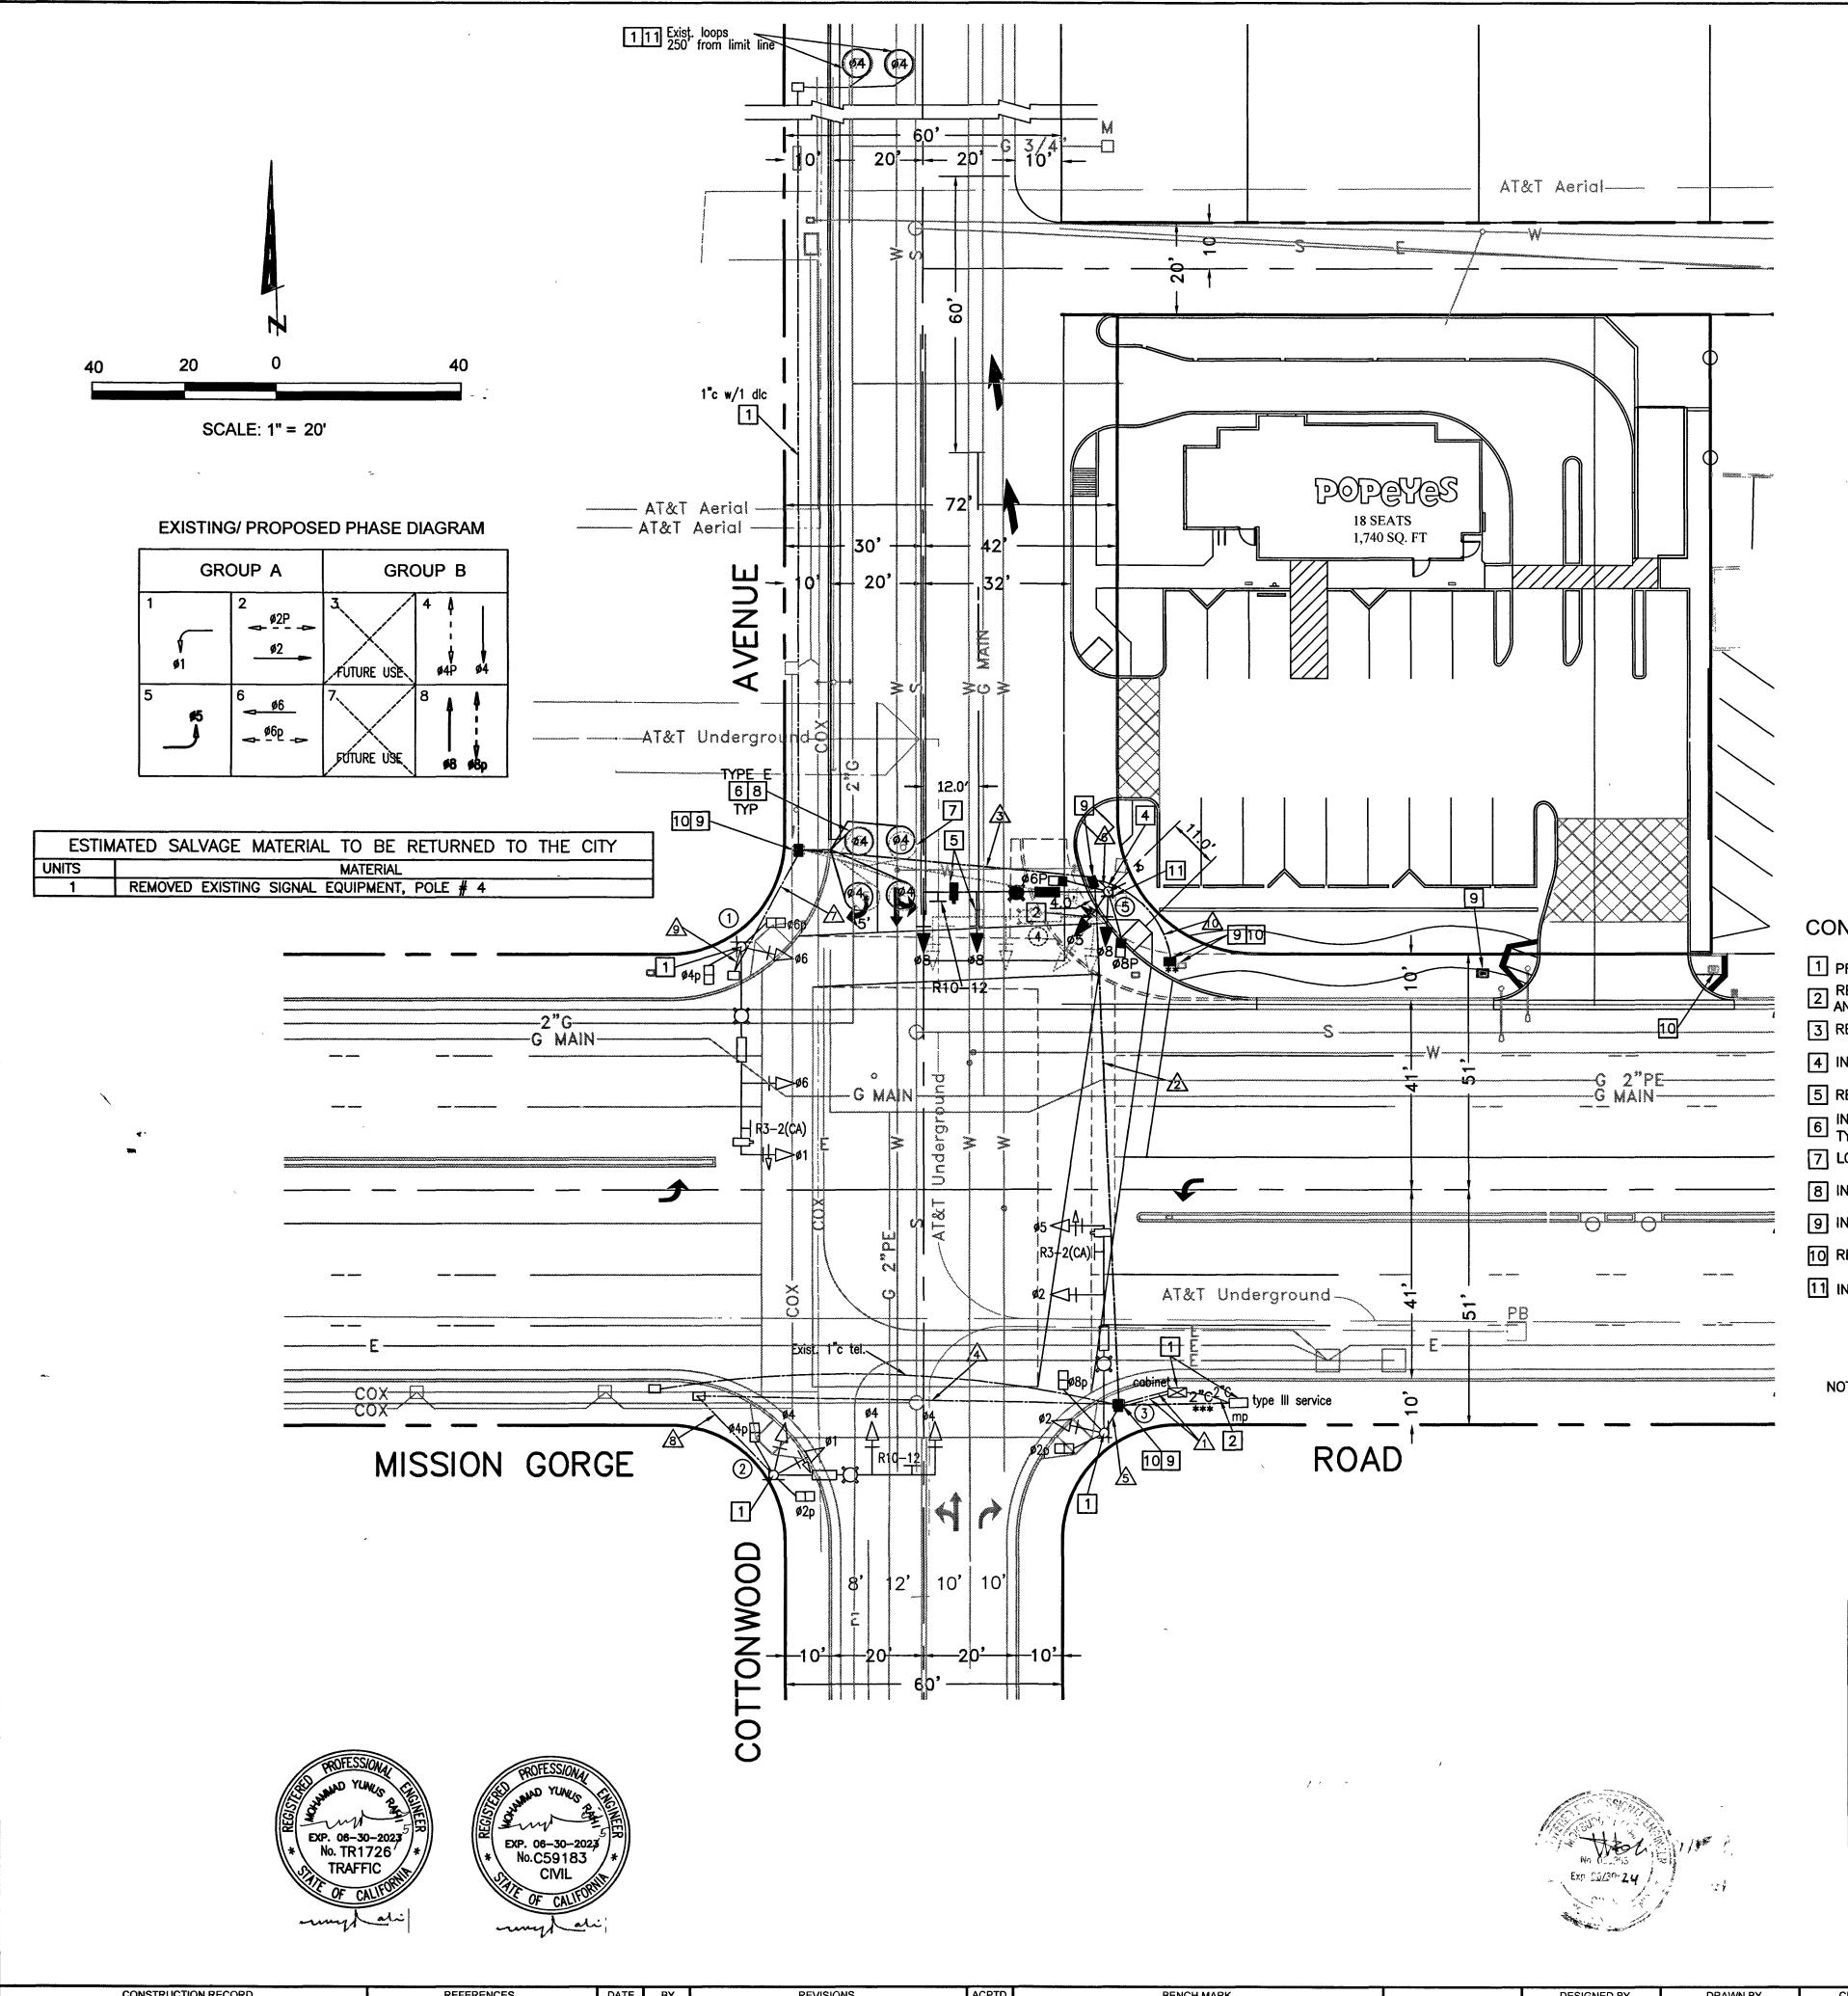- 1. TRAFFIC SIGNAL AND LIGHTING WORK SHALL CONFORM TO THE STATE OF CALIFORNIA STANDARD SPECIFICATIONS SECTION 86, CALTRANS STANDARD PLANS (LATEST EDITION), THE PROJECT SPECIAL PROVISIONS, AND THE CALIFORNIA MANUAL OF UNIFORM TRAFFIC CONTROL DEVICES, LATEST EDITION.
- 2. LOCATIONS OF ALL UNDERGROUND UTILITIES ARE APPROXIMATE. THE CONTRACTOR SHALL DETERMINE THE EXACT LOCATION BY POTHOLING AS NECESSARY, AND VERIFY ALL CONDITIONS ON THE JOB SITE. HAND DIG ALL FOUNDATIONS UNTIL CLEAR OF
- 3. CONDUCTOR SCHEDULE IS FURNISHED AS AN INSTALLATION GUIDE ONLY. IT SHALL BE THE CONTRACTOR'S RESPONSIBILITY TO PROVIDE THE CORRECT CONDUCTORS/CABLES REQUIRED FOR THE INTENDED OPERATION SHOWN IN THE PHASE DIAGRAM. 4. OBTAIN APPROVAL FROM THE CITY TRAFFIC ENGINEER FOR EXACT EQUIPMENT LOCATIONS PRIOR TO FINAL PLACEMENT. ALL STRIPING SHALL BE PERFORMED PRIOR TO LOCATING LOOP DETECTORS.
- 5. A PRE-CONSTRUCTION MEETING SHALL BE HELD PRIOR TO BEGINNING WORK. REPRESENTATIVES OF THE CITY, UTILITY COMPANIES AND CONTRACTOR SHALL ATTEND.
- 6. THE CONTRACTOR SHALL NOT ERECT ANY SIGNAL STANDARD MORE THAN TWO (2) WEEKS PRIOR TO THE SCHEDULED TRAFFIC SIGNAL TURN-ON UNLESS APPROVED BY THE CITY TRAFFIC ENGINEER.
- 7. COORDINATE SERVICE DETAILS AND SCHEDULING WITH SAN DIEGO GAS & ELECTRIC (SDG&E) WELL IN ADVANCE OF NEED. IT SHALL BE THE CONTRACTOR'S RESPONSIBILITY TO VERIFY THE LOCATION TO MAKE ARRANGEMENTS FOR AND TO PAY FOR ALL COSTS INCLUDING SERVICE LOCATION INITIATION FEES, TO PROVIDE THE NECESSARY CONNECTION FOR THE TRAFFIC SIGNAL AND LIGHTING
- 8. AN ELECTRICAL PERMIT SHALL BE OBTAINED FROM THE BUILDING DIVISION PRIOR TO INSTALLATION OF THE TRAFFIC SIGNAL. 9. THE CONTRACTOR SHALL IMMEDIATELY HAUL AWAY AND DISPOSE OF, OFF THE PROJECT SITE, ALL REMOVED CONCRETE, ASPHALT CONCRETE, BASE MATERIALS, EXCESS EXCAVATED MATERIAL AND CONSTRUCTION DEBRIS. ALL DISPOSALS SHALL BE AT THE
- CONTRACTOR'S EXPENSE. 10. ALL SALVAGE EQUIPMENT SHALL BE DELIVERED TO THE CITY MAINTENANCE YARD FACILITY.
- 11. THE CONTRACTOR SHALL BE RESPONSIBLE FOR DAMAGE TO EXISTING UTILITIES, PAVEMENT AND PAVEMENT MARKINGS, CURBS, STRUCTURES, LANDSCAPING AND IRRIGATION SYSTEMS, AS A RESULT OF HIS/HER OPERATIONS, AND WILL BE REQUIRED TO REPAIR, REPLACE SAME TO THE SATISFACTION OF AND AS DIRECTED BY THE ENGINEER OR UTILITY COMPANY.
- 12. ALL CONDUIT DEPTH MUST BE A MINIMUM OF 30" BELOW THE PAVEMENT SURFACE. 13. ALL NEW WIRING SHALL BE LABELED WITHIN EACH PULLBOX AND CONTROLLER CABINET FOR PHASE AND/OR USE IDENTIFICATION.
- 14. UNDERGROUND WIRING SHALL BE SPLICED IN PULLBOXES ONLY.
- 15. PROVIDE 4' MINIMUM CLEAR WIDTH IN SIDEWALK AROUND POLE FOR DISABLED ACCESS. 16. ANCHOR BOLT COVERS SHALL BE PROVIDED FOR ALL STANDARDS
- 17. PEDESTRIAN SIGNALS SHALL BE SOLID LED WITH COUNTDOWN TIMER. ALL PEDESTRIAN PUSH BUTTON SIGNS SHALL DISPLAY
- INTERNATIONAL "WALKING PERSON" SYMBOL AND DIRECTIONAL ARROW. 18. THE PUSHBUTTONS SHALL BE AN AUDIBLE PUSHBUTTON SYSTEM (POLERA I-NAVIGATOR IN2 SYSTEM OR APPROVED EQUAL).
- 19. ALL POLES SHALL BE A MINIMUM OF 5' FROM THE FACE OF THE CURB. 20. CONDUITS SHALL BE (3" PVC (SCHEDULE 40) UNLESS NOTED ON PLANS
- 21. THE CONTROLLER FOUNDATION SHALL HAVE A SPARE 3" CONDUIT STUBBED OUT TO ADJACENT NO. 6 PULL BOX FOR FUTURE
- 22. ALL PULL BOXES SHALL BE NO. 6 EXCEPT AS NOTED. PULL BOX COVERS SHALL BE MARKED WITH "TRAFFIC SIGNAL". NO PULL BOX SHALL BE INSTALLED WITHIN 1'OF PEDESTRIAN RAMP UNLESS AUTHORIZED BY ENGINEER.
- 23. TRENCH PATCH FOR CONDUIT RUNS SHALL BE DONE IN ACCORDANCE WITH THE CITY'S STANDARD DRAWINGS PW-01 AND PW-02.
- 24. SIGN PANELS FOR THE INTERNALLY ILLUMINATED STREET NAME SIGNS SHALL BE DIAMOND GRADE VINYL REFLECTIVE SHEETING OR EQUIVALENT. SIGN PANELS SHALL HAVE BLUE BACKGROUND WITH WHITE LETTERS AND THE CITY OF SANTEE LOGO. CONTACT CITY STAFF FOR SIGN PANEL SPECIFICATION. IISNS SHALL HAVE PRINCE LED LIGHT BULBS.
- 25. ALL SIGNAL INDICATIONS SHALL BE 12" IN DIAMETER LED (ITE SPECIFICATION) WITH BACKPLATE AND 3" REFLECTIVE 3M YELLOW TAPE AROUND THE ENTIRE BACKPLATE.

CONSTRUCTION NOTES:

- 1 PROTECT IN PLACE TRAFFIC SIGNAL EQUIPMENTS/ CONDUITS/ LOOPS.
- REMOVE TRAFFIC SIGNAL EQUIPMENT, FOUNDATION, PULL BOX, AND ABANDONED CONDUIT(S).
- 3 RESTRIPING TO BE DONE BY THE CONTRACTOR IN ACCORDING TO STRIPING DRAWING.
- 4 INSTALL TRAFFIC SIGNAL EQUIPMENT, INCLUDING FOUNDATION, COMDUITS AND PULL BOXES.
- 5 RELOCATE VIDEO DETECTION CAMERA FROM EXISTING POLE MAST ARM.
- 6 INSTALL TRAFFIC SIGNAL LOOPS PER CALTRANS STANDARD DWG. NO. ES-5B, TYPE PER PLAN.
- 7 LOOPS TO BE ABANDONED.
- 8 INSTALL SEPARATE DLC PAIR FOR CURB LANE LOOP(S).
- 9 INSTALL PULL BOX NO. 6 PER CALTRANS STANDARD DWG. NO. ES-8A.
- 10 REMOVE/ RELOCATE EXISTING PULL BOX.
- 11 INSTALL TWO PUSH BUTTONS ON SOUTH AND EAST SIDES OF THE POLE.
- NOTES: EXACT LOCATION OF ALL SHOWN UTILITIES IS THE RESPONSIBILITY OF THE CONTRACTOR TO VERIFY.
 - ** CONTRACTOR WILL VERIFY ON SITE THAT PULL BOX IS A MID RUN TRAFFIC SERVICE BOX AND CONDUIT WILL BE CONNECTED THROUGH.
 - *** MODIFY THE POWER, STREET LIGHTING AND IISNS WIRES TO GO DIRECTLY INTO THE PULL BOX AS SHOWN BY INSTALLING NEW 2" CONDUIT, ABANDON THE EXISTING ONE.
 - THE POWER WIRE GOES FROM THAT PULL BOX TO

THE CABINE	1

AWG SIZE	4	OLDOLUT					RUN	NO				
AWG SIZE	Ø	CIRCUIT	Λ	*2	*3	12 12 12 12 12 12 12 2 2 2 2 2 2 2 1	8	<u></u>	*/0			
508		POLE (1)	1/2	*1/2	1/2				1/2		1/2	
2000		POLE (2)	1/2			1/2				1/2		
100 Color		POLE (3)	1/2				1/2					
C. J. J. J. J.		POLE (5)	1/2	*1/2				*1/2				
COMPCAR												
TOTAL CABLE	3 (CONDUCT./12 CONDUCT.	4/8	24	1/2	1/2	1/2	1/2	12	12	12	
#10		I.I.S.N.S.		2	2	2		2	2	2	2	
#10		LUMINAIRES		*2	2	2		2	2	2	2	
		TOTAL #10		4	*4	4		4	4	4	4	
# 8		GROUND	2	2	2	2	2	2	2	2	2	
# 6		SIGNAL SERVICE	2									
		OPTICOM WIRE	1	1	1	1	1	1	1	1	1	
2#16 TYPE B DCL	ø4		1	1	1							*
		POLE 5 *VIDEO CAMERA	*1	*1				*1				
SIAMESA		POLE 1 VIDEO CAMERA	1	1	1				1		1	
CABLING		POLE 3 VIDEO CAMERA	1									
		TOTAL VIDEO CABLE	3	2	1			*	1		1	
		CONDUITS	2-3"	3"	3*	3"	2"	2"	2"	2"	2"	*2"
		ACTUAL FILLING %	16	20	12	10	21	25	25	22	22	2


CONDUCTOR SCHEDULE A

* NEW

	POLE SCHEDULE												
1		STANDARD TYPE			LUMINAIRE		ED. I BUTT	PUSH ON	SIGNAL MOU	NTING	STREET NAME SIGN	NOTES	
POLE		HEIGHT	SIGNAL M.A.	LUM. M.A.	HPS V.	TYPE	ø	QUAD	VEHICLE	PEDESTRIAN	MESSAGE I.I.S.N.S.	NOTES	
1	26-4-70	30	45	15	150W	B/B	4/6	N/w	MAS SV-2T	SP-2T	COTTONWOOD	PROTECT IN PLACE	
2	24-4-70	30	35	15	150W	B∕B	2/4	S/W	MAS SV-2T	SP-2T	MISSION GORGE	PROTECT IN PLACE	
3	26-4-70	30	45	15	150W	B/B	2/8	S/E	MAS SV-2T	SP-2T	COTTONWOOD	PROTECT IN PLACE	
(4)	24-4-70	30	35	15	150W	8/B	8/2	ŊΈ	MAS SV-2T	SP-2T	MISSION GORGE	TO BE REMOVED	
(5)	26-4-100	30	40	15	*111W LED	B/B	8/6	ŊΈ	MAS SV-2T	SP-2T	MISSION GORGE	NEW- SEE PLAN FOR LOCATION	

*111W LED GE MODEL ERLH-0-13-C3-40-A-GRAY-L


CONSTRUCTION RECORD	REFERENCES	DATE BY	REVISIONS	ACPTD	BENCH MARK	SCALE	DESIGNED BY	DRAWN BY	CHECKED BY	Alu InV	CITY OF SANTEE	DEPARTMENT OF DEVELOPMENT SERVICES	CITY W O NO	DRAWING NO
CONTRACTOR	MISSION GORGE RD IMPROVEMENTS, N2003-00				THE BENCHMARK FOR THIS SURVEY IS STATION #2107 PER RECORD OF SURVEY NO. 11252. A STANDARD STREET WELL MONUMENT WITH	SCALE	FR	FR	MR	REVIEWED	IMPROVEMENT PLAN FOR			
INSPECTOR	COTTONWOOD AVE IMPROVEMENTS, R90065-RS	5			BRASS DISC MARKED "SD CO ENGR DEPT SURV MON," LOCATED AT HOR	RIZ AS SHOWN	PLANS PREPARED UNDER	THE SUPERVISION OF		Ryatsaap			IP2023-0	1 2 2 2 3 - 1 9 3
DATE COMPLETED	COTTONWOOD AVE IMPROVEMENTS, SEWER PLA	И			THE INTERSECTION OF MISSION GORGE ROAD AND COTTONWOOD AVE,		MOKSUDUR RAH	MAN DATE	03/27/2024	BY	POPEYES	S FAST FOOD RESTAURANT	11 2023-0	
	COTTONWOOD AVE IMPROVEMENTS, WATER PLA	N			ELEVATION = 349.74 FEET (NGVD 29)	T AS SHOWN	RCE NO	EXPIR	RES 6/30/24	PROJECT ENGINEER	1 0 2 2 2		G-1394	SHEET 5 OF 6

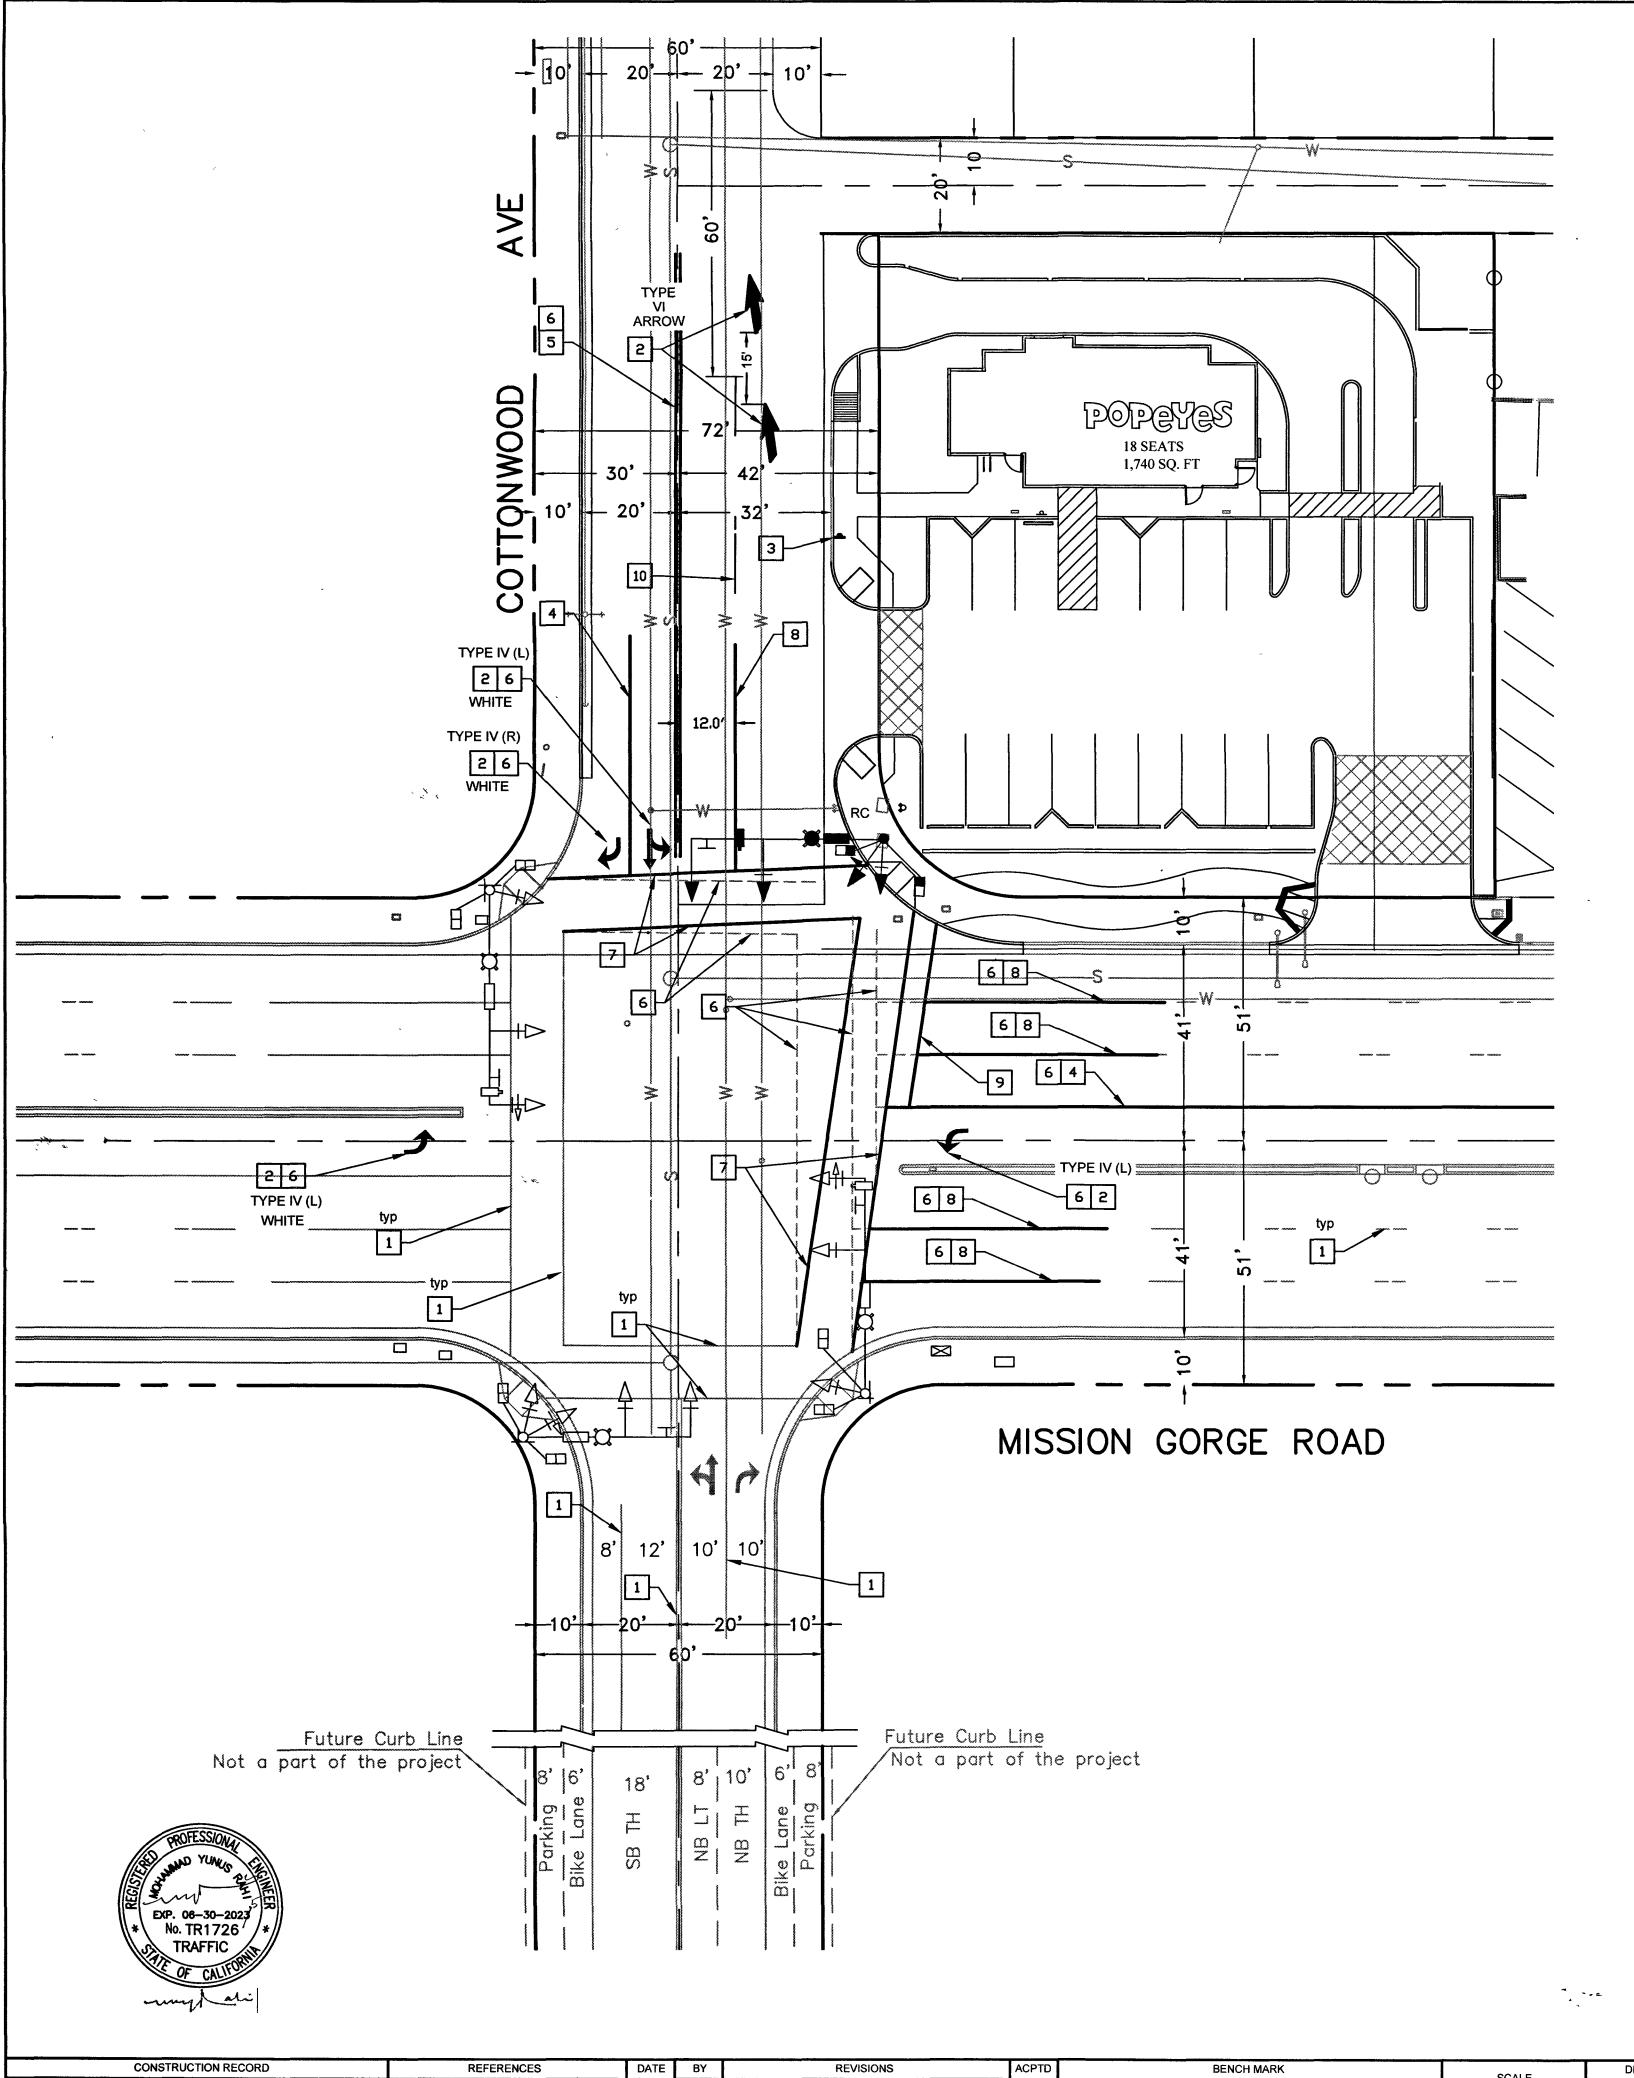

SIGNING AND STRIPING CONSTRUCTION NOTES


- 1 PROTECT EXISTING STRIPING/LEGEND IN PLACE.
- INSTALL PAVEMENT MARKING ARROWS PER CALTRANS STD. PLAN NO. A24A. TYPE AND COLOR PER PLAN.
- 3 -INSTALL LANE MERGE W4-2 SIGN.
- INSTALL CHANNELIZING LINE PER CALTRANS STD. PLAN NO. A20D,
- INSTALL 4-INCH DOUBLE YELLOW STRIPING PER CALTRANS STD. PLAN NO. A20A, DETAIL 22.
- 6 SANDBLAST CONFLICTING STRIPING BY WET SANDBLASTING.
- INSTALL BASIC CROSSWALK PER CALTRANS REVISED STD. PLAN NO. A24F.
- 8-INSTALL 50 FEET OF 4-INCH WHITE SOLID STRIPING PER DETAIL "A".
- INSTALL 12-INCH WIDE SOLID WHITE LIMIT LINE PER CALTRANS REVISED STD. PLAN NO. A24E.
- INSTALL 4-INCH WHITE LANE LINE PER CALTRANS STD. PLAN NO. A20A, DETAIL 9.

NOTE: EXACT LOCATION OF ALL SHOWN UTILITIES IS THE RESPONSIBILITY OF THE CONTRACTOR TO VERIFY.

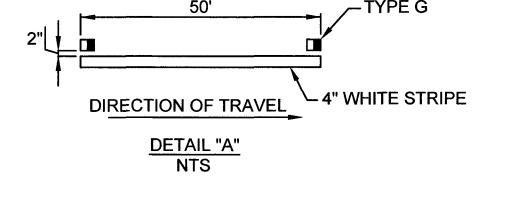

STRIPING AND SIGNAGE GENERAL NOTES

- 1. THE METHOD OF PAVEMENT AND MARKER INSTALLATION SHALL CONFIRM TO SECTION 84 AND 85 OF CALTRANS LATEST STANDARD SPECIFICATIONS OR AS REQUIRED BY LOCAL JURISDICTION.
- 2. NO MARKING TO BE DONE PRIOR TO FIELD INSPECTION AND APPROVAL OF LAYOUT BY CITY IN THE FIELD.
- 3. PAVEMENT MARKING SHALL BE THERMOPLASTIC MATERIALS AND SHALL CONFIRM TO SECTION 84-2 02 CALTRANS STANDARD SPECIFICATION OF AS REQUIRED BY LOCAL JURISDICTION.
- 4. THE APPLICATION OF THERMOPLASTIC MATERIALS SHALL BE IN ACCORDING WITH CALTRANS STANDARD SPECIFICATION SECTION 84-2.04 OR AS REQUIRED BY LOCAL JURISDICTION.
- 5. PAVEMENT DELINEATION PATTERNS SHALL CONFORM TO THE DETAILS IN THE CALTRANS STANDARD PLAN A20A, A20B, A20C, AND A20E. ARROW SYMBOLS SHALL BE WHITE UNLESS SPECIFIED IN THE PLANS AND CA MUTCD LATEST EDITION.
- 6. PAVEMENT ARROW IN FRONT OF A TURN LANE SHALL BE PLACED APPROXIMATELY 10 FEET FROM THE LIMIT LINE AND THE ARROW AT THE BACK OF A TURN LANE SHALL BE PLACED APPROXIMATELY 5 FEET FROM THE END WHERE THE VEHICLE ENTERS THE LANE.
- BEYOND RESURFACING LIMITS, ALL THE CONFLICTING MARKINGS, PAINTED SYMBOLS, AND RAISED PAVEMENT MARKERS SHALL BE REMOVED BY WET SAND BLASTING OR AS REQUIRED BY LOCAL JURISDICTION.
- 8. ALL EXISTING SIGNS AND POSTS NOT TO BE USED SHALL BE REMOVED.
- 9. RELOCATED OR NEW SIGNS AS SHOWN ON PLANS SHALL BE INSTALLED ON NEW POST, EXCEPT WHERE STREET LIGHT POLES ARE USED FOR SIGN POSTING, NEW SIGN POSTS SHALL BE UNISTRUT BREAK AWAY TYPE, 2-INCH SQUARE TUBE.
- 10. ALL TRAFFIC SIGN SHALL HAVE RETRO REFLECTIVE SHEETING AND SHALL CONFORM TO THE LATEST CALTRANS STANDARD PLANS AND SPECIFICATION AND THE LATEST CALIFORNIA SIGN SPECIFICATION, ALL SIGN SHALL BE INSTALLED ACCORDING WITH CALTRANS STANDARD PLANS AND SPECIFICATIONS OR AS REQUIRED BY LOCAL JURISDICTION.
- 12. NO SIGN SHALL BE INSTALLED PRIOR TO FIELD INSPECTION AND APPROVAL OF LAYOUT BY THE CITY IN THE FIELD.
- 13. SIZES OF WARNING SIGNS SHALL BE AS SHOWN IN CA MUTCD, TABLE 2C-2. THE ADVANCE PLACEMENT DISTANCE OF WARNING SIGNS SHALL BE AS SHOWN IN THE CA MUTCD, TABLE 2C-4.
- 14. ALL TEMPORARY STRIPING AND MARKINGS SHALL BE TEMPORARY TRAFFIC STRIPE (PAINT) AND SHALL CONFORM TO CALTRANS STANDARD PLANS EXACT LOCATIONS OF TEMPORARY STRIPING, MARKINGS AND SIGNS SHALL BE DETERMINED BY THE CITY ENGINEER.
- 15. CONTRACTOR SHALL INSTALL TEMPORARY PORTABLE CHANGEABLE MESSAGE SIGNS AS SHOWN ON APPROVED TRAFFIC CONTROLLER PLAN.
- 16. THE CONTRACTOR SHALL HAVE ALL TEMPORARY DELINEATORS, BARRICADES, ETC., PROPERLY INSTALLED PRIOR TO COMMENCEMENT OF CONSTRUCTION.
- 17. EXACT LOCATION AND TYPE OF CONSTRUCTION SIGNS SHALL BE AS APPROVED ON TRAFFIC CONTROL PLAN AND ADJUSTED AS NEEDED BY THE CITY ENGINEER BASED UPON CONSTRUCTION CONDITIONS.

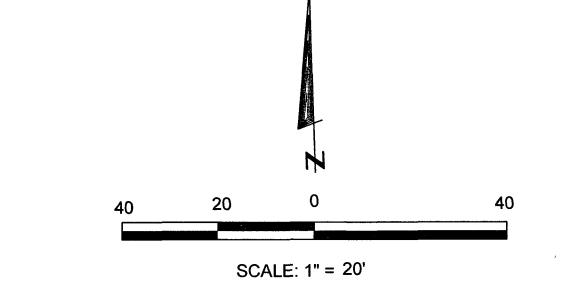



CONSTRUCTION RECORD	REFERENCES	DATE BY	REVISIONS	ACPTE	BENCH MARK	SCALE	DESIGNED BY	DRAWN BY	CHECKED BY	4/10/24	CITY OF SANTEE	DEPARTMENT OF DEVELOPMENT SERVICES	CITY WO NO	DRAWING NO
CONTRACTOR	MISSION GORGE RD IMPROVEMENTS, N2003-008 COTTONWOOD AVE IMPROVEMENTS, R90065-RS	8			THE BENCHMARK FOR THIS SURVEY IS STATION #2107 PER RECORD OF SURVEY NO. 11252, A STANDARD STREET WELL MONUMENT WITH BRASS DISC MARKED "SD CO ENGR DEPT SURV MON," LOCATED AT	HORIZ AS SHOWN	FR PLANS PREPARED UNDE	FR ** R THE SUPERVISION OF	MR	REVIEWED 710/C	IMPROVEMENT PLAN FOR		IP2023-01	1 2023-194
DATE COMPLETED	COTTONWOOD AVE IMPROVEMENTS, SEWER PLAN	4			THE INTERSECTION OF MISSION GORGE ROAD AND COTTONWOOD AVE,		MOKSUDUR RAH	IMAN DATE	27/2024	BY WAGSOUC	l POPEYES	FAST FOOD RESTAURANT		
	COTTONWOOD AVE IMPROVEMENTS, WATER PLAN	1			ELEVATION = 349.74 FEET (NGVD 29)	VERT AS SHOWN	RCE NO	EXP!3	RES 6/30/24	PROJECT ENGINEER	. 0. 2. 20	.,,	G-1394	SHEET 6 OF 6

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